## California High-Speed Rail Authority



RFP No.: HSR 14-32


# Request for Proposals for Design-Build Services for Construction Package 4

# Reference Material, Part B.3 PE4P Composite Utility Plans

Note: Southern limit of CP4 ends just north of Poplar Ave, at approximately station WS1 5880+00, even though this document shows the limit just north of 7th Standard Road. Work south of the contract limit of WS1 5880+00 should not be considered as part of the contract

## CALIFORNIA HIGH-SPEED TRAIN

**Engineering Drawings** 

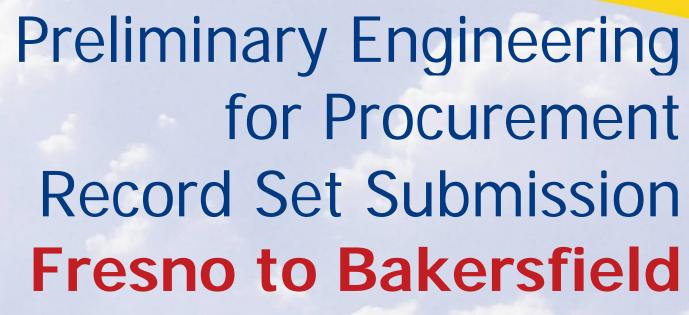


Sierra Subdivision Construction Package 4 Composite Utility Plans

September 2014





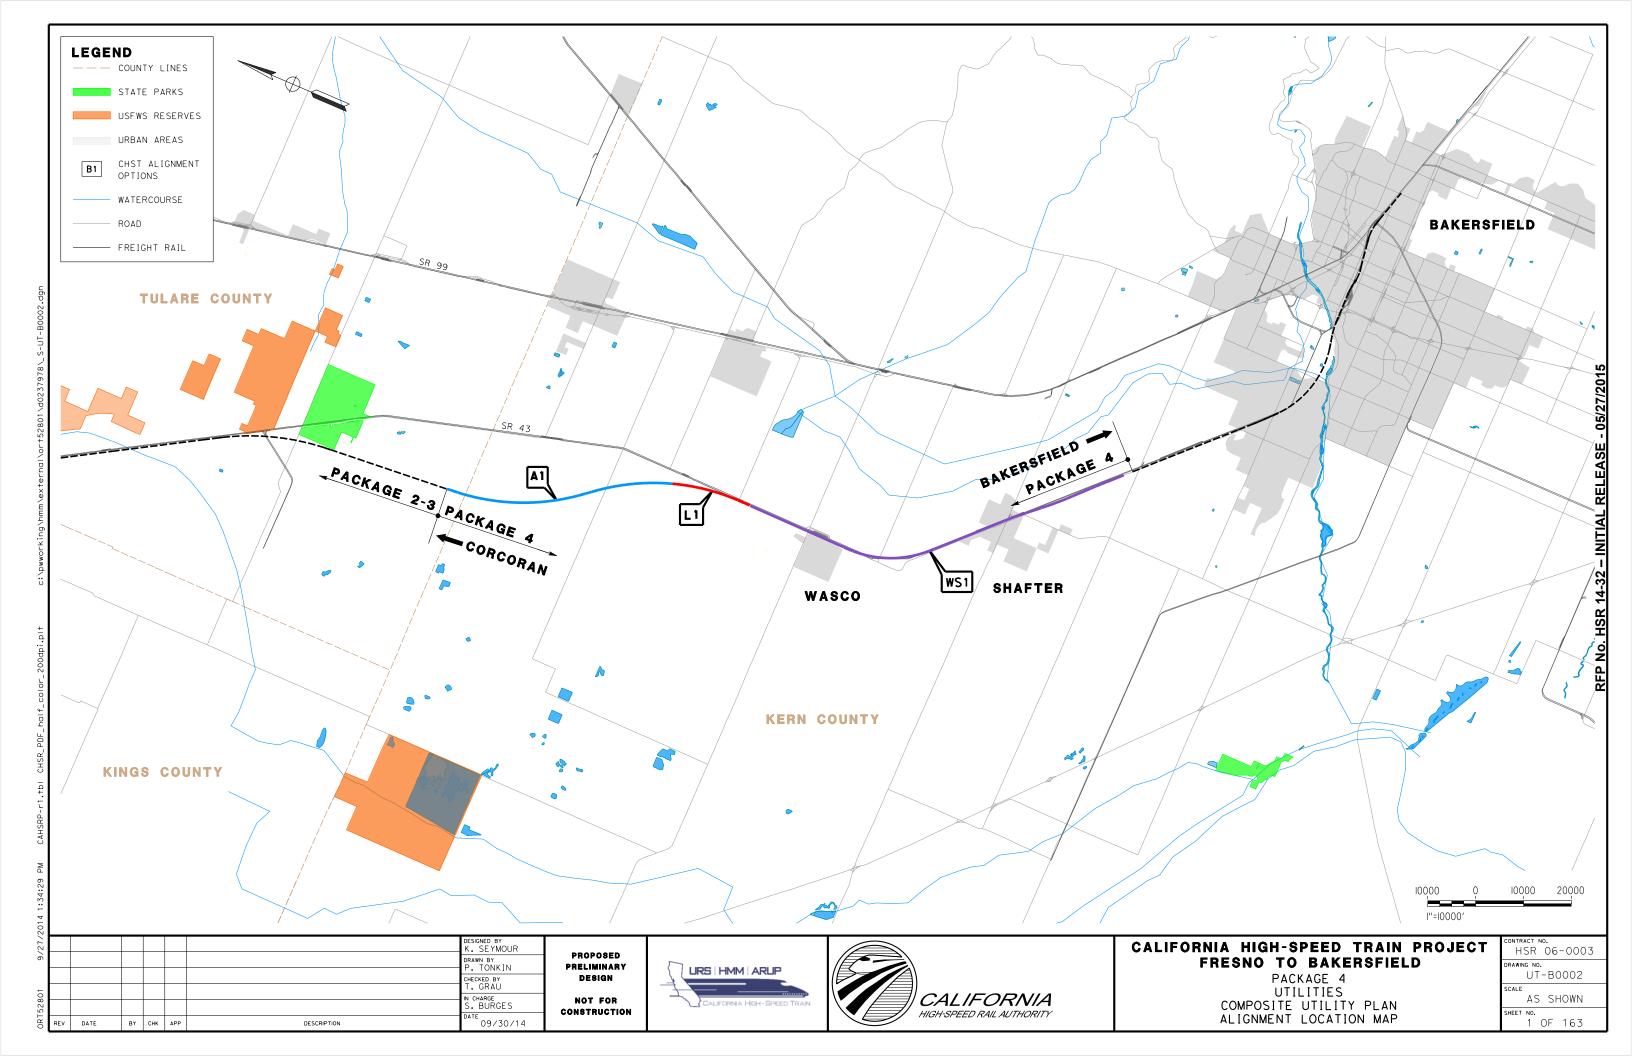

# 9/27/2014 1:34:47 PM

## **DRAWINGS**

DRAWING NO	DRAWING DESCRIPTION	SHEET NO
UT-B0002	PACKAGE 4 - UTILITIES - COMPOSITE UTILITY PLAN - ALIGNMENT LOCATION MAP	1 OF 163
GE-A0023	PACKAGE 4 - UTILITIES - COMPOSITE UTILITY PLAN - INDEX OF DRAWINGS (SHEET 1 OF 2)	2 OF 163
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UT-B0027	PACKAGE 4 - UTILITIES - COMPOSITE UTILITY PLAN - GENERAL NOTES	4 OF 163
UT-B0028	PACKAGE 4 - UTILITIES - COMPOSITE UTILITY PLAN - LEGEND, SYMBOLS & ABBREVATIONS	5 OF 163
UT-B0029	PACKAGE 4 - UTILITIES - COMPOSITE UTILITY PLAN - KEY MAP (SHEET 1 OF 3)	6 OF 163
UT-B0030	PACKAGE 3 - UTILITIES - COMPOSITE UTILITY PLAN - KEY MAP (SHEET 2 OF 3)	7 OF 163
UT-B0031	PACKAGE 4 - UTILITIES - COMPOSITE UTILITY PLAN - KEY MAP (SHEET 3 OF 3)	8 OF 163
UT-C4500	PACKAGE 4 - ALIGNMENT A1 - UTILITIES - COMPOSITE UTILITY PLAN - STA 4435+50 TO 4446+50	9 OF 163
UT-C4501	PACKAGE 4 - ALIGNMENT A1 - UTILITIES - COMPOSITE UTILITY PLAN - STA 4446+50 TO 4462+00	10 OF 163
UT-C4502	PACKAGE 4 - ALIGNMENT A1 - UTILITIES - COMPOSITE UTILITY PLAN - STA 4462+00 TO 4477+50	11 OF 163
UT-C4503	PACKAGE 4 - ALIGNMENT A1 - UTILITIES - COMPOSITE UTILITY PLAN - STA 4477+50 TO 4493+00	12 OF 163
UT-C4504	PACKAGE 4 - ALIGNMENT A1 - UTILITIES - COMPOSITE UTILITY PLAN - STA 4493+00 TO 4508+50	13 OF 163
UT-C4505	PACKAGE 4 - ALIGNMENT A1 - UTILITIES - COMPOSITE UTILITY PLAN - STA 4508+50 TO 4524+00	14 OF 163
UT-C4506	PACKAGE 4 - ALIGNMENT A1 - UTILITIES - COMPOSITE UTILITY PLAN - STA 4524+00 TO 4539+50	15 OF 163
UT-C4507	PACKAGE 4 - ALIGNMENT A1 - UTILITIES - COMPOSITE UTILITY PLAN - STA 4539+50 TO 4555+00	16 OF 163
UT-C4508	PACKAGE 4 - ALIGNMENT A1 - UTILITIES - COMPOSITE UTILITY PLAN - STA 4555+00 TO 4570+50	17 OF 163
UT-C4509	PACKAGE 4 - ALIGNMENT A1 - UTILITIES - COMPOSITE UTILITY PLAN - STA 4570+50 TO 4586+00	18 OF 163
UT-C4510	PACKAGE 4 - ALIGNMENT A1 - UTILITIES - COMPOSITE UTILITY PLAN - STA 4586+00 TO 4601+50	19 OF 163
UT-C4511	PACKAGE 4 - ALIGNMENT A1 - OTILITIES - COMPOSITE UTILITY PLAN - STA 4601+50 TO 4617+00	20 OF 163
UT-C4511	PACKAGE 4 - ALIGNMENT A1 - OTICITIES - COMPOSITE UTILITY PLAN - STA 4617+00 TO 4632+50	21 OF 163
UT-C4512 UT-C4513		
	PACKAGE 4 - ALIGNMENT A1 - UTILITIES - COMPOSITE UTILITY PLAN - STA 4632+50 TO 4648+00	22 OF 163
UT-C4514	PACKAGE 4 - ALIGNMENT A1 - UTILITIES - COMPOSITE UTILITY PLAN - STA 4648+00 TO 4663+50	23 OF 163
UT-C4515	PACKAGE 4 - ALIGNMENT A1 - UTILITIES - COMPOSITE UTILITY PLAN - STA 4663+50 TO 4679+00	24 OF 163
UT-C4516	PACKAGE 4 - ALIGNMENT A1 - UTILITIES - COMPOSITE UTILITY PLAN - STA 4679+00 TO 4694+50	25 OF 163
UT-C4517	PACKAGE 4 - ALIGNMENT A1 - UTILITIES - COMPOSITE UTILITY PLAN - STA 4694+50 TO 4710+00	26 OF 163
UT-C4518	PACKAGE 4 - ALIGNMENT A1 - UTILITIES - COMPOSITE UTILITY PLAN - STA 4710+00 TO 4725+50	27 OF 163
UT-C4519	PACKAGE 4 - ALIGNMENT A1 - UTILITIES - COMPOSITE UTILITY PLAN - STA 4725+50 TO 4741+00	28 OF 163
UT-C4520	PACKAGE 4 - ALIGNMENT A1 - UTILITIES - COMPOSITE UTILITY PLAN - STA 4741+00 TO 4756+50	29 OF 163
UT-C4521	PACKAGE 4 - ALIGNMENT A1 - UTILITIES - COMPOSITE UTILITY PLAN - STA 4756+50 TO 4772+00	30 OF 163
UT-C4522	PACKAGE 4 - ALIGNMENT A1 - UTILITIES - COMPOSITE UTILITY PLAN - STA 4772+00 TO 4787+50	31 OF 163
UT-C4523	PACKAGE 4 - ALIGNMENT A1 - UTILITIES - COMPOSITE UTILITY PLAN - STA 4787+50 TO 4803+00	32 OF 163
UT-C4524	PACKAGE 4 - ALIGNMENT A1 - UTILITIES - COMPOSITE UTILITY PLAN - STA 4803+00 TO 4818+50	33 OF 163
UT-C4525	PACKAGE 4 - ALIGNMENT A1 - UTILITIES - COMPOSITE UTILITY PLAN - STA 4818+50 TO 4834+00	34 OF 163
UT-C4526	PACKAGE 4 - ALIGNMENT A1 - UTILITIES - COMPOSITE UTILITY PLAN - STA 4834+00 TO 4849+50	35 OF 163
UT-C4527	PACKAGE 4 - ALIGNMENT A1 - UTILITIES - COMPOSITE UTILITY PLAN - STA 4849+50 TO 4865+00	36 OF 163
UT-C4528	PACKAGE 4 - ALIGNMENT A1 - UTILITIES - COMPOSITE UTILITY PLAN - STA 4865+00 TO 4880+50	37 OF 163
UT-C4529	PACKAGE 4 - ALIGNMENT A1 - UTILITIES - COMPOSITE UTILITY PLAN - STA 4880+50 TO 4896+00	38 OF 163
UT-C4530	PACKAGE 4 - ALIGNMENT A1 - UTILITIES - COMPOSITE UTILITY PLAN - STA 4896+00 TO 4911+50	39 OF 163
UT-C4531	PACKAGE 4 - ALIGNMENTS A1 & L1 - UTILITIES - COMPOSITE UTILITY PLAN - STA 4911+50 TO 5156+00	40 OF 163
UT-C4532	PACKAGE 4 - ALIGNMENT L1 - UTILITIES - COMPOSITE UTILITY PLAN - STA 5156+00 TO 5171+50	41 OF 163
UT-C4533	PACKAGE 4 - ALIGNMENT L1 - UTILITIES - COMPOSITE UTILITY PLAN - STA 5171+50 TO 5187+00	42 OF 163
UT-C4534	PACKAGE 4 - ALIGNMENT L1 - UTILITIES - COMPOSITE UTILITY PLAN - STA 5187+00 TO 5202+50	43 OF 163
UT-C4535	PACKAGE 4 - ALIGNMENT L1 - UTILITIES - COMPOSITE UTILITY PLAN - STA 5202+50 TO 5218+00	44 OF 163
UT-C4536	PACKAGE 4 - ALIGNMENT L1 - UTILITIES - COMPOSITE UTILITY PLAN - STA 5218+00 TO 5233+50	45 OF 163
UT-C4537	PACKAGE 4 - ALIGNMENT L1 - UTILITIES - COMPOSITE UTILITY PLAN - STA 5233+50 TO 5249+00	46 OF 163
UT-C4538	PACKAGE 4 - ALIGNMENT L1 - UTILITIES - COMPOSITE UTILITY PLAN - STA 5249+00 TO 5264+50	47 OF 163
UT-C4539	PACKAGE 4 - ALIGNMENT L1 - UTILITIES - COMPOSITE UTILITY PLAN - STA 5264+50 TO 5280+00	48 OF 163
UT-C4540	PACKAGE 4 - ALIGNMENT L1 - UTILITIES - COMPOSITE UTILITY PLAN - STA 5280+00 TO 5295+50	49 OF 163
UT-C4541	PACKAGE 4 - ALIGNMENT L1 - UTILITIES - COMPOSITE UTILITY PLAN - STA 5295+50 TO 5311+00	50 OF 163

## DRAWINGS - CONT.

DRAWING NO	DRAWING DESCRIPTION	SHEET NO
UT-C4542	PACKAGE 4 - ALIGNMENTS L1 & WS1 - UTILITIES - COMPOSITE UTILITY PLAN - STA 5311+00 TO 5426+50	51 OF 163
UT-C4543	PACKAGE 4 - ALIGNMENT WS1 - UTILITIES - COMPOSITE UTILITY PLAN - STA 5426+50 TO 5442+00	52 OF 163
UT-C4544	PACKAGE 4 - ALIGNMENT WS1 - UTILITIES - COMPOSITE UTILITY PLAN - STA 5442+00 TO 5457+50	53 OF 163
UT-C4545	PACKAGE 4 - ALIGNMENT WS1 - UTILITIES - COMPOSITE UTILITY PLAN - STA 5457+50 TO 5473+00	54 OF 163
UT-C4546	PACKAGE 4 - ALIGNMENT WS1 - UTILITIES - COMPOSITE UTILITY PLAN - STA 5473+00 TO 5488+50	55 OF 163
UT-C4547	PACKAGE 4 - ALIGNMENT WS1 - UTILITIES - COMPOSITE UTILITY PLAN - STA 5488+50 TO 5504+00	56 OF 163
UT-C4548	PACKAGE 4 - ALIGNMENT WS1 - UTILITIES - COMPOSITE UTILITY PLAN - STA 5504+00 TO 5519+50	57 OF 163
UT-C4549	PACKAGE 4 - ALIGNMENT WS1 - UTILITIES - COMPOSITE UTILITY PLAN - STA 5519+50 TO 5535+00	58 OF 163
UT-C4550	PACKAGE 4 - ALIGNMENT WS1 - UTILITIES - COMPOSITE UTILITY PLAN - STA 5535+00 TO 5550+50	59 OF 163
UT-C4551	PACKAGE 4 - ALIGNMENT WS1 - UTILITIES - COMPOSITE UTILITY PLAN - STA 5550+50 TO 5566+00	60 OF 163
UT-C4552	PACKAGE 4 - ALIGNMENT WS1 - UTILITIES - COMPOSITE UTILITY PLAN - STA 5566+00 TO 5581+50	61 OF 163
UT-C4553	PACKAGE 4 - ALIGNMENT WS1 - UTILITIES - COMPOSITE UTILITY PLAN - STA 5581+50 TO 5597+00	62 OF 163
UT-C4554	PACKAGE 4 - ALIGNMENT WS1 - UTILITIES - COMPOSITE UTILITY PLAN - STA 5597+00 TO 5612+50	63 OF 163
UT-C4555	PACKAGE 4 - ALIGNMENT WS1 - UTILITIES - COMPOSITE UTILITY PLAN - STA 5612+50 TO 5628+00	64 OF 163
UT-C4556	PACKAGE 4 - ALIGNMENT WS1 - UTILITIES - COMPOSITE UTILITY PLAN - STA 5628+00 TO 5643+50	65 OF 163
UT-C4557	PACKAGE 4 - ALIGNMENT WS1 - UTILITIES - COMPOSITE UTILITY PLAN - STA 5643+50 TO 5659+00	66 OF 163
UT-C4558	PACKAGE 4 - ALIGNMENT WS1 - UTILITIES - COMPOSITE UTILITY PLAN - STA 5659+00 TO 5674+50	67 OF 163
UT-C4559	PACKAGE 4 - ALIGNMENT WS1 - UTILITIES - COMPOSITE UTILITY PLAN - STA 5674+50 TO 5690+00	68 OF 163
UT-C4560	PACKAGE 4 - ALIGNMENT WS1 - UTILITIES - COMPOSITE UTILITY PLAN - STA 5690+00 TO 5705+50	69 OF 163
UT-C4561	PACKAGE 4 - ALIGNMENT WS1 - UTILITIES - COMPOSITE UTILITY PLAN - STA 5705+50 TO 5721+00	70 OF 163
UT-C4562	PACKAGE 4 - ALIGNMENT WS1 - UTILITIES - COMPOSITE UTILITY PLAN - STA 5721+00 TO 5736+50	71 OF 163
UT-C4563	PACKAGE 4 - ALIGNMENT WS1 - UTILITIES - COMPOSITE UTILITY PLAN - STA 5736+50 TO 5752+00	72 OF 163
UT-C4564	PACKAGE 4 - ALIGNMENT WS1 - UTILITIES - COMPOSITE UTILITY PLAN - STA 5752+00 TO 5767+50	73 OF 163
UT-C4565	PACKAGE 4 - ALIGNMENT WS1 - UTILITIES - COMPOSITE UTILITY PLAN - STA 5767+50 TO 5783+00	74 OF 163
UT-C4566	PACKAGE 4 - ALIGNMENT WS1 - UTILITIES - COMPOSITE UTILITY PLAN - STA 5783+00 TO 5798+50	75 OF 163
UT-C4567	PACKAGE 4 - ALIGNMENT WS1 - UTILITIES - COMPOSITE UTILITY PLAN - STA 5798+50 TO 5814+00	76 OF 163
UT-C4568	PACKAGE 4 - ALIGNMENT WS1 - UTILITIES - COMPOSITE UTILITY PLAN - STA 5814+00 TO 5829+50	77 OF 163
UT-C4569	PACKAGE 4 - ALIGNMENT WS1 - UTILITIES - COMPOSITE UTILITY PLAN - STA 5829+50 TO 5845+00	78 OF 163
UT-C4570	PACKAGE 4 - ALIGNMENT WS1 - UTILITIES - COMPOSITE UTILITY PLAN - STA 5845+00 TO 5860+50	79 OF 163
UT-C4571	PACKAGE 4 - ALIGNMENT WS1 - UTILITIES - COMPOSITE UTILITY PLAN - STA 5860+50 TO 5876+00	80 OF 163
UT-C4572	PACKAGE 4 - ALIGNMENT WS1 - UTILITIES - COMPOSITE UTILITY PLAN - STA 5876+00 TO 5891+50	81 OF 163
UT-C4573	PACKAGE 4 - ALIGNMENT WS1 - UTILITIES - COMPOSITE UTILITY PLAN - STA 5891+50 TO 5907+00	82 OF 163
UT-C4574	PACKAGE 4 - ALIGNMENT WS1 - UTILITIES - COMPOSITE UTILITY PLAN - STA 5907+00 TO 5922+50	83 OF 163
UT-C4575	PACKAGE 4 - ALIGNMENT WS1 - UTILITIES - COMPOSITE UTILITY PLAN - STA 5922+50 TO 5938+00	84 OF 163
UT-C4576	PACKAGE 4 - ALIGNMENT WS1 - UTILITIES - COMPOSITE UTILITY PLAN - STA 5938+00 TO 5953+50	85 OF 163
UT-C4577	PACKAGE 4 - ALIGNMENT WS1 - UTILITIES - COMPOSITE UTILITY PLAN - STA 5953+50 TO 5969+00	86 OF 163
UT-C4578	PACKAGE 4 - ALIGNMENT WS1 - UTILITIES - COMPOSITE UTILITY PLAN - STA 5969+00 TO 5984+50	87 OF 163
UT-C4579	PACKAGE 4 - ALIGNMENT WS1 - UTILITIES - COMPOSITE UTILITY PLAN - STA 5984+50 TO 6000+00	88 OF 163
UT-C4580	PACKAGE 4 - ALIGNMENT WS1 - UTILITIES - COMPOSITE UTILITY PLAN - STA 6000+00 TO 6015+50	89 OF 163
UT-C4581	PACKAGE 4 - ALIGNMENT WS1 - UTILITIES - COMPOSITE UTILITY PLAN - STA 6015+50 TO 6031+00	90 OF 163
UT-C4582	PACKAGE 4 - ALIGNMENT WS1 - UTILITIES - COMPOSITE UTILITY PLAN - STA 6031+00 TO 6046+50	91 OF 163
UT-C4583	PACKAGE 4 - ALIGNMENT WS1 - UTILITIES - COMPOSITE UTILITY PLAN - STA 6046+50 TO 6062+00	92 OF 163
UT-C4584	PACKAGE 4 - ALIGNMENT WS1 - UTILITIES - COMPOSITE UTILITY PLAN - STA 6062+00 TO 6077+50	93 OF 163
UT-C4585	PACKAGE 4 - ALIGNMENT WS1 - UTILITIES - COMPOSITE UTILITY PLAN - STA 6077+50 TO 6093+00	94 OF 163
UT-C4586	PACKAGE 4 - ALIGNMENT WS1 - UTILITIES - COMPOSITE UTILITY PLAN - STA 6093+00 TO 6108+50	95 OF 163
UT-C4587	PACKAGE 4 - ALIGNMENT WS1 - UTILITIES - COMPOSITE UTILITY PLAN - STA 6108+50 TO 6124+00	96 OF 163
UT-C4588	PACKAGE 4 - ALIGNMENT WS1 - UTILITIES - COMPOSITE UTILITY PLAN - STA 6124+00 TO 6139+50	97 OF 163
UT-C4589	PACKAGE 4 - ALIGNMENT WS1 - UTILITIES - COMPOSITE UTILITY PLAN - STA 6139+50 TO 6155+00	98 OF 163
UT-C4590	PACKAGE 4 - ALIGNMENT WS1 - UTILITIES - COMPOSITE UTILITY PLAN - STA 6155+00 TO 6170+50	99 OF 163
UT-C4591	PACKAGE 4 - ALIGNMENT WS1 - UTILITIES - COMPOSITE UTILITY PLAN - STA 6170+50 TO 6186+00	100 OF 163

						DESIGNED BY T. RAMIL
						DRAWN BY V. ORTEGA
						CHECKED BY
						IN CHARGE S. BURGES
REV	DATE	BY	СНК	APP	DESCRIPTION	09/30/14

PROPOSED PRELIMINARY DESIGN

NOT FOR CONSTRUCTION





## CALIFORNIA HIGH-SPEED TRAIN PROJECT FRESNO TO BAKERSFIELD

PACKAGE 4 UTILITIES COMPOSITE UTILITY PLAN INDEX OF DRAWINGS (SHEET 1 OF 2) CONTRACT NO.
HSR 06-0003

DRAWING NO.
GE-A0023

SCALE

NO SCALE


SHEET NO.
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DRAWING NO	DRAWING DESCRIPTION	SHEET NO
UT-C4592	PACKAGE 4 - ALIGNMENT WS1 - UTILITIES - COMPOSITE UTILITY PLAN - STA 6186+00 TO 6201+50	101 OF 163
UT-C4593	PACKAGE 4 - ALIGNMENT WS1 - UTILITIES - COMPOSITE UTILITY PLAN - STA 6201+50 TO 6217+00	102 OF 163
UT-C4594	PACKAGE 4 - ALIGNMENT WS1 - UTILITIES - COMPOSITE UTILITY PLAN - STA 6217+00 TO 6232+50	103 OF 163
UT-C4595	PACKAGE 4 - ALIGNMENT WS1 - UTILITIES - COMPOSITE UTILITY PLAN - STA 6232+50 TO 6248+00	104 OF 163
UT-C4596	PACKAGE 4 - ALIGNMENT WS1 - UTILITIES - COMPOSITE UTILITY PLAN - STA 6248+00 TO 6263+50	105 OF 163
UT-C4597	PACKAGE 4 - ALIGNMENT WS1 - UTILITIES - COMPOSITE UTILITY PLAN - STA 6263+50 TO 6279+00	106 OF 163
UT-C4598	PACKAGE 4 - ALIGNMENT WS1 - UTILITIES - COMPOSITE UTILITY PLAN - STA 6279+00 TO 6292+50	107 OF 163
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UT-C4704	PACKAGE 4 - ALIGNMENT A1 - UTILITIES - COMPOSITE UTILITY PLAN - POND ROAD	112 OF 163
UT-C4705	PACKAGE 4 - ALIGNMENT A1 - UTILITIES - COMPOSITE UTILITY PLAN - POND ROAD	113 OF 163
UT-C4706	PACKAGE 4 - ALIGNMENT A1 - UTILITIES - COMPOSITE UTILITY PLAN - POND ROAD	114 OF 163
UT-C4707	PACKAGE 4 - ALIGNMENT A1 - UTILITIES - COMPOSITE UTILITY PLAN - POND ROAD	115 OF 163
UT-C4708	PACKAGE 4 - ALIGNMENT A1 - UTILITIES - COMPOSITE UTILITY PLAN - PETERSON ROAD	116 OF 163
UT-C4709	PACKAGE 4 - ALIGNMENT A1 - UTILITIES - COMPOSITE UTILITY PLAN - PETERSON ROAD	117 OF 163
UT-C4710	PACKAGE 4 - ALIGNMENT A1 - UTILITIES - COMPOSITE UTILITY PLAN - PETERSON ROAD	118 OF 163
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UT-C4715	PACKAGE 4 - ALIGNMENT WS1 - UTILITIES - COMPOSITE UTILITY PLAN - MC COMBS ROAD	123 OF 163
UT-C4716	PACKAGE 4 - ALIGNMENT WS1 - UTILITIES - COMPOSITE UTILITY PLAN - MC COMBS ROAD	124 OF 163
UT-C4717	PACKAGE 4 - ALIGNMENT WS1 - UTILITIES - COMPOSITE UTILITY PLAN - MC COMBS ROAD	125 OF 16
UT-C4718	PACKAGE 4 - ALIGNMENT WS1 - UTILITIES - COMPOSITE UTILITY PLAN - MC COMBS ROAD	126 OF 16
UT-C4719	PACKAGE 4 - ALIGNMENT WS1 - UTILITIES - COMPOSITE UTILITY PLAN - ANNIN AVENUE ACCESS ROAD	127 OF 16
UT-C4720	PACKAGE 4 - ALIGN. WS1 - UTILITIES - COMPOSITE UTILITY PLAN - GROMER AVENUE ACCESS ROAD	128 OF 16
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UT-C4724	PACKAGE 4 - ALIGN. WS1 - UTILITIES - COMPOSITE UTILITY PLAN - DRESSER AVENUE ACCESS ROAD	132 OF 16
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UT-C4727	PACKAGE 4 - ALIGN. WS1 - UTILITIES - COMPOSITE UTILITY PLAN - DRESSER AVENUE ACCESS ROAD	135 OF 163
UT-C4728	PACKAGE 4 - ALIGN. WS1 - UTILITIES - COMPOSITE UTILITY PLAN - DRESSER AVENUE ACCESS ROAD	136 OF 16
UT-C4729	PACKAGE 4 - ALIGNMENT WS1 - UTILITIES - COMPOSITE UTILITY PLAN - MERCED AVENUE	137 OF 16
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UT-C4731	PACKAGE 4 - ALIGNMENT WS1 - UTILITIES - COMPOSITE UTILITY PLAN - MERCED AVENUE	139 OF 16
UT-C4732	PACKAGE 4 - ALIGNMENT WS1 - UTILITIES - COMPOSITE UTILITY PLAN - POPLAR AVENUE	140 OF 16
UT-C4733	PACKAGE 4 - ALIGNMENT WS1 - UTILITIES - COMPOSITE UTILITY PLAN - POPLAR AVENUE	141 OF 16
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UT-C4737	PACKAGE 4 - ALIGNMENT WS1 - UTILITIES - COMPOSITE UTILITY PLAN - FRESNO AVENUE	145 OF 163
UT-C4738	PACKAGE 4 - ALIGNMENT WS1 - UTILITIES - COMPOSITE UTILITY PLAN - RELOCATED LONE STAR SPUR	146 OF 16
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UT-C4740	PACKAGE 4 - ALIGNMENT WS1 - UTILITIES - COMPOSITE UTILITY PLAN - RELOCATED LONE STAR SPUR	148 OF 163
UT-C4741	PACKAGE 4 - ALIGNMENT WS1 - UTILITIES - COMPOSITE UTILITY PLAN - RELOCATED LONE STAR SPUR	149 OF 163
		0. 20.

## **DRAWINGS - CONT.**

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UT-C4744	PACKAGE 4 - ALIGNMENT WS1 - UTILITIES - COMPOSITE UTILITY PLAN - BURBANK STREET	152 OF 163
UT-C4745	PACKAGE 4 - ALIGNMENT WS1 - UTILITIES - COMPOSITE UTILITY PLAN - BURBANK STREET	153 OF 163
UT-C4746	PACKAGE 4 - ALIGN. WS1 - UTILITIES - COMPOSITE UTILITY PLAN - EX. LONE STAR SPUR ABANDONMENT	154 OF 163
UT-C4747	PACKAGE 4 - ALIGN. WS1 - UTILITIES - COMPOSITE UTILITY PLAN - EX. LONE STAR SPUR ABANDONMENT	155 OF 163
UT-C4748	PACKAGE 4 - ALIGN. WS1 - UTILITIES - COMPOSITE UTILITY PLAN - EX. LONE STAR SPUR ABANDONMENT	156 OF 163
UT-C4749	PACKAGE 4 - ALIGN. WS1 - UTILITIES - COMPOSITE UTILITY PLAN - EX. LONE STAR SPUR ABANDONMENT	157 OF 163
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UT-C4751	PACKAGE 4 - ALIGNMENT WS1 - UTILITIES - COMPOSITE UTILITY PLAN - SANTE FE WAY	159 OF 163
UT-C4752	PACKAGE 4 - ALIGNMENT WS1 - UTILITIES - COMPOSITE UTILITY PLAN - SANTE FE WAY	160 OF 163
UT-Y4505	PACKAGE 4 - UTILITIES - COMPOSITE UTILITY PLAN - HH&D FACILITY SCHEDULE (SHEET 1 OF 3)	161 OF 163
UT-Y4506	PACKAGE 4 - UTILITIES - COMPOSITE UTILITY PLAN - HH&D FACILITY SCHEDULE (SHEET 2 OF 3)	162 OF 163
UT-Y4507	PACKAGE 4 - UTILITIES - COMPOSITE UTILITY PLAN - HH&D FACILITY SCHEDULE (SHEET 3 OF 3)	163 OF 163



PROPOSED PRELIMINARY DESIGN NOT FOR

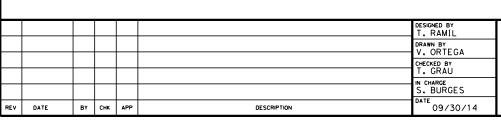CONSTRUCTION





## CALIFORNIA HIGH-SPEED TRAIN PROJECT FRESNO TO BAKERSFIELD

PACKAGE 4 UTILITIES COMPOSITE UTILITY PLAN INDEX OF DRAWINGS (SHEET 2 OF 2) ONTRACT NO. HSR 06-0003 GE-A0024

NO SCALE 3 OF 163

2.) G.I.S.

3.) AS-BUILT DRAWINGS
4.) LIMITED FIELD RECONNAISSANCE

THE CONTRACTOR SHALL CONDUCT ITS OWN SURVEY AND VERIFY THE LOCATION OF EXISTING UTILITIES AND RECONCILE THE SURVEY DATA AND

2. SERVICE LATERALS FOR POTABLE WATER, SANITARY SEWER & NATURAL GAS ARE NOT SHOWN.

27/201							DESIGNED BY T. RAMIL
6							DRAWN BY
1							CHECKED BY
ORT52801							IN CHARGE S. BURGES
ORT	REV	DATE	BY	СНК	APP	DESCRIPTION	DATE 09/30/14

PROPOSED PRELIMINARY DESIGN NOT FOR

CONSTRUCTION





## CALIFORNIA HIGH-SPEED TRAIN PROJECT FRESNO TO BAKERSFIELD

PACKAGE 4 UTILITIES COMPOSITE UTILITY PLAN GENERAL NOTES

CONTRACT NO.
HSR 06-0003
DRAWING NO.
UT-B0027
SCALE
NO SCALE

SHEET NO. 4 OF 163

## ABBREVIATIONS

EXISTING		<u>NEW</u>	DESCRIPTION	AB ABN	AGGREGATE BASE ABANDON	HOR	HORIZONTAL
				AC	ASPHALT CONCRETE	IN	INCH
—е	— -(oh)— — - E —	—— -(ОН)—	ELECTRICAL OVERHEAD LINE	ACB ACP	ASPHALT CONCRETE BASE ASBESTOS CEMENT PIPE	INV IRR	INVERT IRRIGATION
	— -e—     — -E—	—— —— -Е —	ELECTRICAL UNDERGROUND LINE	A/G APPROX	AT GRADE APPROXIMATE	L	LENGTH
——-g——-	—		NATURAL GAS LINE	AVE	AVENUE	LED	LIGHT EMITTING DIODE
irr -		— IRR — —	IRRIGATION LINE	BCR	BEGIN CURVE RETURN	LG LS	LIP OF GUTTER LANDSCAPE
		••••		BEG	BEGIN CORVE RETORN	LT	LEFT
	—o—    —0—	<del></del>	OIL LINE	BLDG	BUILDING		
sd	—sd- — SD-		STORM DRAIN LINE	BLVD B.O.	BOULE VARD BLOW-OFF	MIN	MINIMUM
s	ss_		SEWER LINE	BOC	BACK OF CURB	N	NORTH, NORTHING, NEW
tc	(ab)	—— ——(он)—	TELECOMMUNICATION OVERHEAD LINE	BS <b>W</b> BVCE	BACK OF SIDEWALK BEGIN VERTICAL CURVE ELEVATION	NA NIC, N.I.C.	NOT APPLICABLE, NOT KNOWN NOT IN CONTRACT
— IC ———	— (UII)———————————————————————————————————	—— — (ОН)—	TELECOMMONICATION OVERHEAD LINE	BVCS	BEGIN VERTICAL CURVE STATION	NO NO	NUMBER
tc	tc TC -	TC -	TELECOMMUNICATION UNDERGROUND LINE	СВ	CATCH BASIN	N.T.S.	NOT TO SCALE
w	ww	w	WATER LINE	CD	CURB DRAIN	(P)	PROPOSED
	TV -	— — — (ОН)—	TELEVISION OVERHEAD LINE	C&G	CURB AND GUTTER	PCC	PORTLAND CEMENT CONCRETE
1 <b>V</b>	(0.3)	(0,		CH CIP	CURB HEIGHT CAST IRON PIPE	PRKG PVC	PARKING POLYVINYL CHLORIDE
tv	tvTV	— ——TV—	TELEVISION UNDERGROUND LINE	CL	CENTERLINE	PVMT	PAVEMENT
— fo — –	— fo — — F0 —	— — F0 —	FIBER OPTIC LINE	CLSM	CONTROLLED LOW STRENGTH MATERIAL	_	
				CMP CTV	CORRUGATED METAL PIPE CABLE TELEVISION	R RCP	RADIUS REINFORCED CONCRETE PIPE
		•	IRRIGATION WELL, WEIR, TURNOUT, SUMP, PUMP	CV	CURVE	REQ'D	REQUIRED
$\odot$		$\odot$	SEWER MANHOLE			R/R	REMOVE AND REPLACE/RELOCATE
			UTILITY POLE	D	DEPTH DEATHACE IN ET	RT R∕W, ROW	RIGHT RIGHT OF WAY
				DI DIA	DRAINAGE INLET DIAMETER	·	
		<b>O</b>	STORM DRAIN MANHOLE	DIP	DUCTILE IRON PIPE	S SD	SLOPE, SOUTH, SEWER STORM DRAIN
+0+		+0+	FIRE HYDRANT	DWG	DRAWING	SDI	STORM DRAIN INLET
$\Rightarrow$		×	STREET LIGHT	E E	ELECTRICAL, ELECTRIC EAST, EXISTING	SDMH SF	STORM DRAIN MANHOLE SQUARE FEET
			NORTH ARROW	EC	END HORIZONTAL CURVE	SHLD	SHOULDER
			RIGHT-OF-WAY	EDG EL OR ELEV	EDGE ELEVATION	SR SS	STATE ROUTE SANITARY SEWER
				ELEC	ELECTRICAL, ELECTRIC	SSMH	SANITARY SEWER MANHOLE
			TEMPORARY CONSTRUCTION EASEMENT	ELEC OH ELL	ELECTRICAL OVERHEAD ELBOW	ST STA	STREET STATION
			PERMANENT EASEMENT	EP, EOP	EDGE OF PAVEMENT	SW	SIDEWALK
	1655+00		HST TRACK CENTER LINE	ETW EVCE	EDGE OF TRAVEL WAY END OF VERTICAL CURVE ELEVATION	Т	TELEPHONE, TOTAL
			UTILITY TO BE REMOVED	EVCS	END OF VERTICAL CURVE STATION	TC	TELECOMMUNICATION
	////////////		OR RELOCATED	EXIST, EX, (E)	EXISTING	TCE TEL	TEMPORARY CONSTRUCTION EASEMENT TELEPHONE
			LIMIT OF DITCH	FDAC	FULL DEPTH ASPHALT CONCRETE	TOC	TOP OF CURB
			LIMIT OF EMBANKMENT	FH FM	FIRE HYDRANT FORCE MAIN	TS TYP	TRAFFIC SIGNAL TYPICAL
			RETAINING WALL			UG, U/G	UNDERGROUND
			ROADWAY ABANDONMENT	F.O.	FIBER OPTIC	USFWS	U.S. FISH AND WILDLIFE SERVICE
				FOC	FACE OF CURB	VAR	VARIES
			METAL BEAM GUARDRAIL	FUT	FUTURE	VC VCP	VERTICAL CURVE VITRIFIED CLAY PIPE
			GRADE CROSSING REMOVAL	G	GAS		
	ww	-	PIPE ENCASEMENT	GALV	GALVANIZED CRADE BREAK	W	WATER, WEST
			STRUCTURE FOUNDATION	GB GIS	GRADE BREAK GEOGRAPHICAL INFORMATION SYSTEM	W / WM	WITH WATER MAIN
	[]			GND GTR GV	GROUND GUTTER GAS VALVE	WV	WATER VALVE

DESIGNED BY DRAWN BY V. ORTEGA CHECKED BY N CHARGE S. BURGES TE 09/30/14 BY CHK APP DESCRIPTION

PROPOSED PRELIMINARY DESIGN NOT FOR







## CALIFORNIA HIGH-SPEED TRAIN PROJECT FRESNO TO BAKERSFIELD


PACKAGE 4 UTILITIES COMPOSITE UTILITY PLAN LEGEND, SYMBOLS & ABBREVIATIONS


ONTRACT NO. HSR 06-0003 NAWING NO.
UT-B0028 NO SCALE


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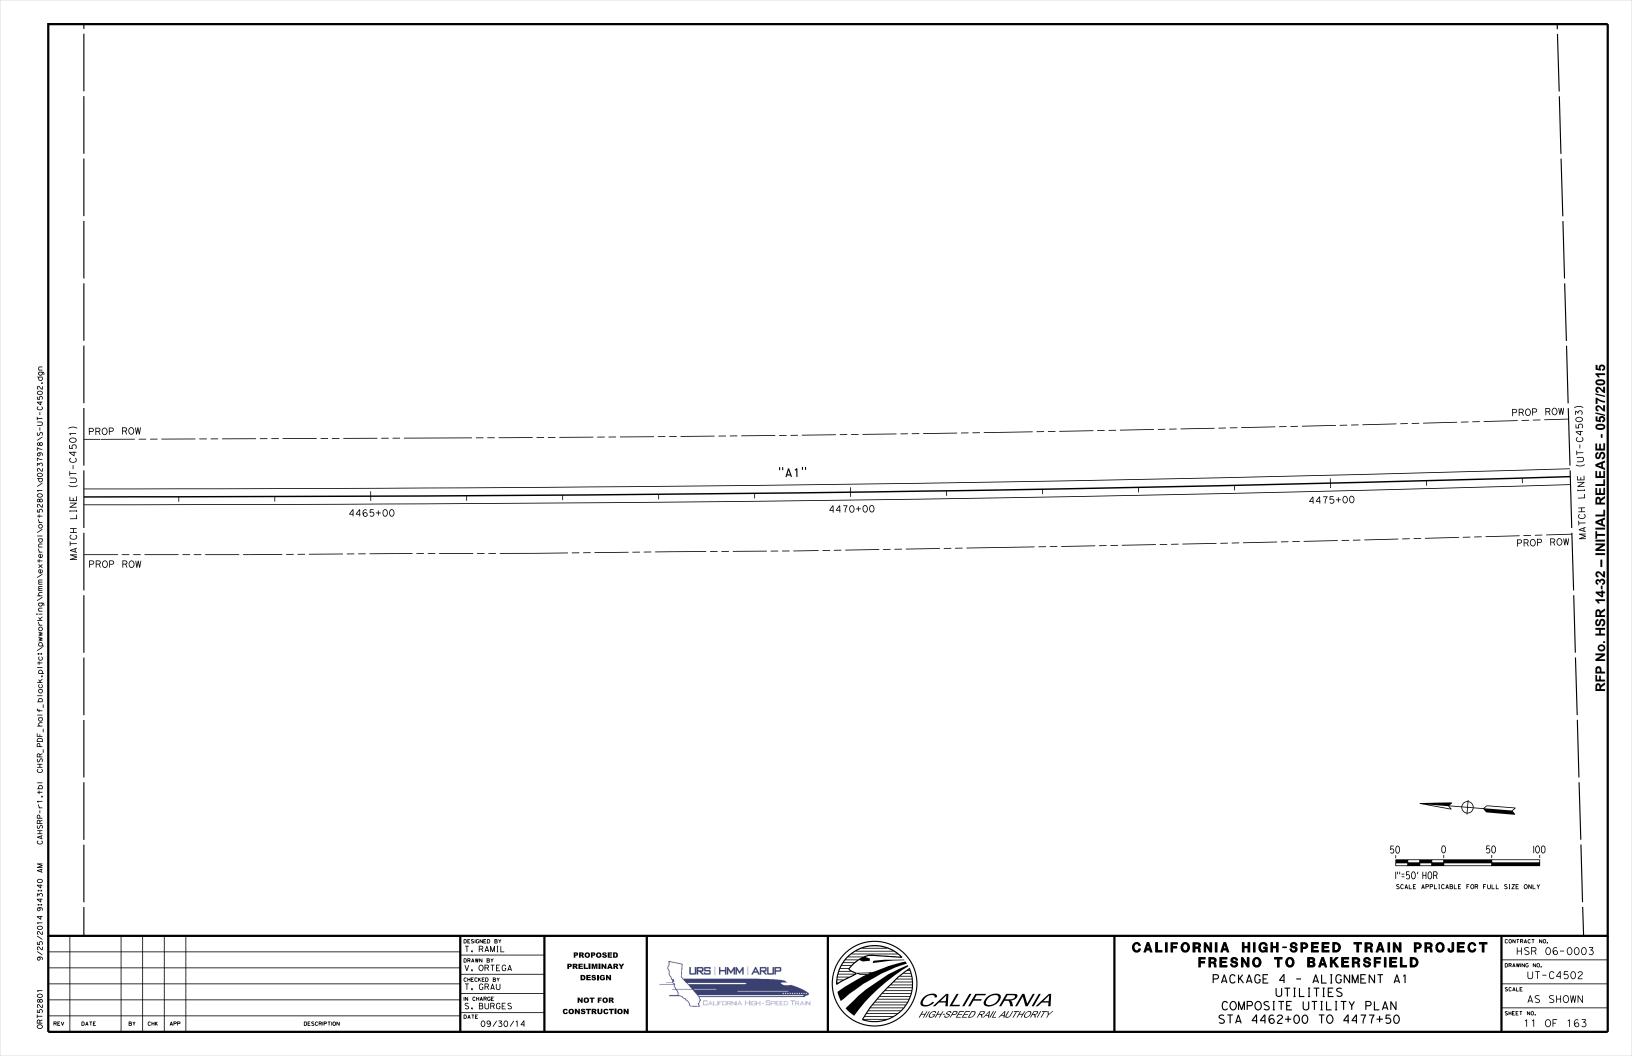


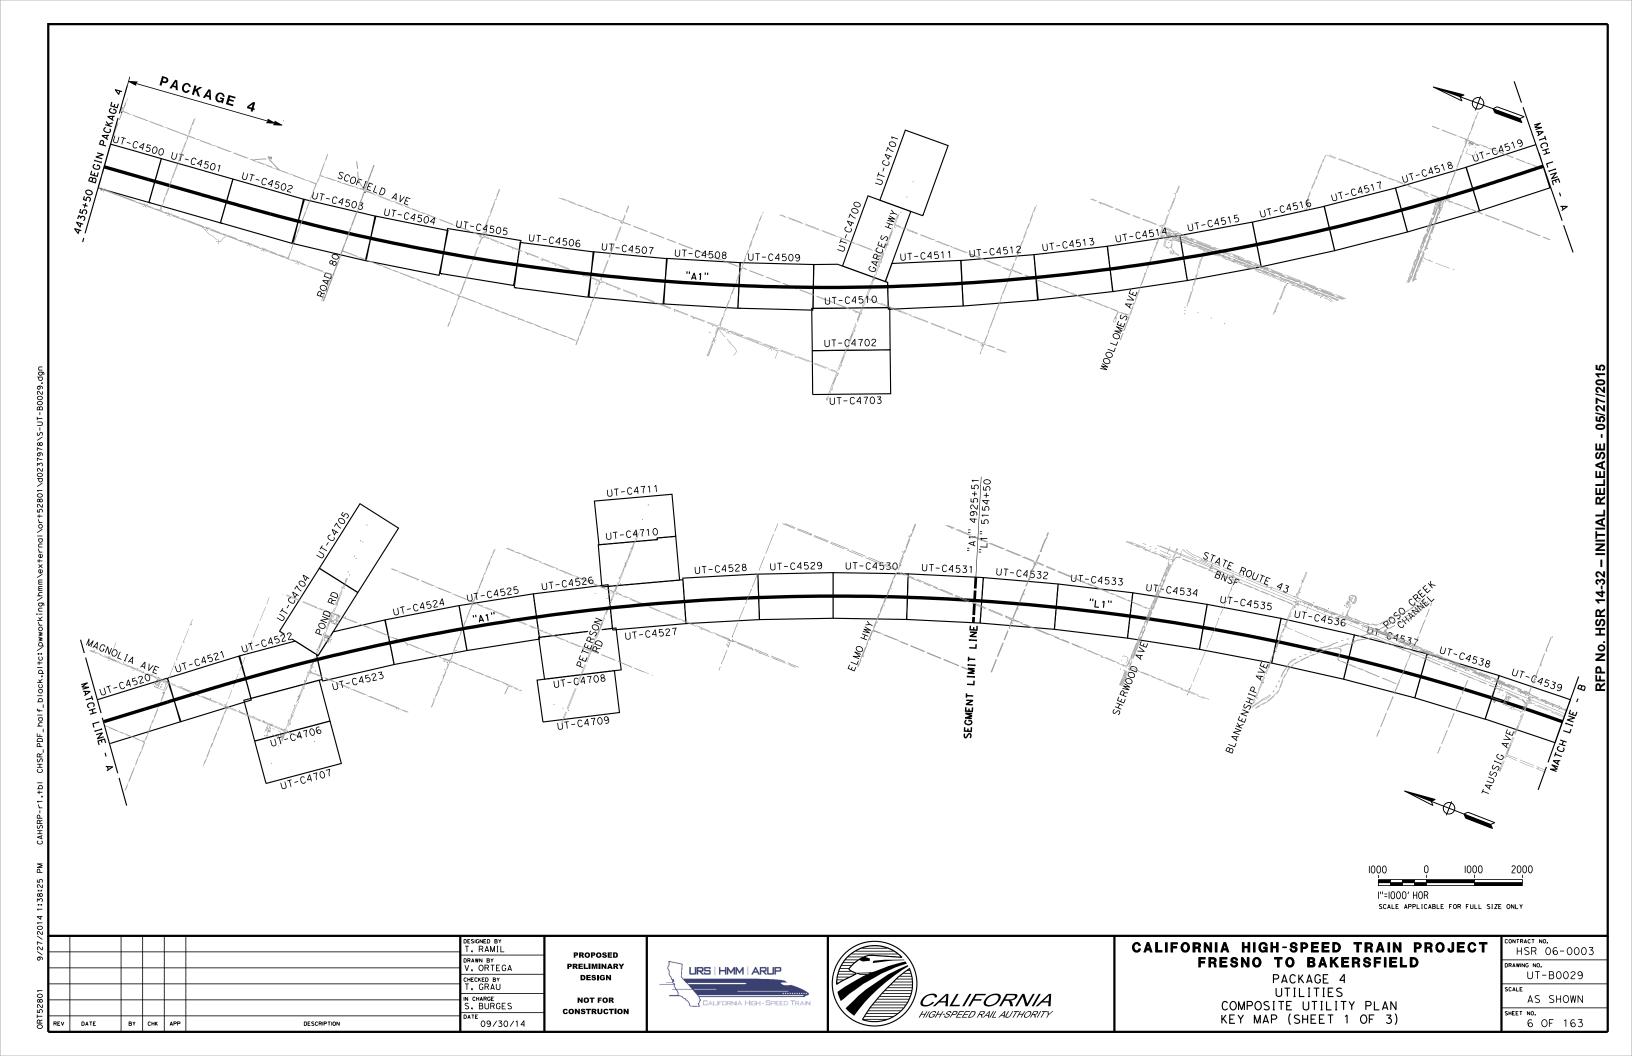


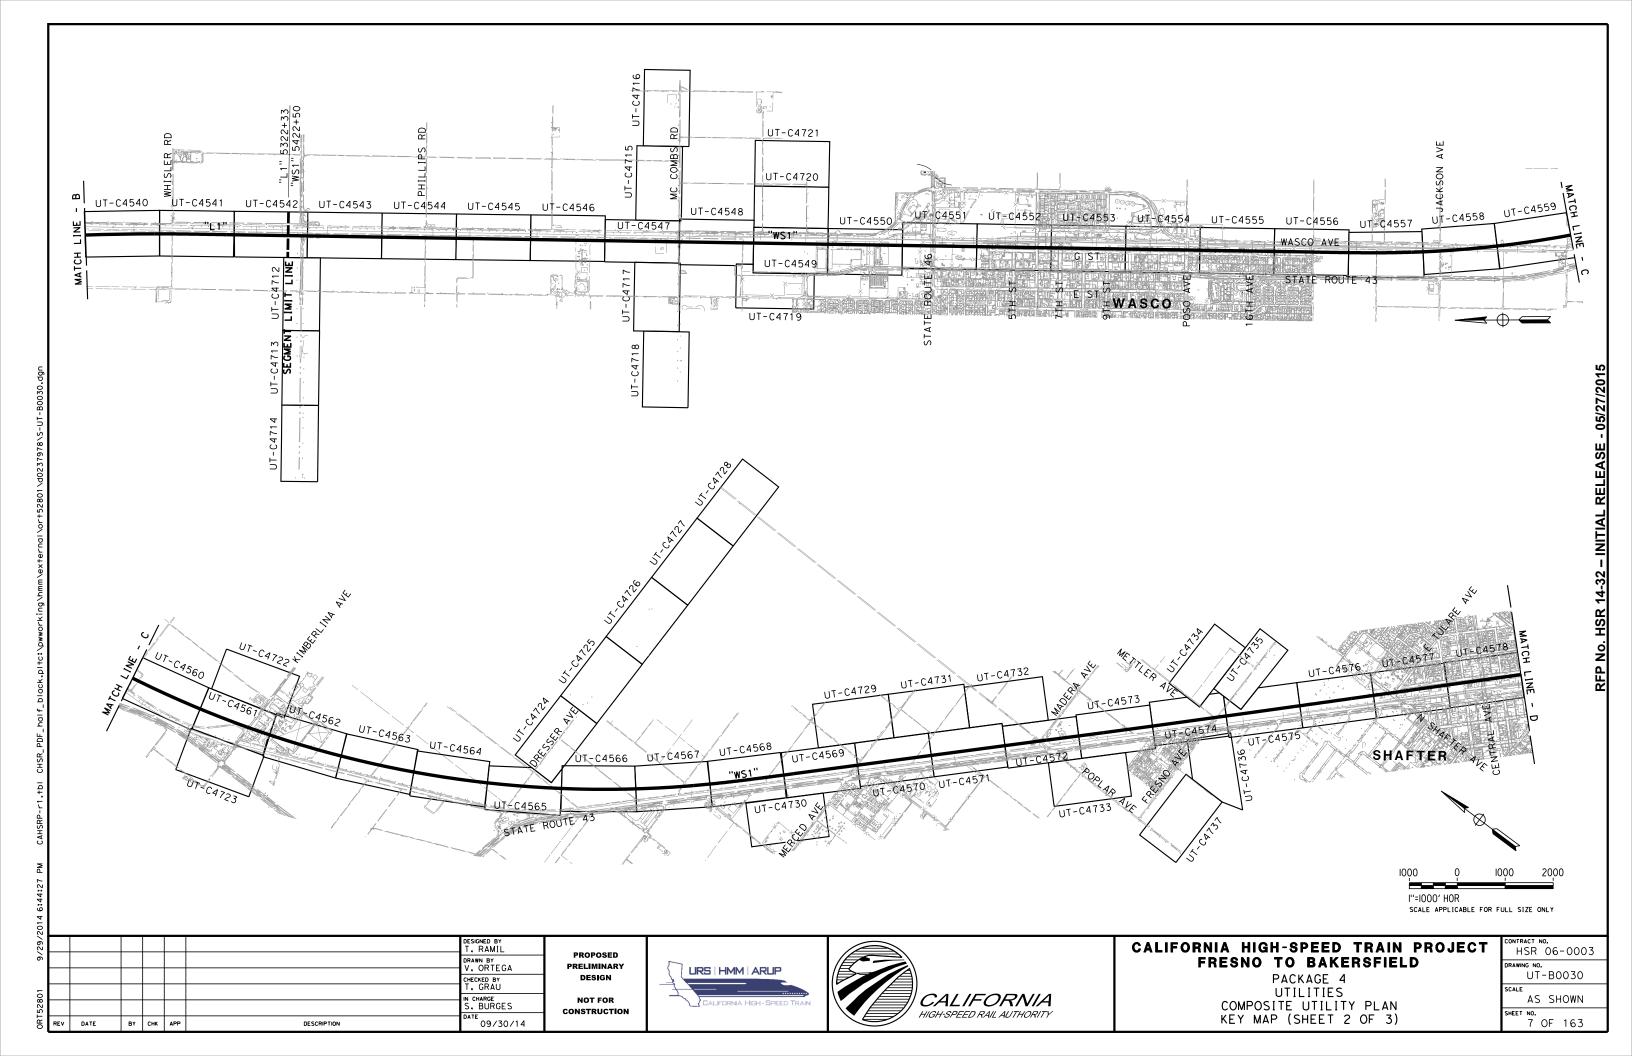


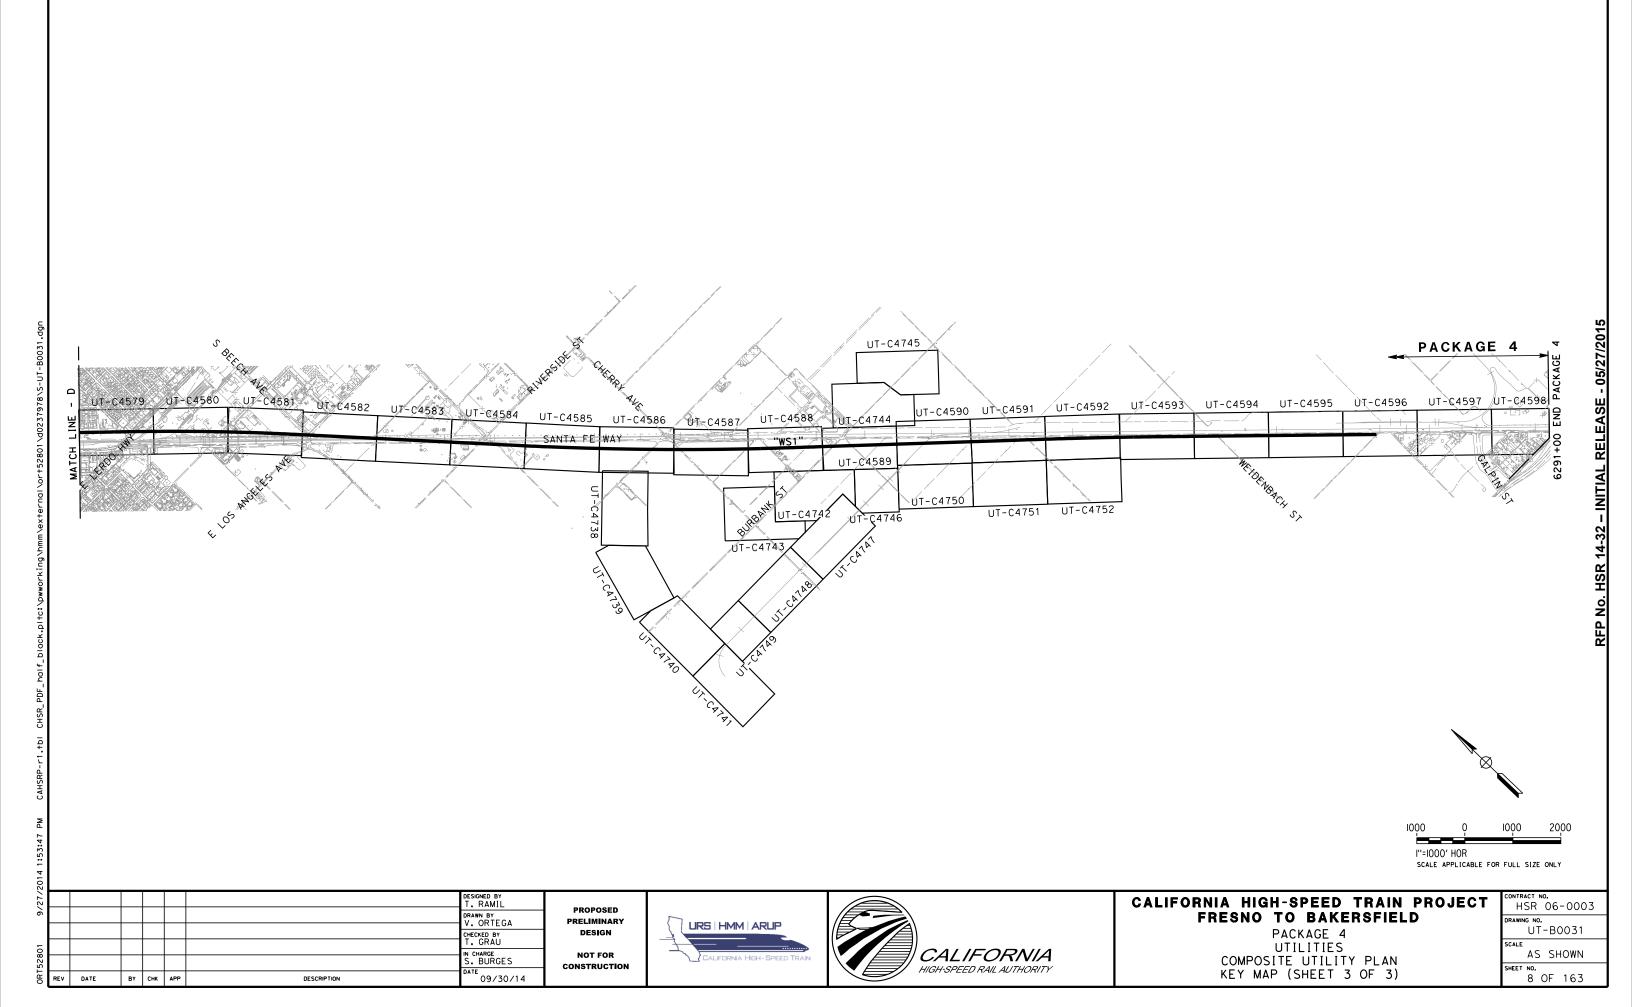


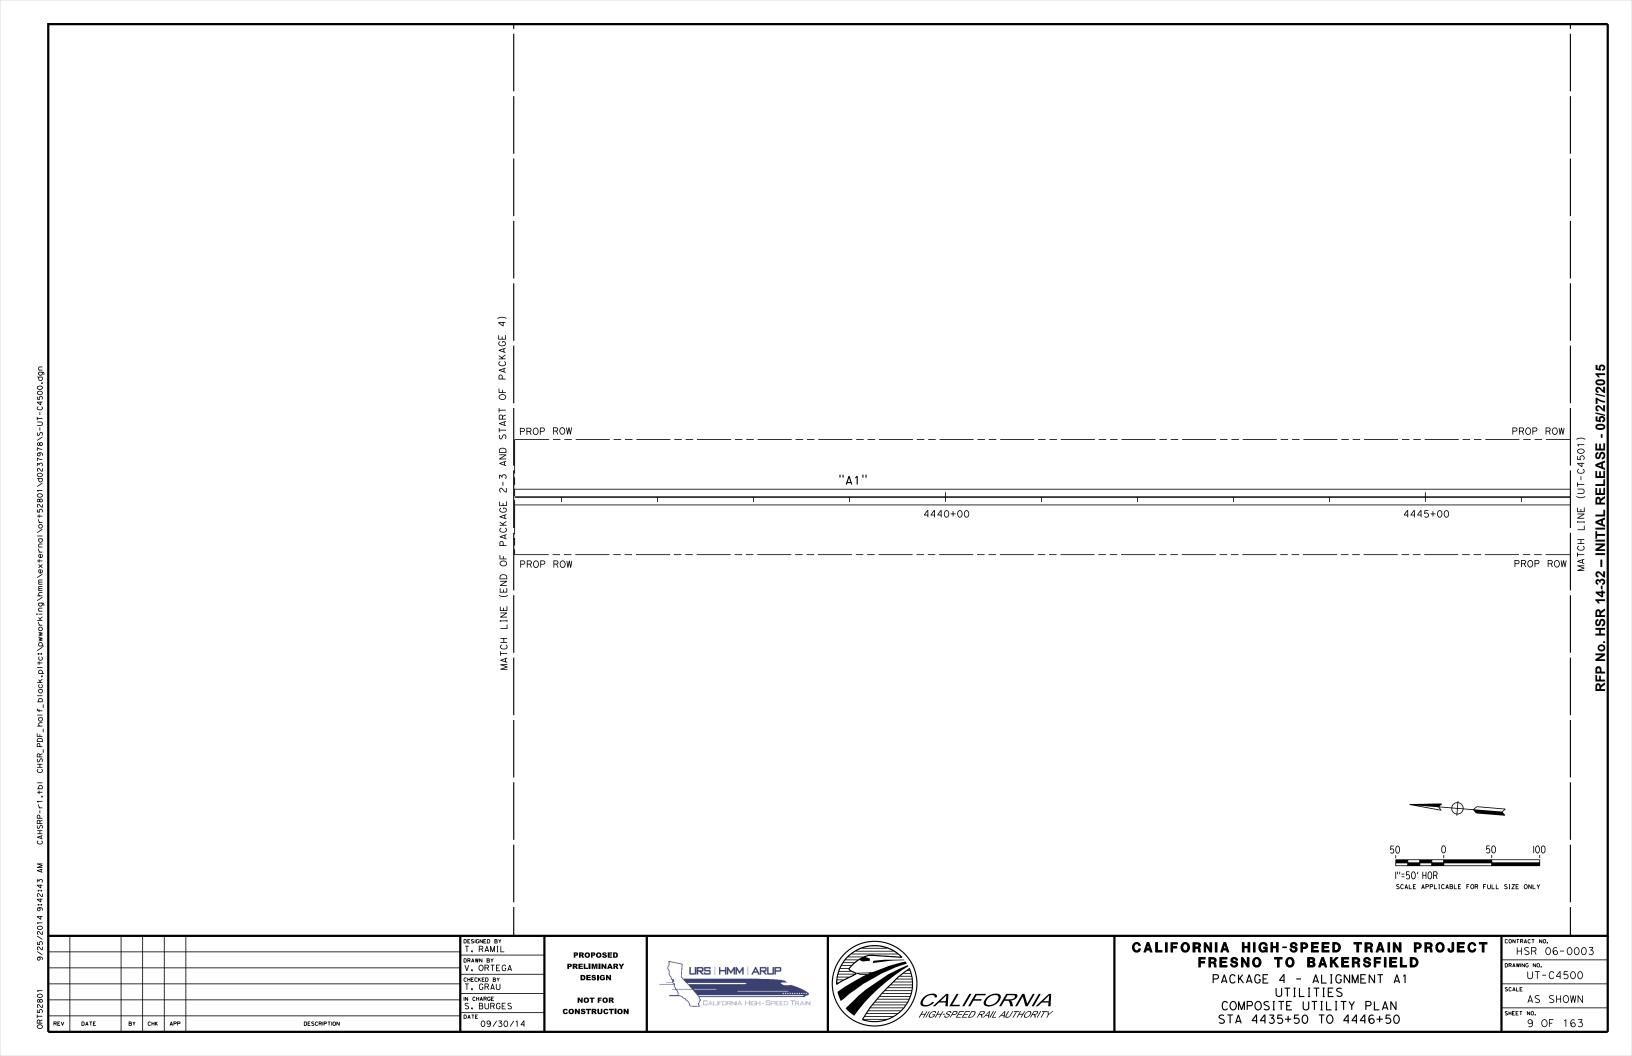


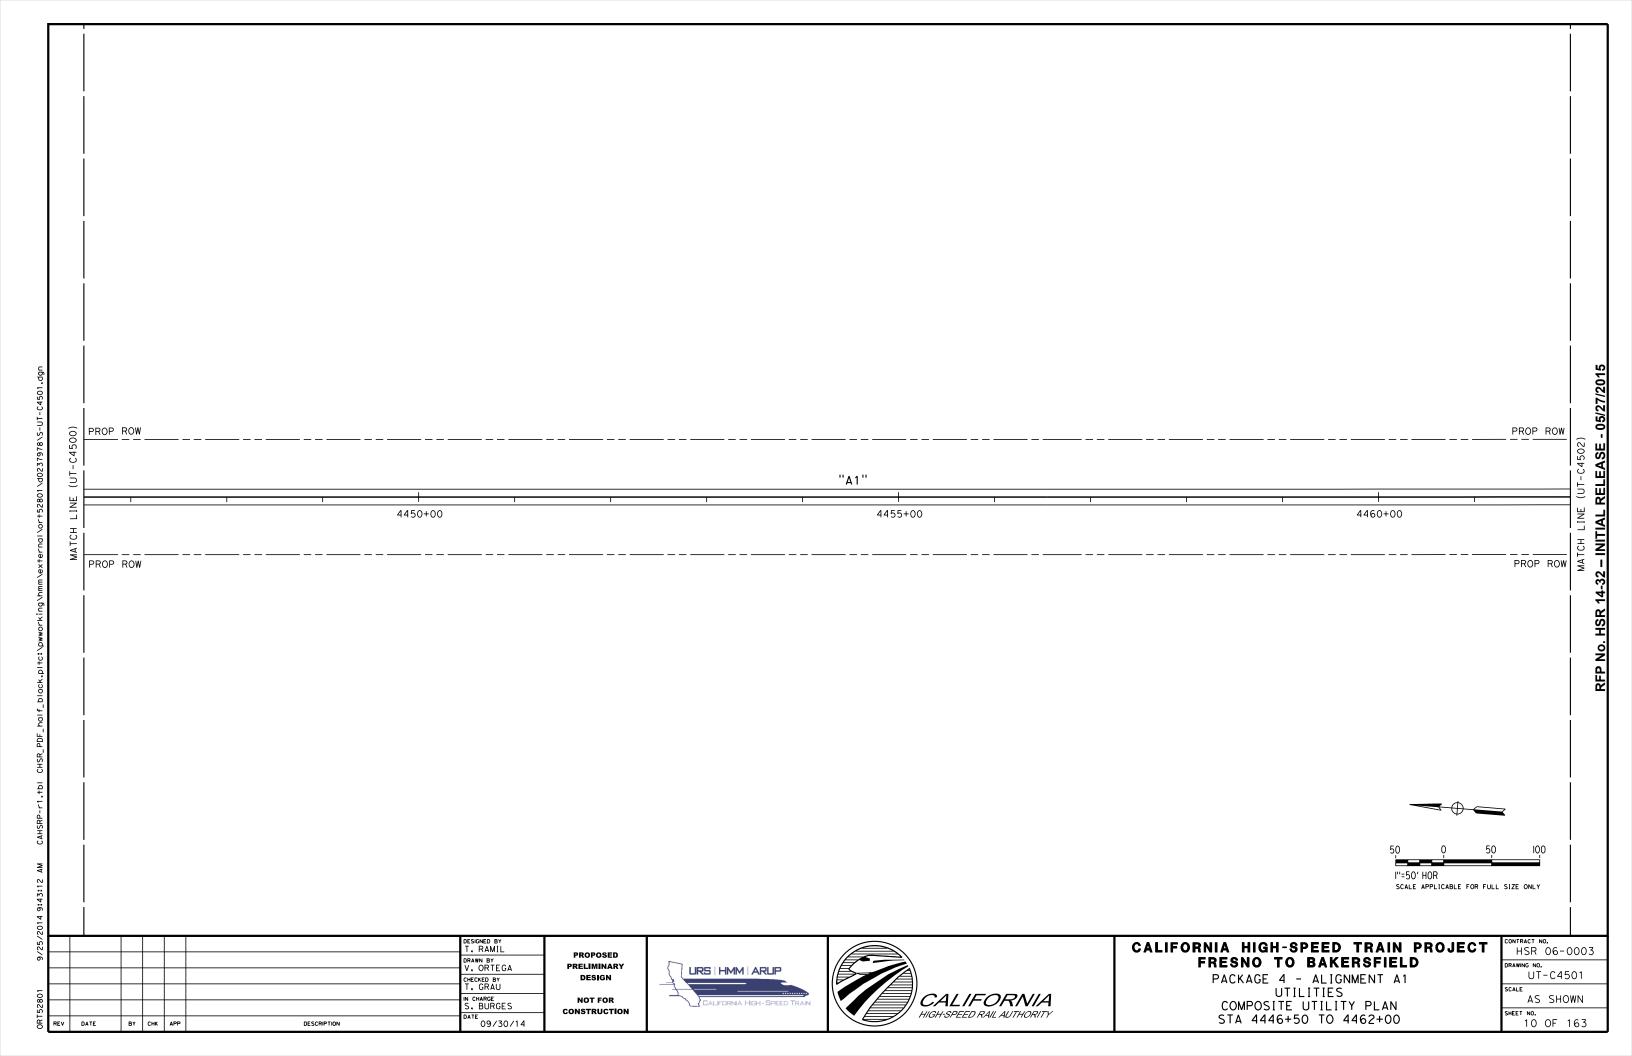


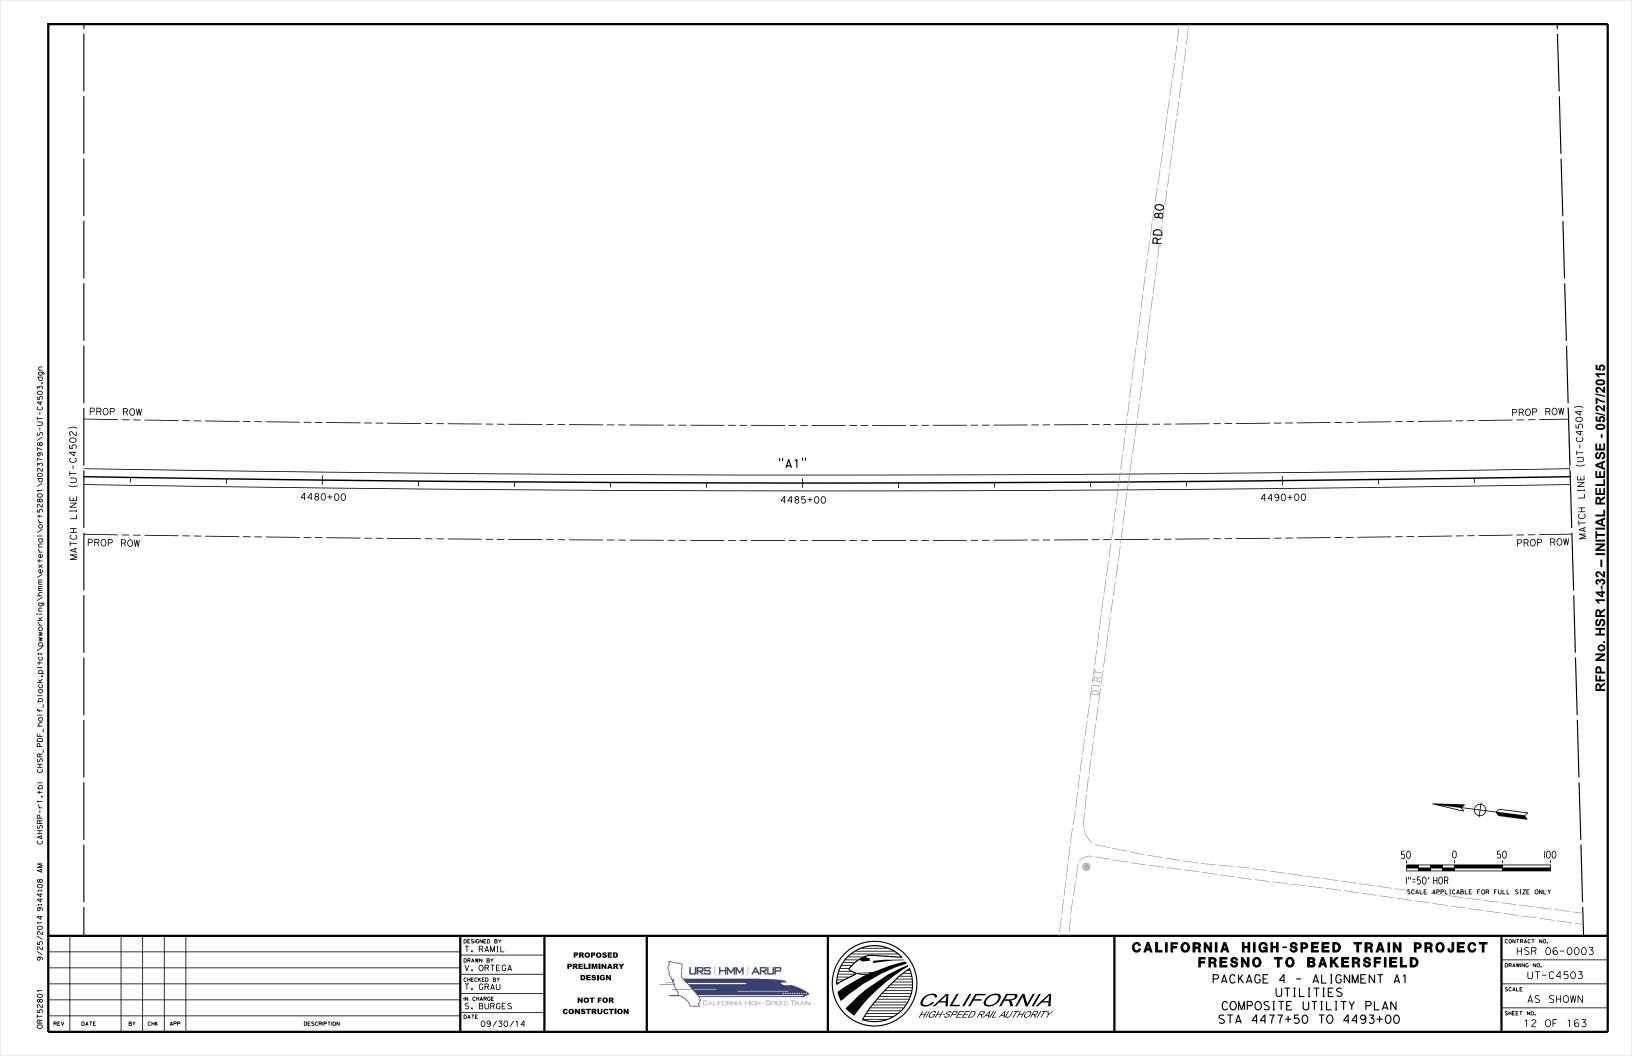


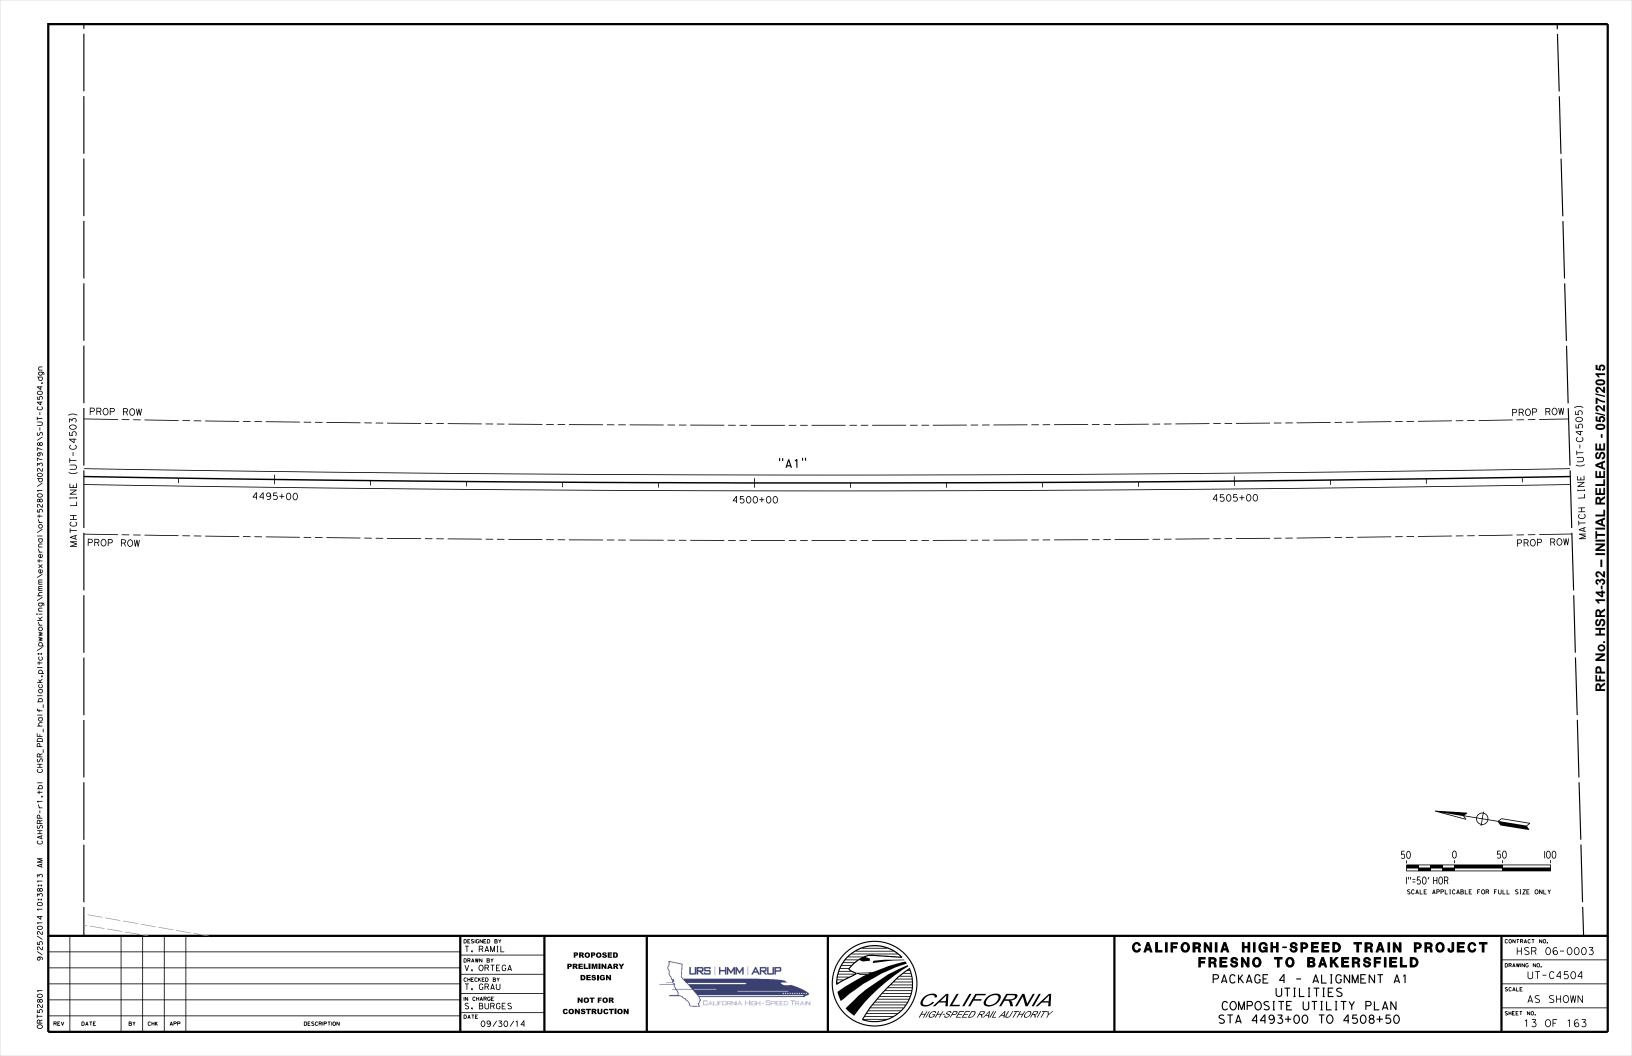


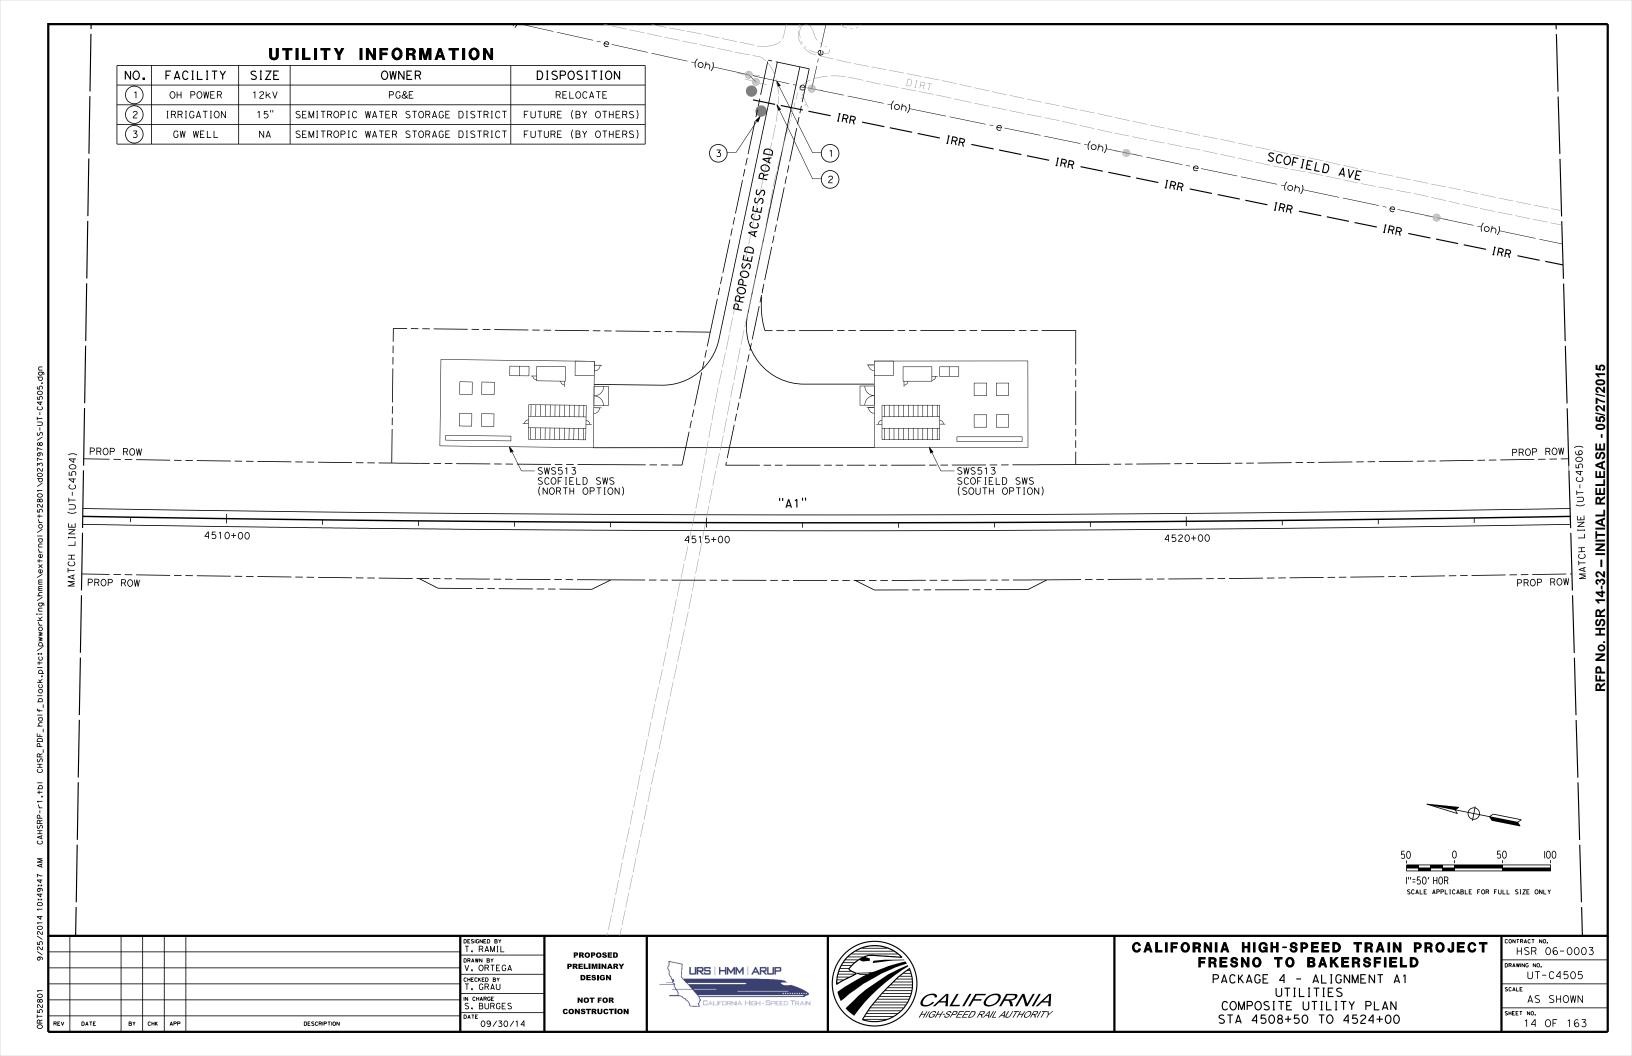


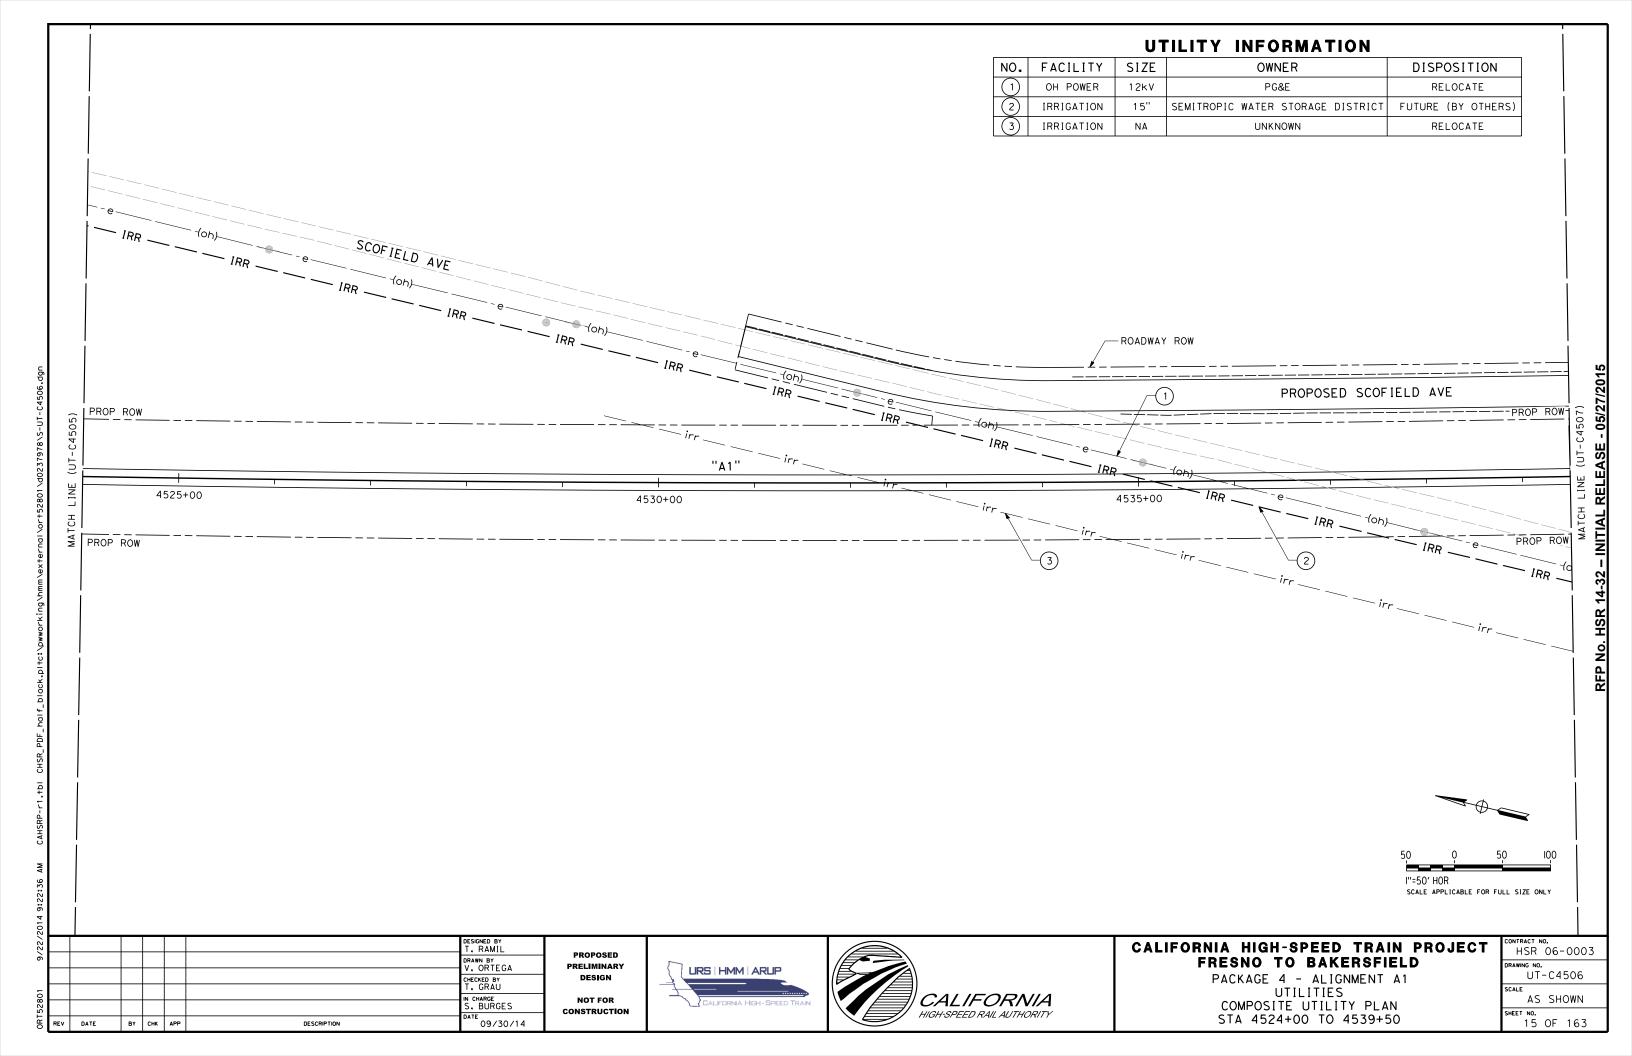


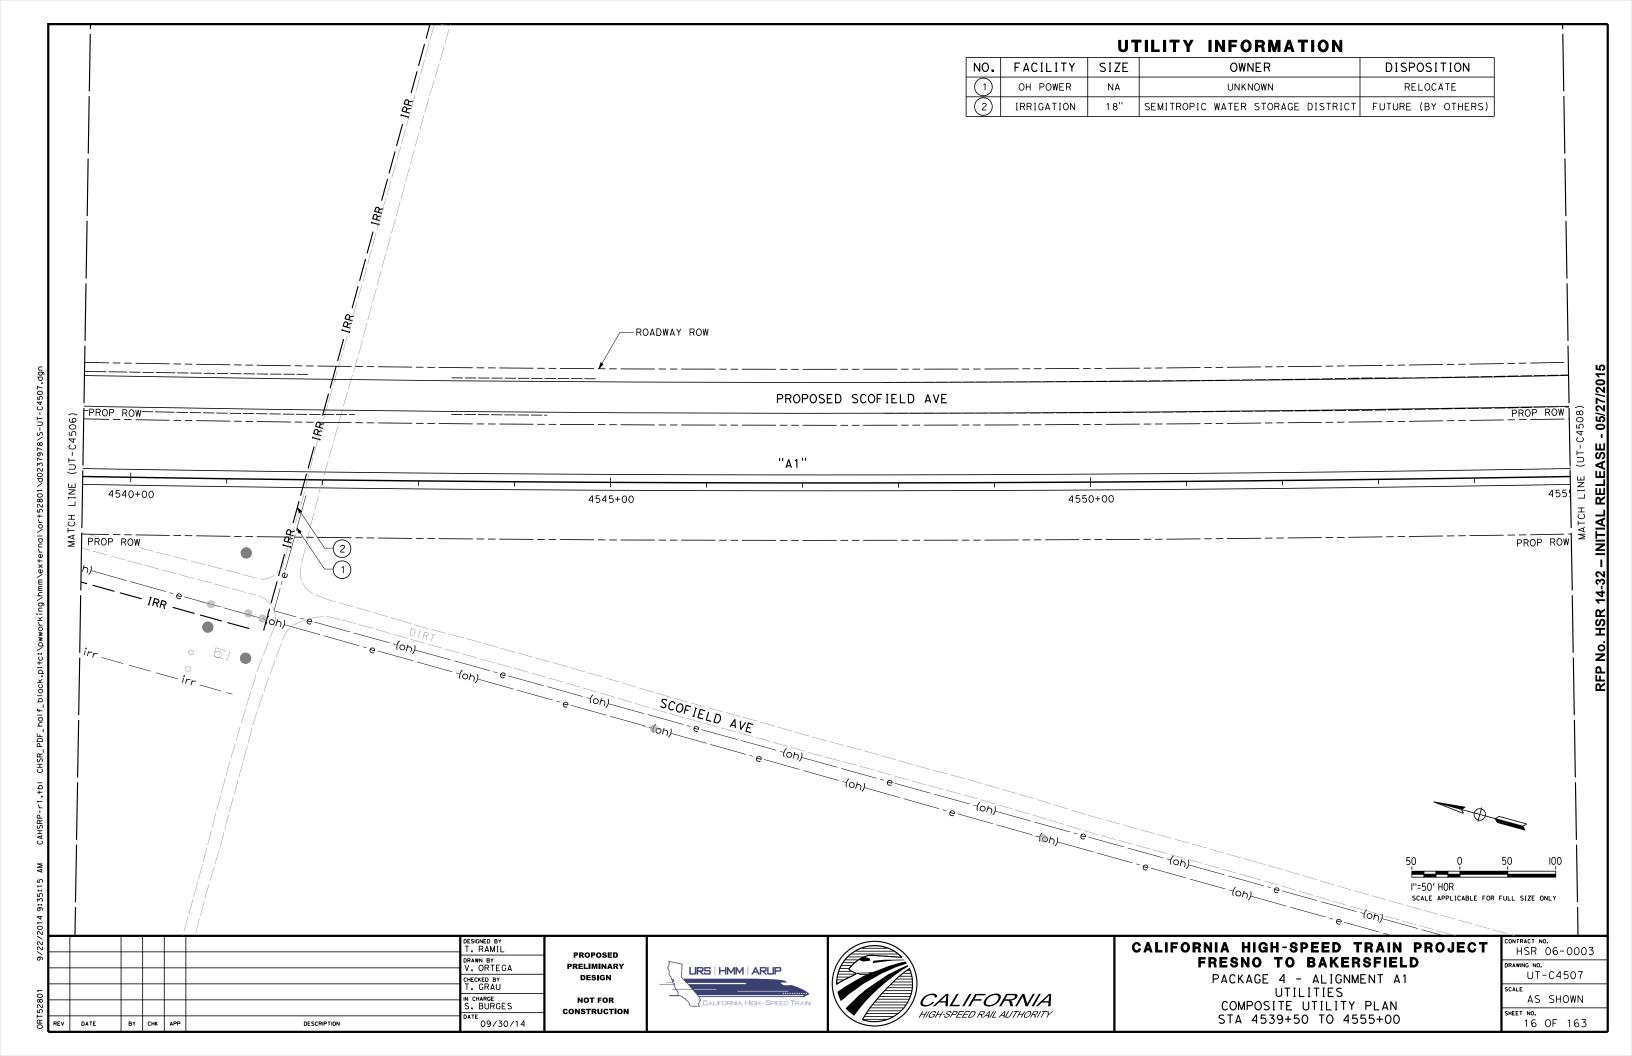


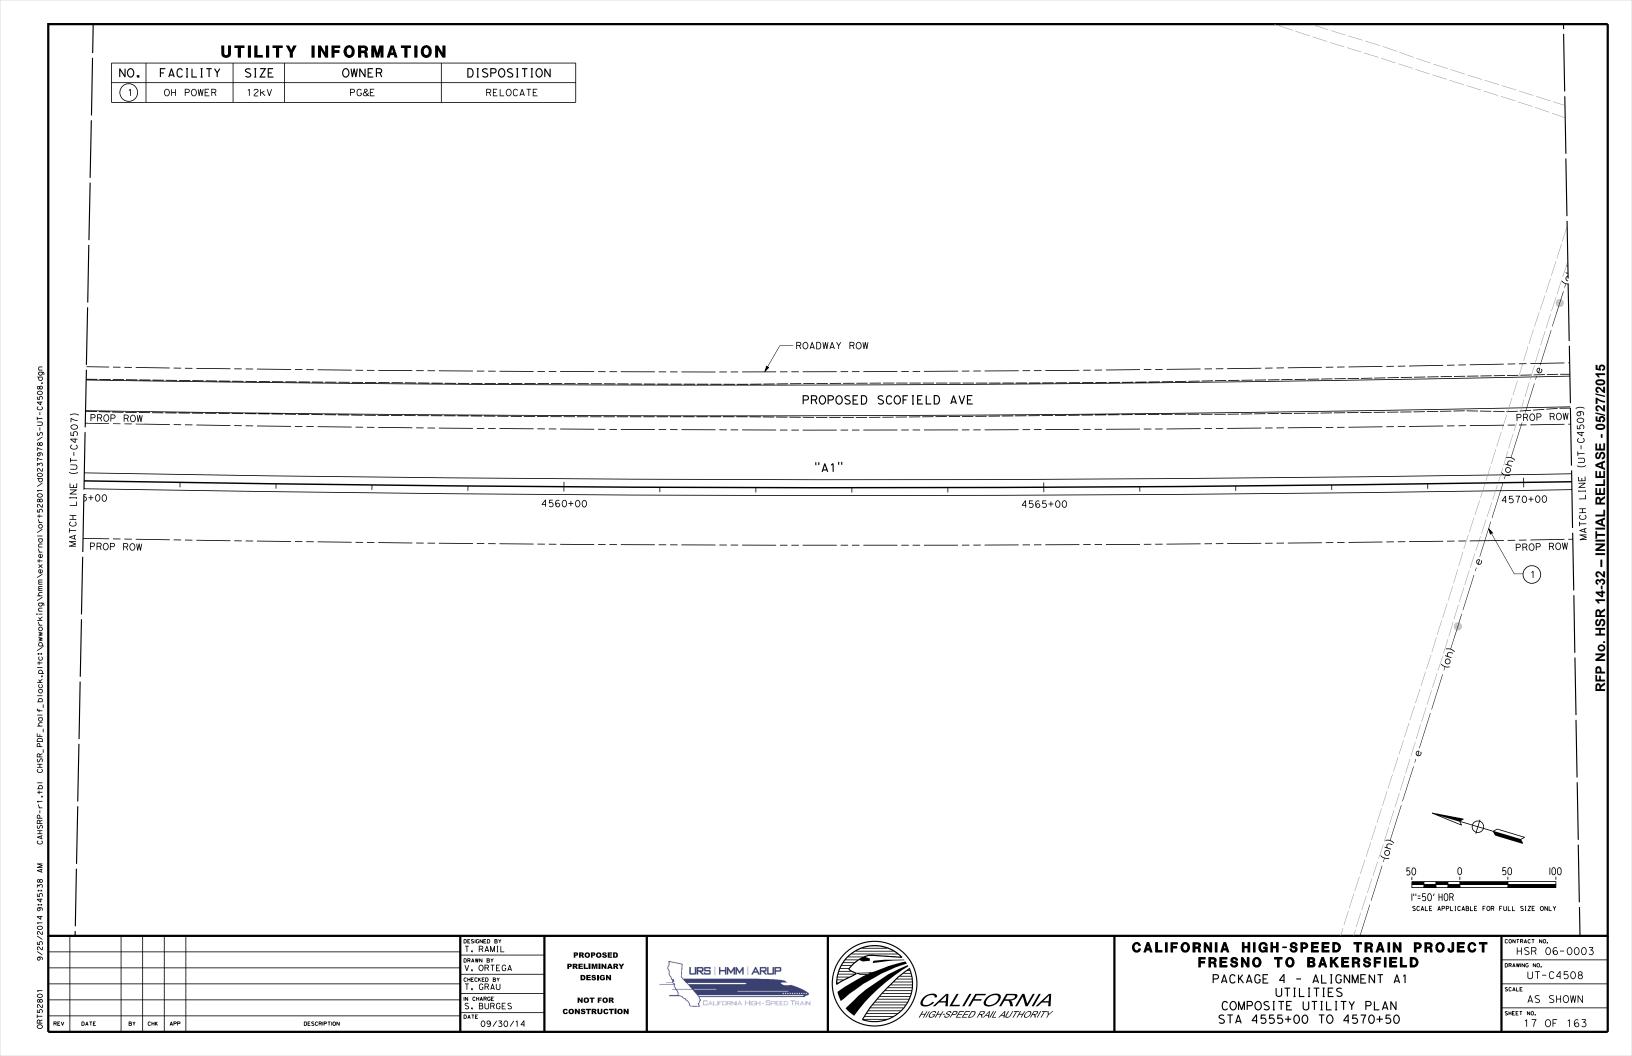


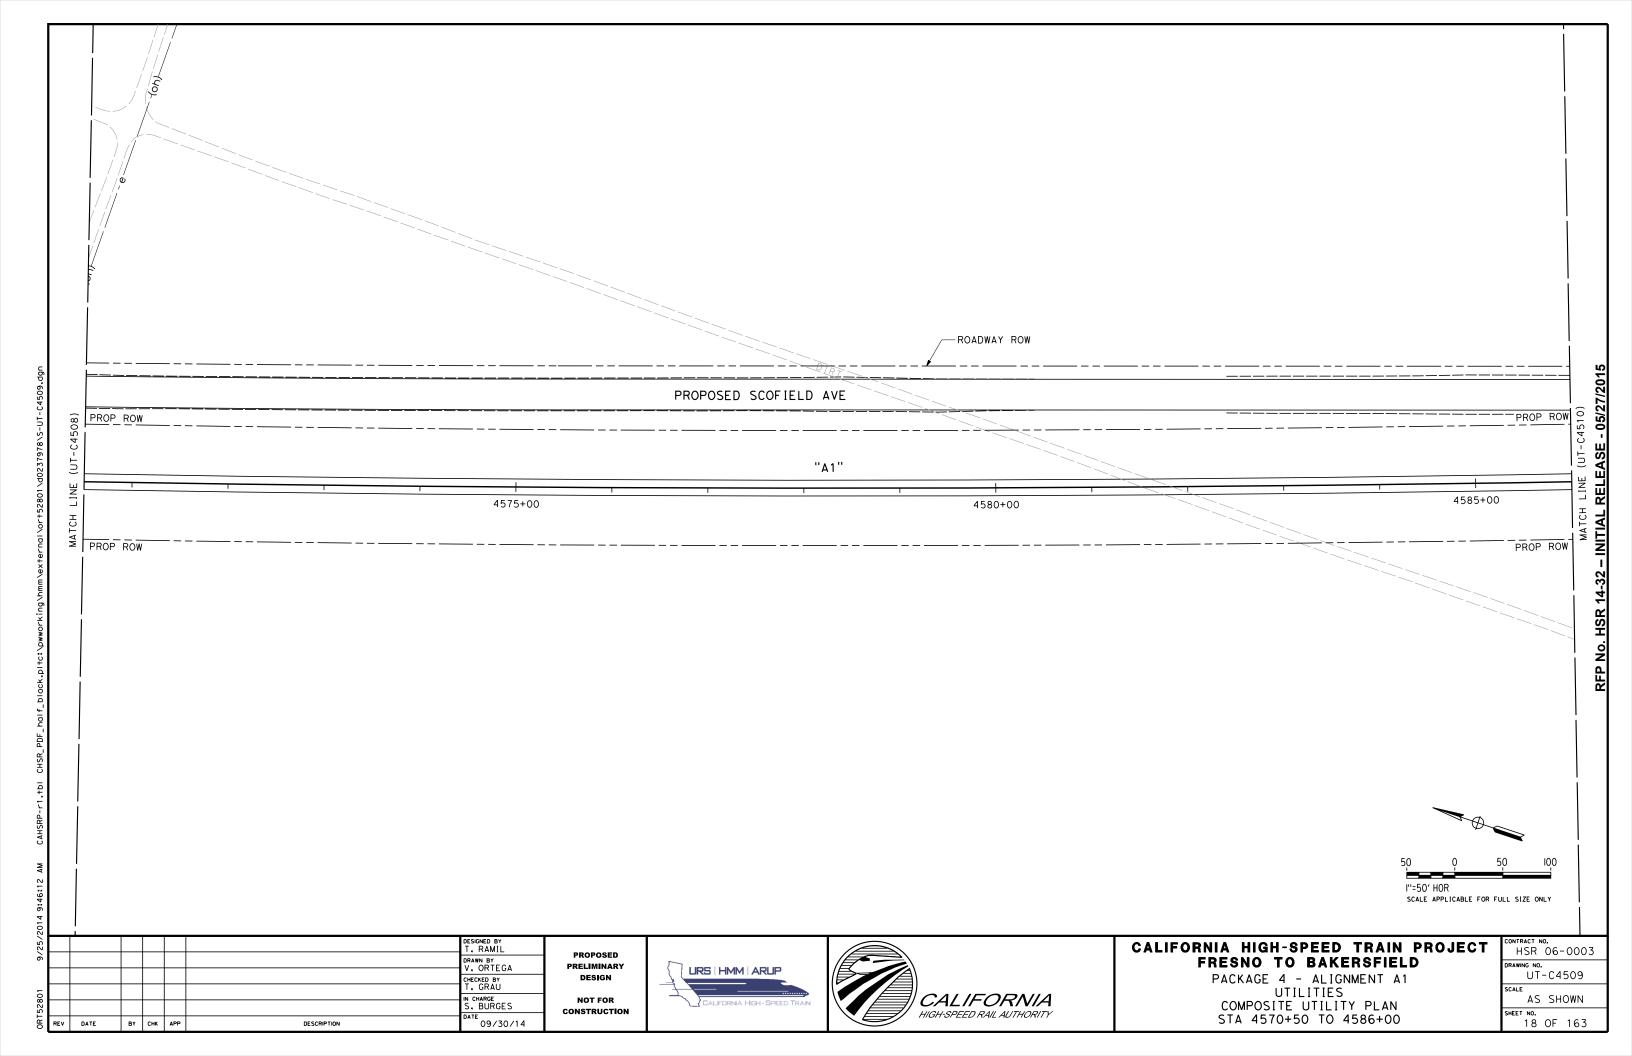


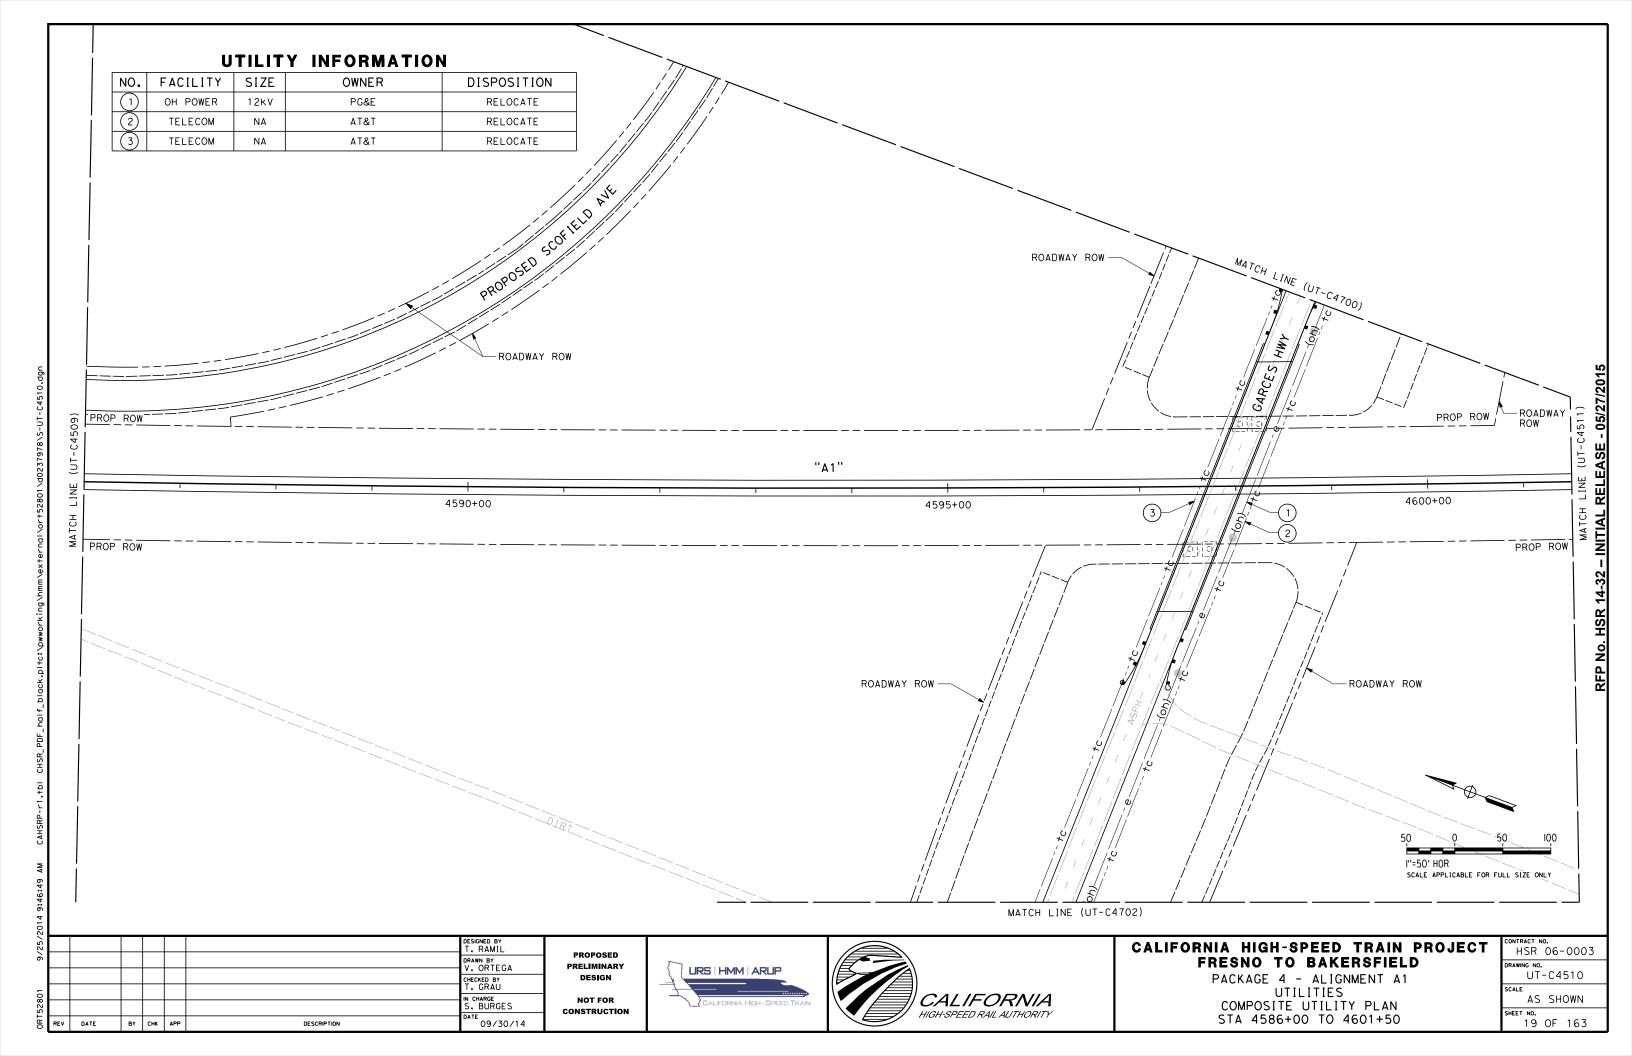


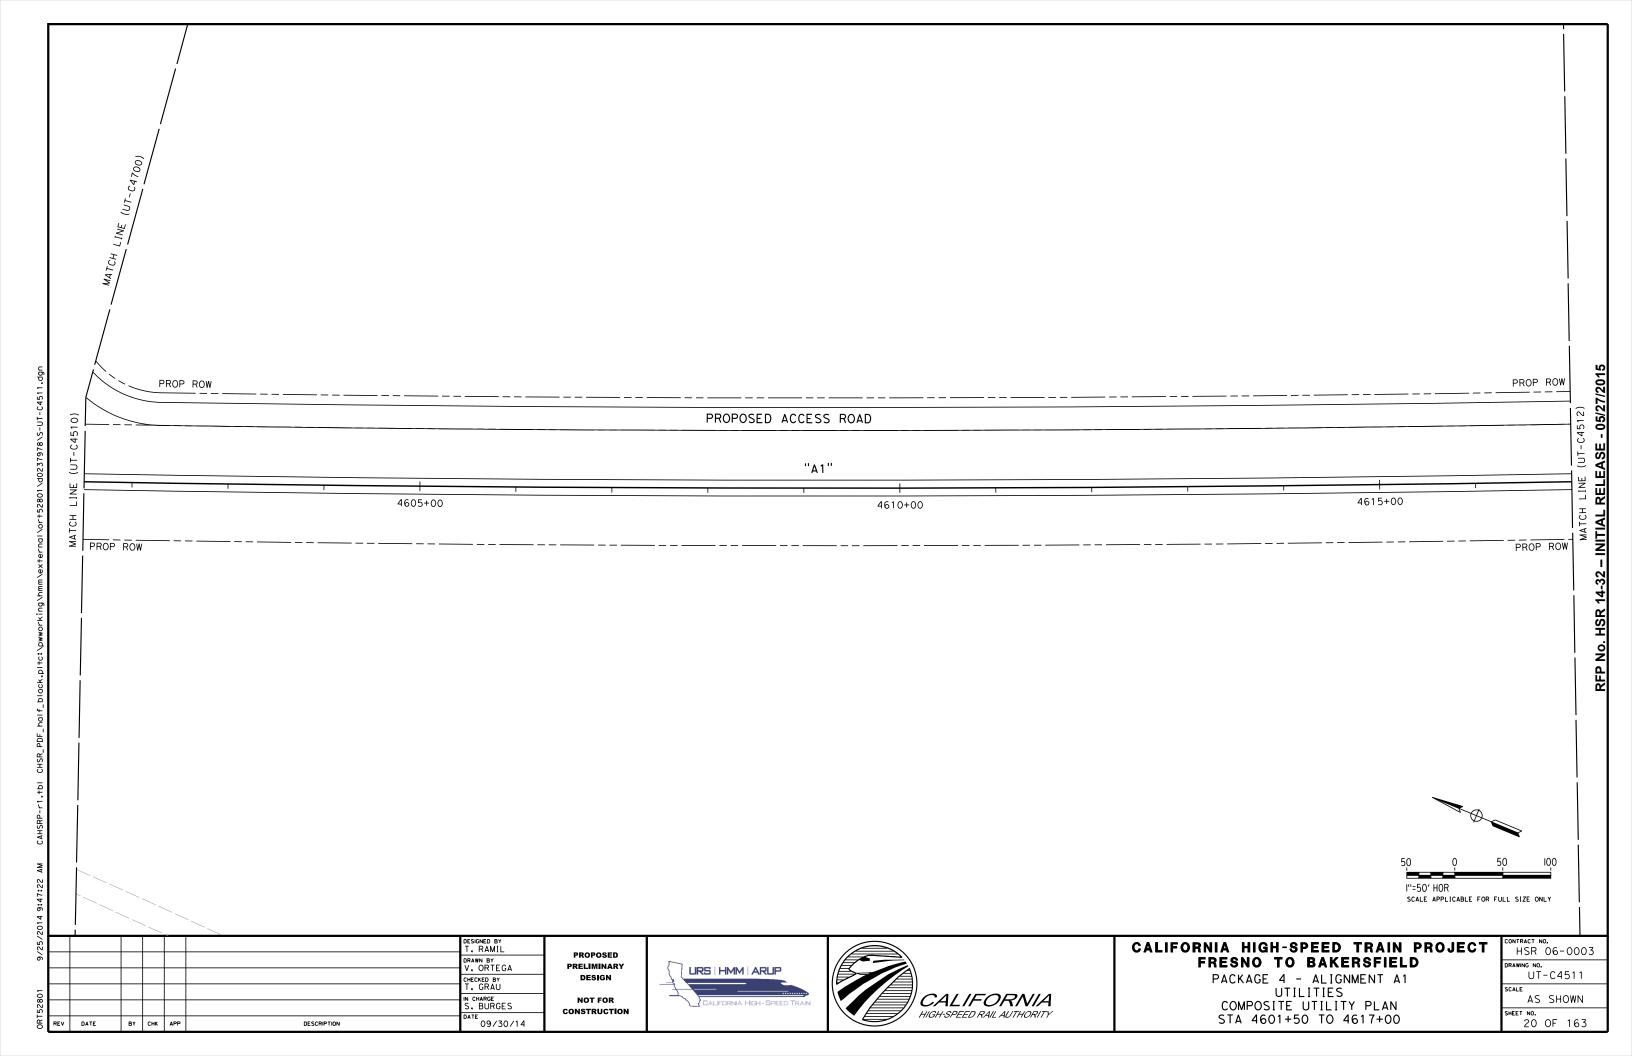


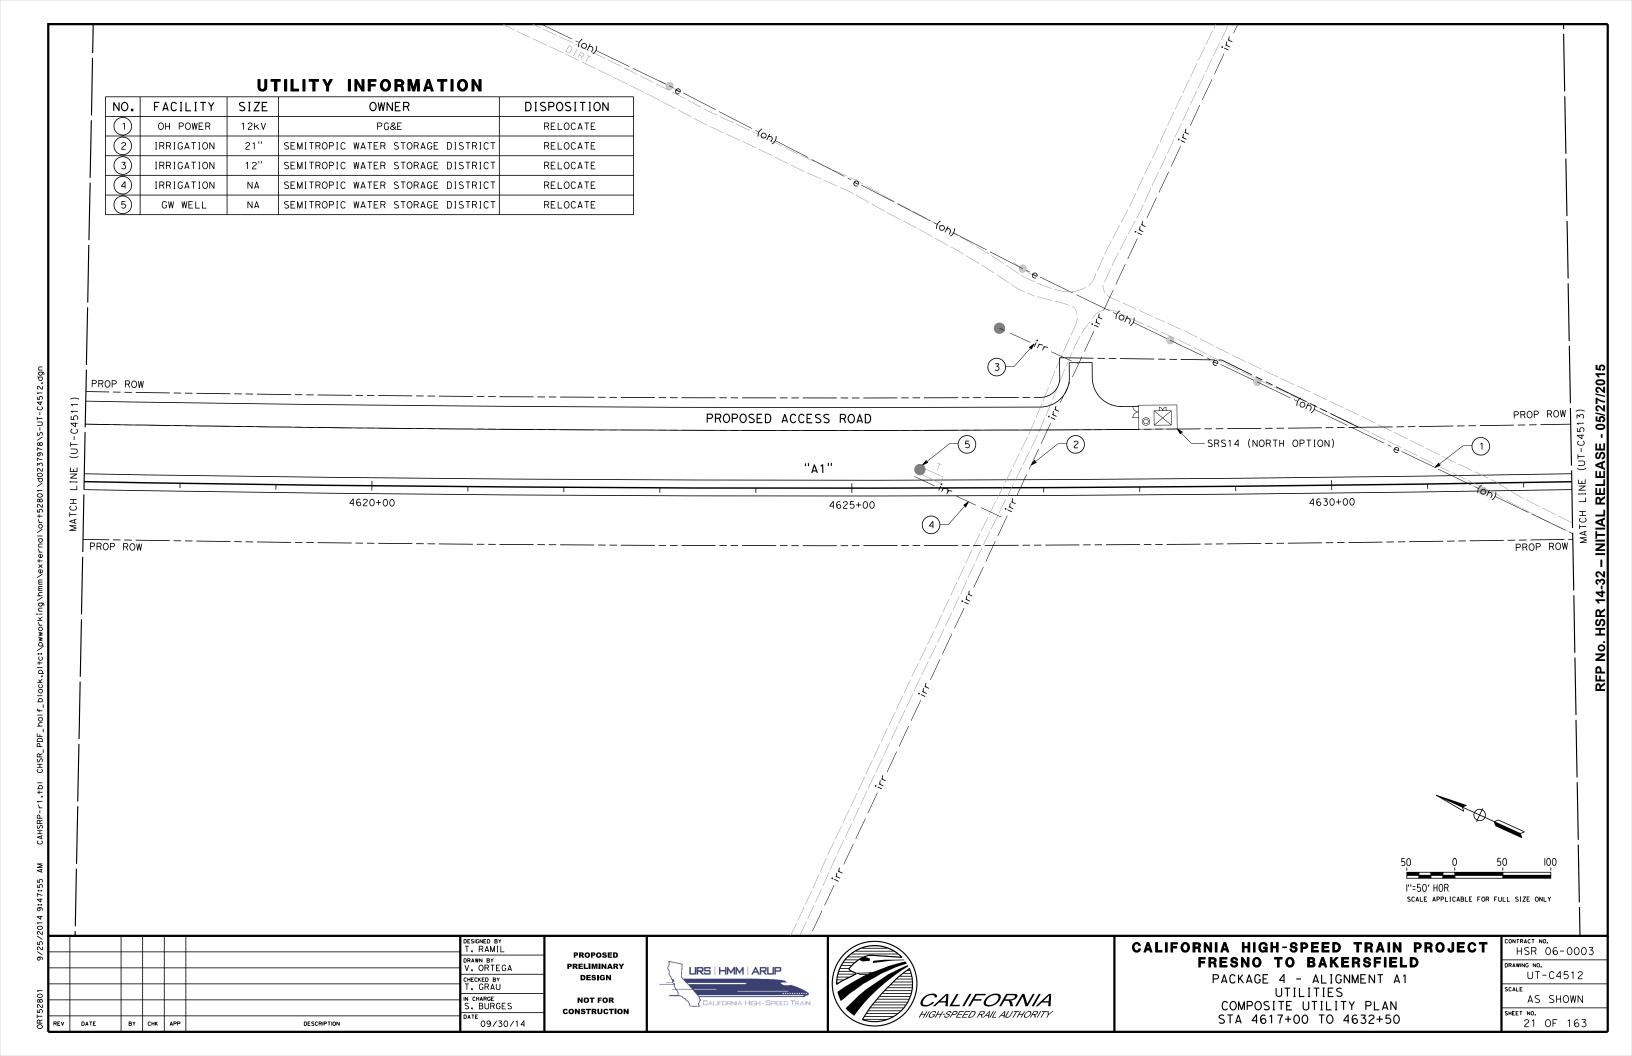


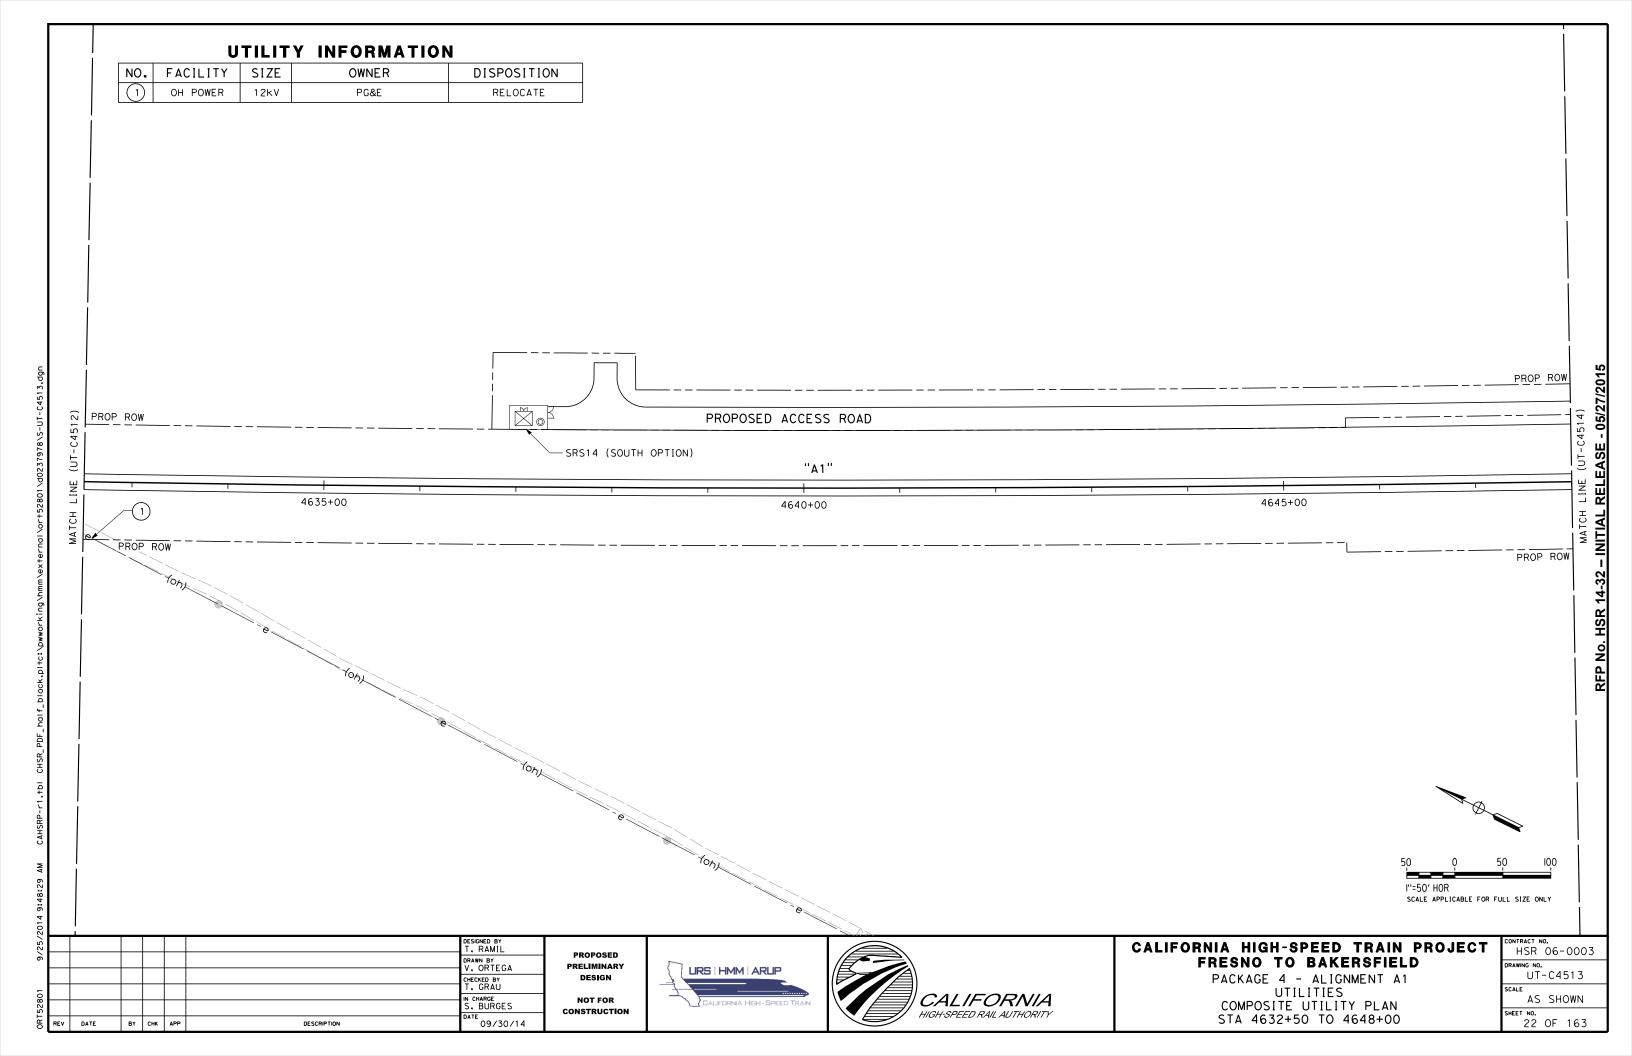


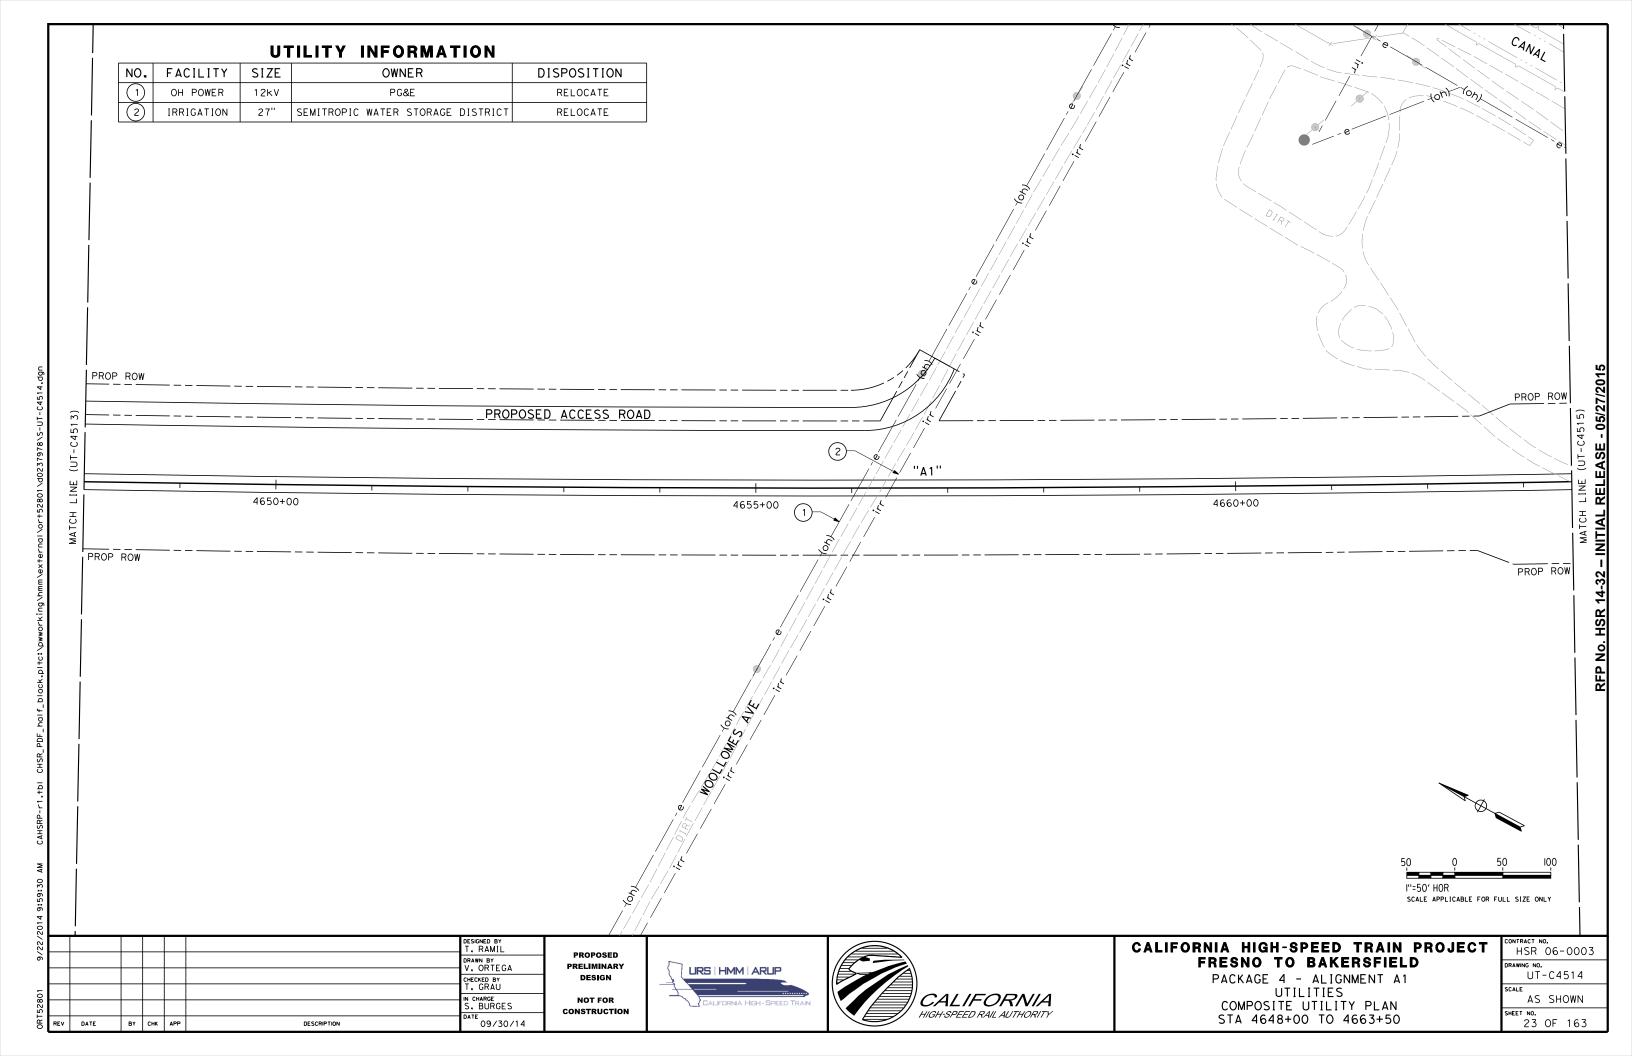


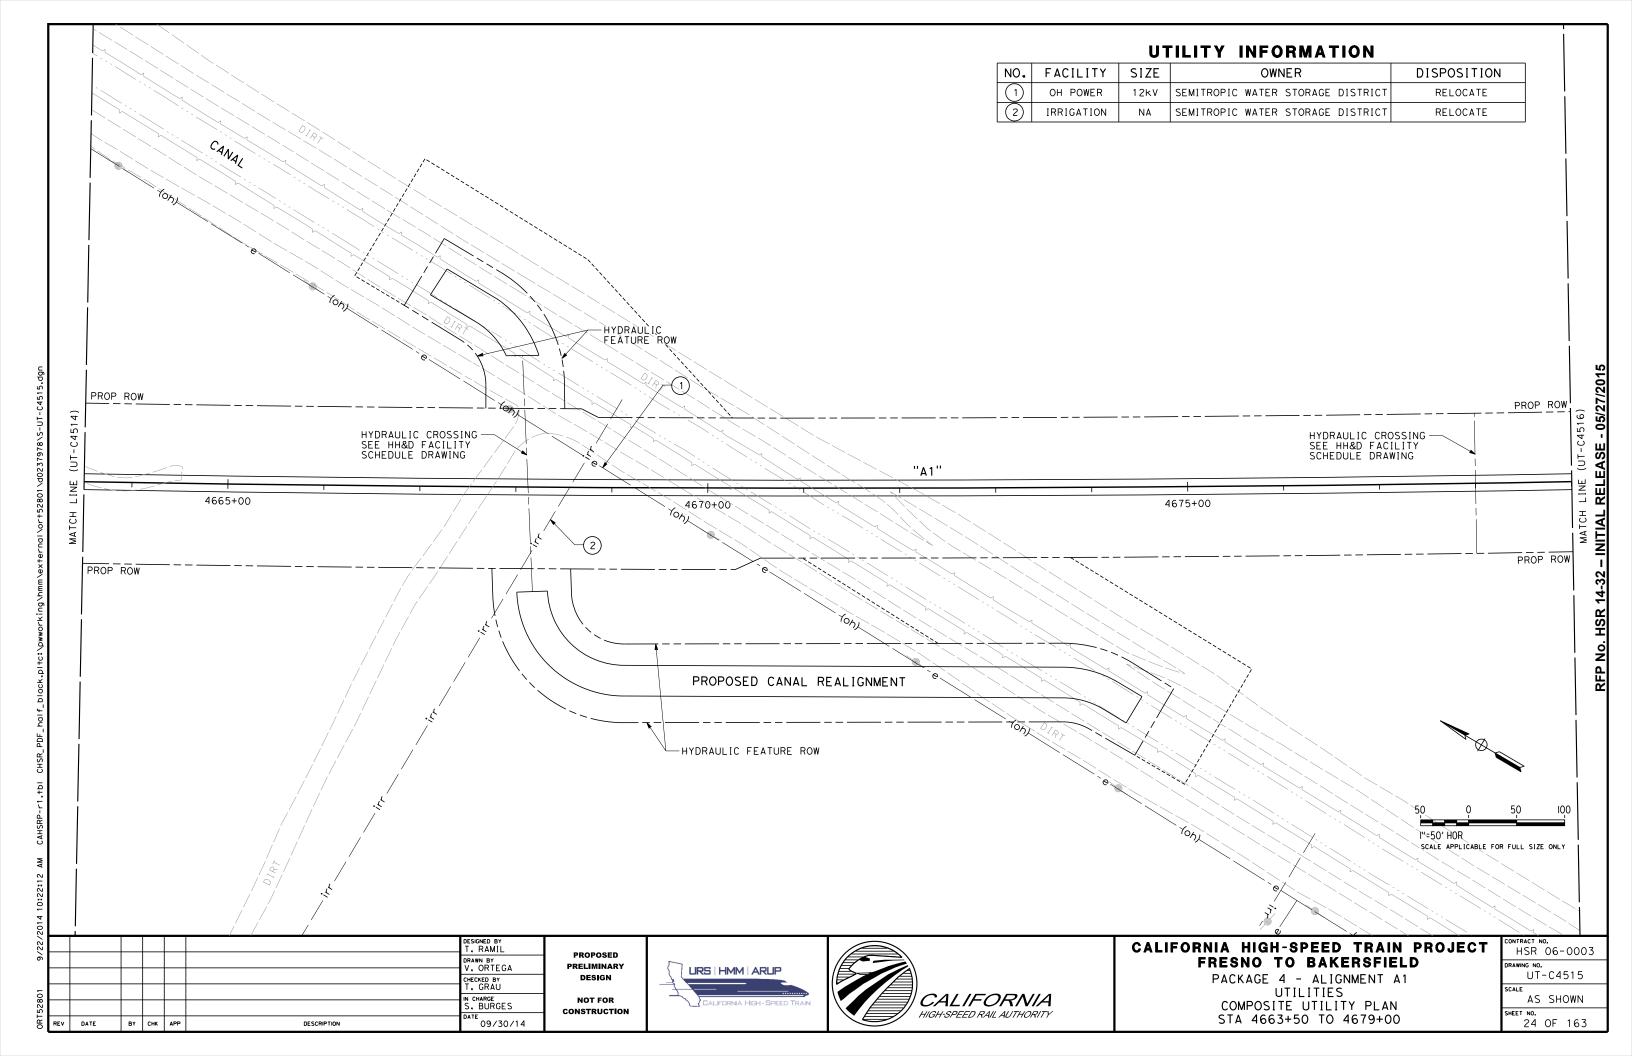


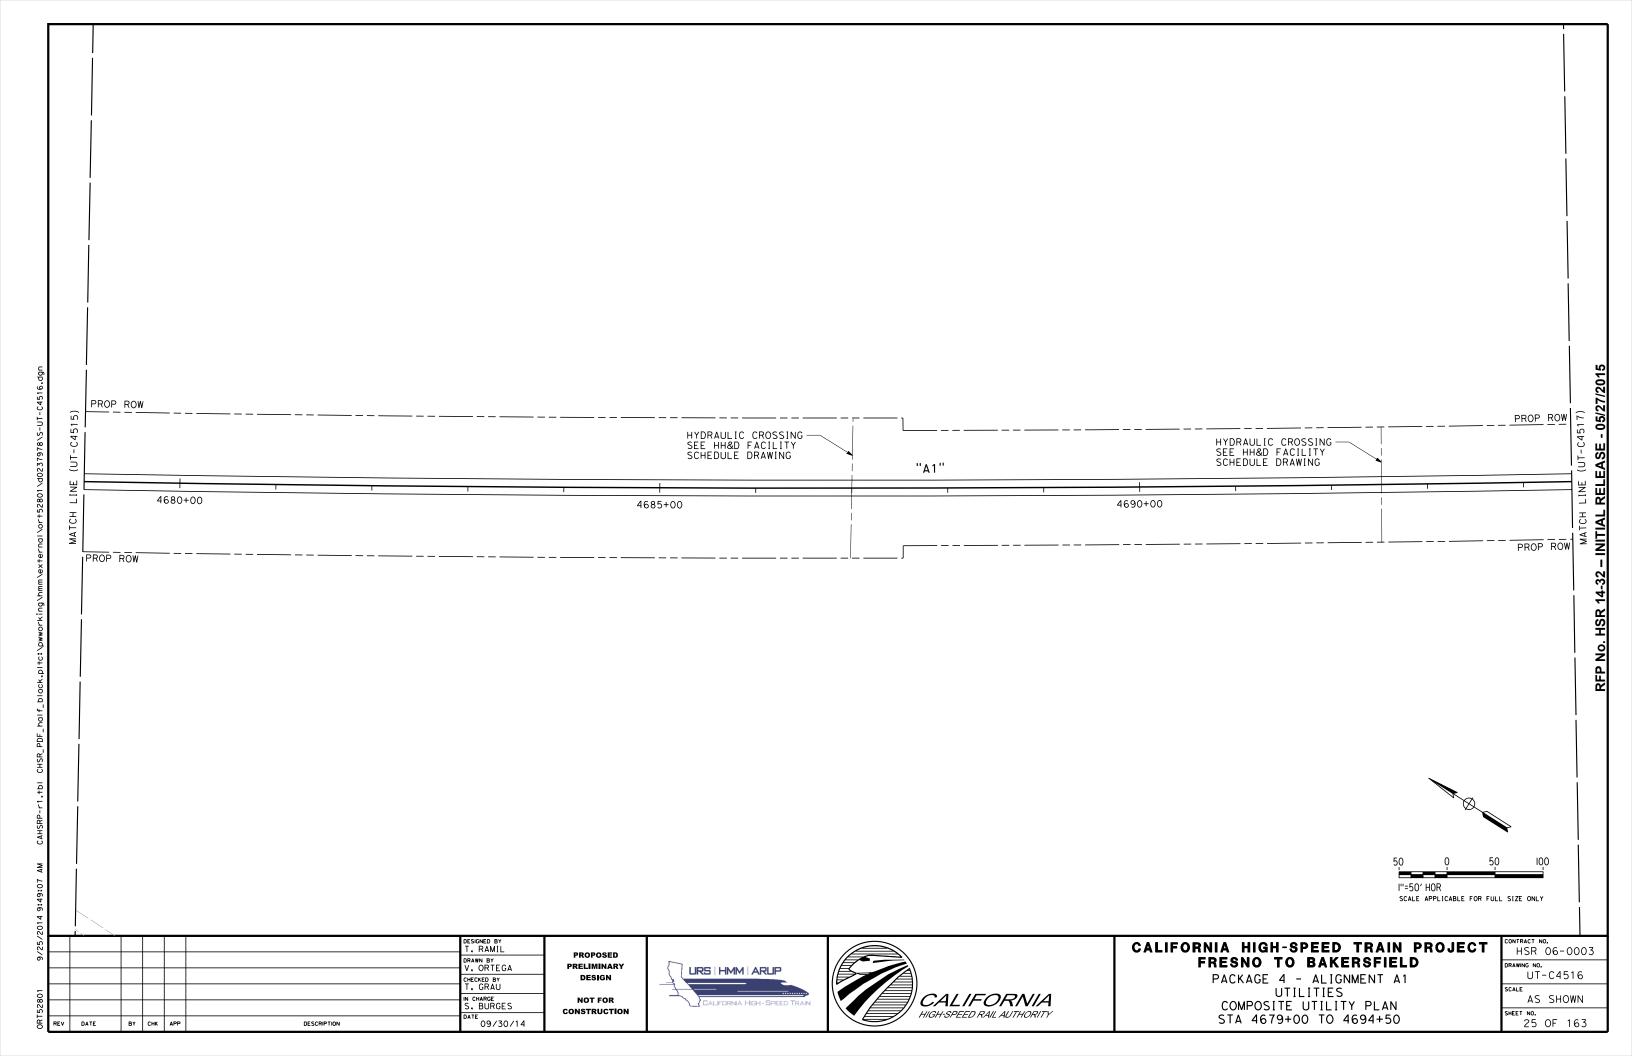


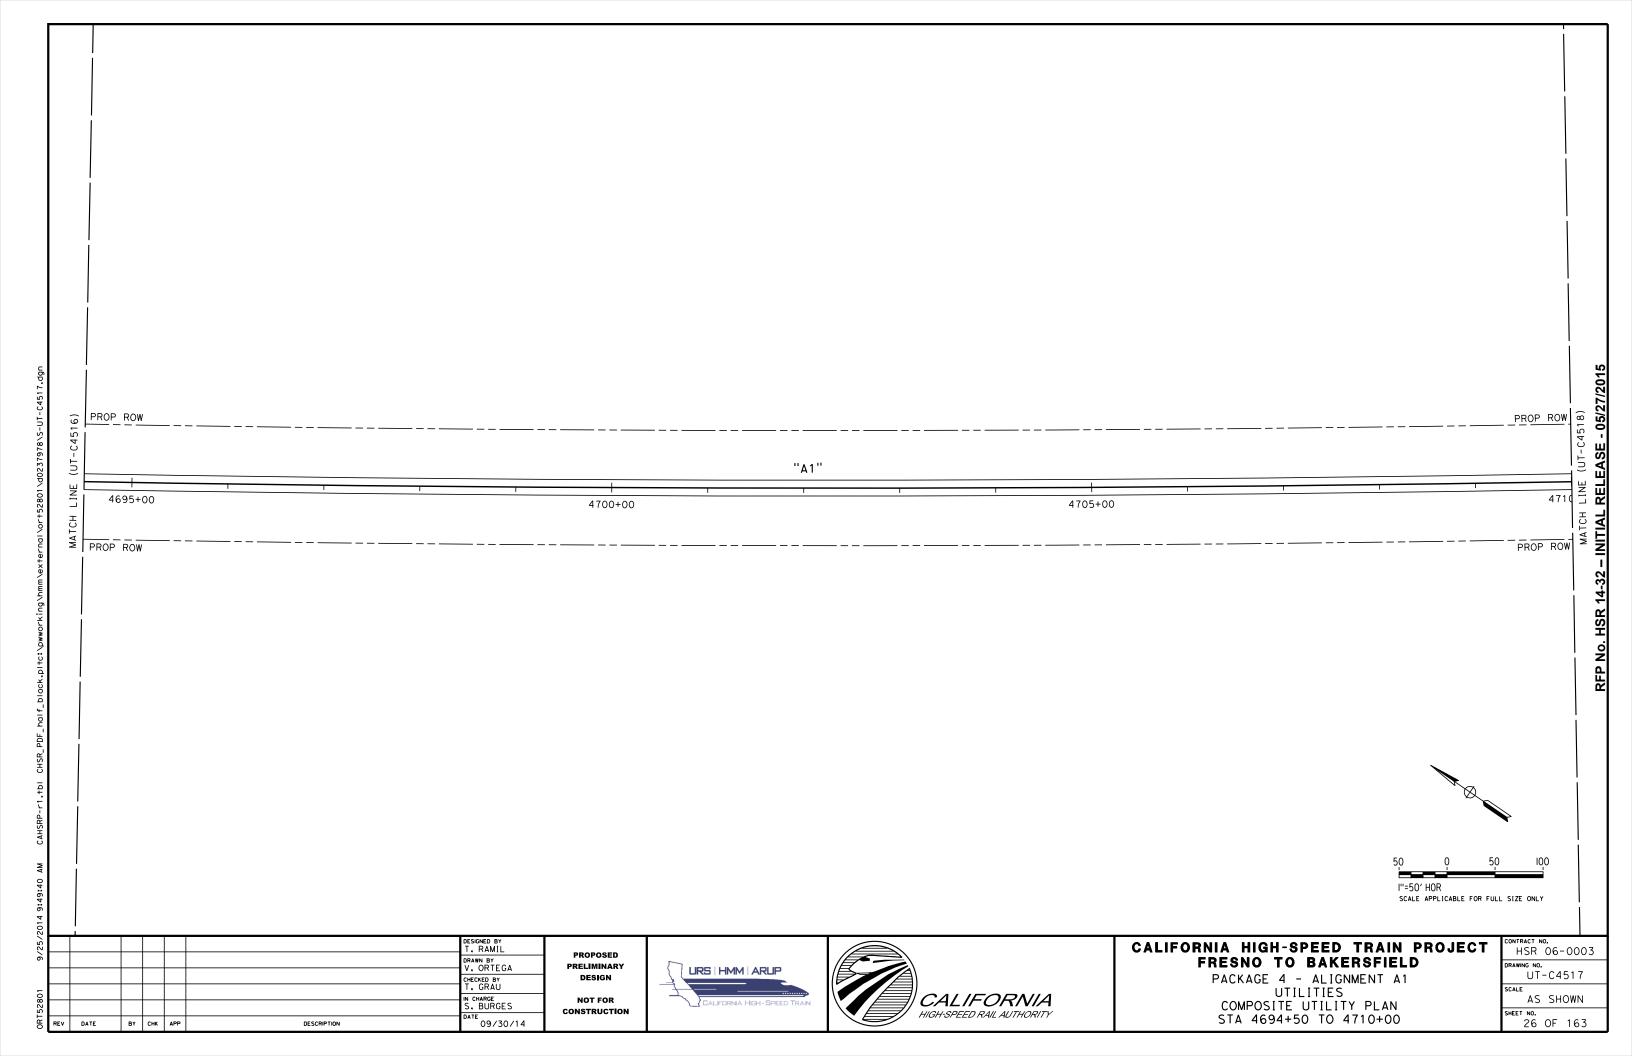


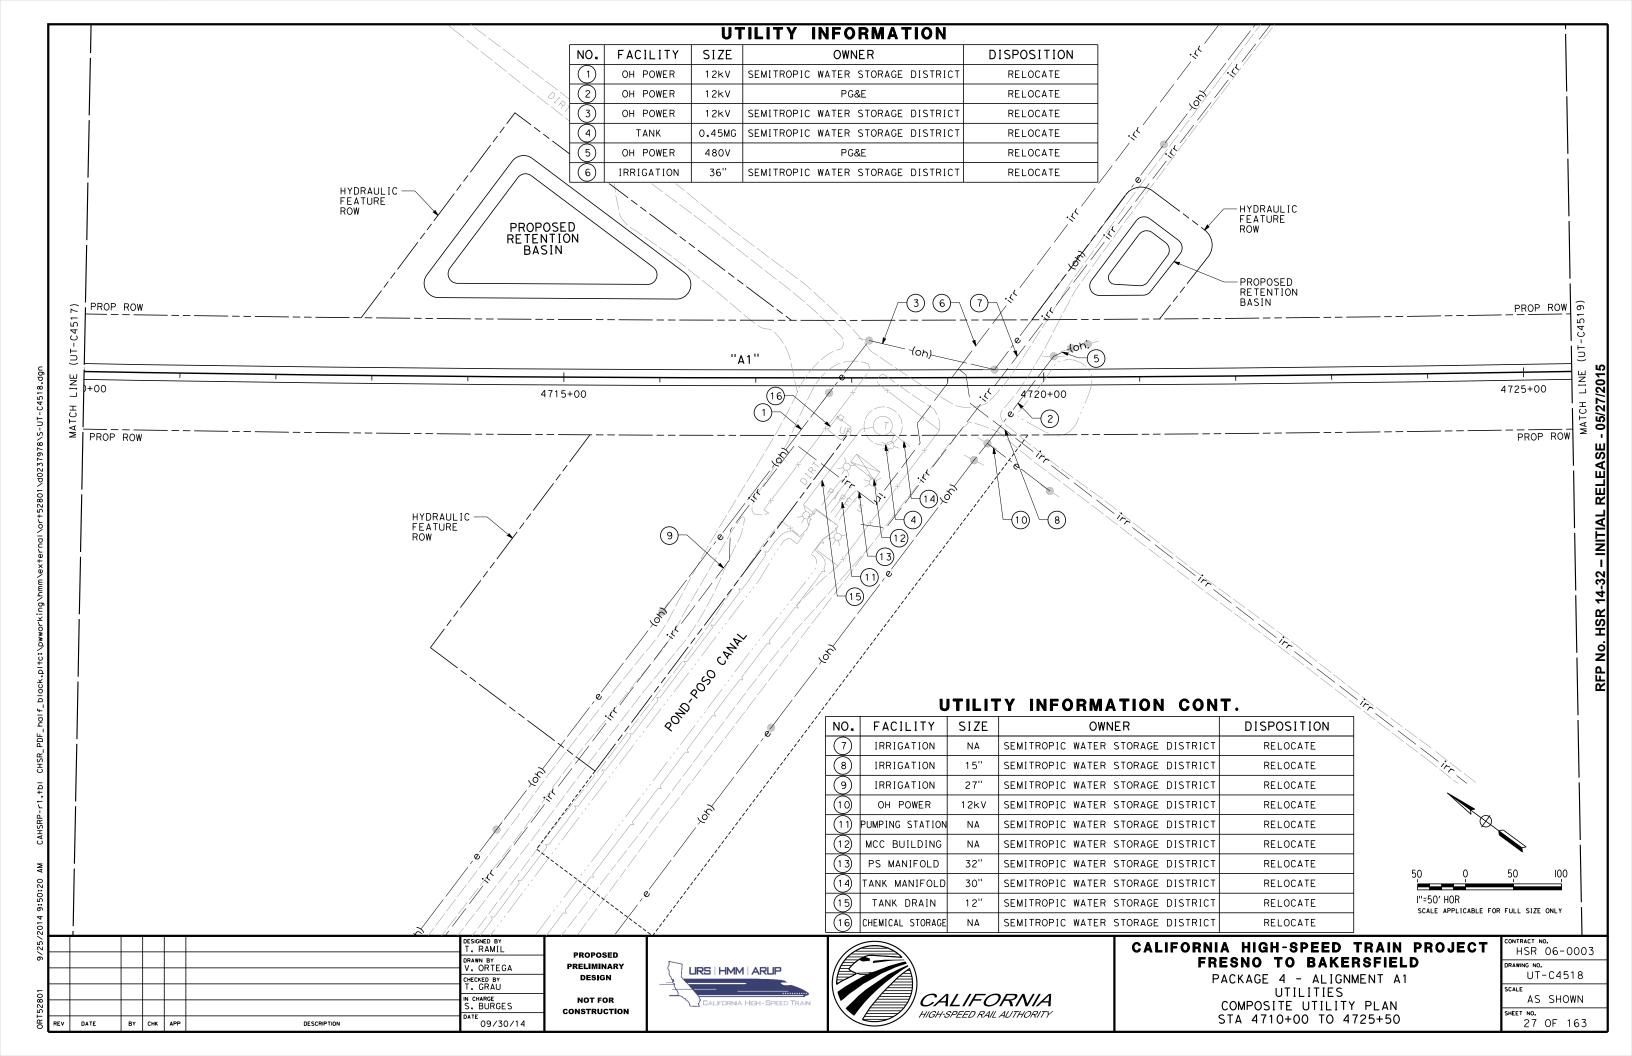


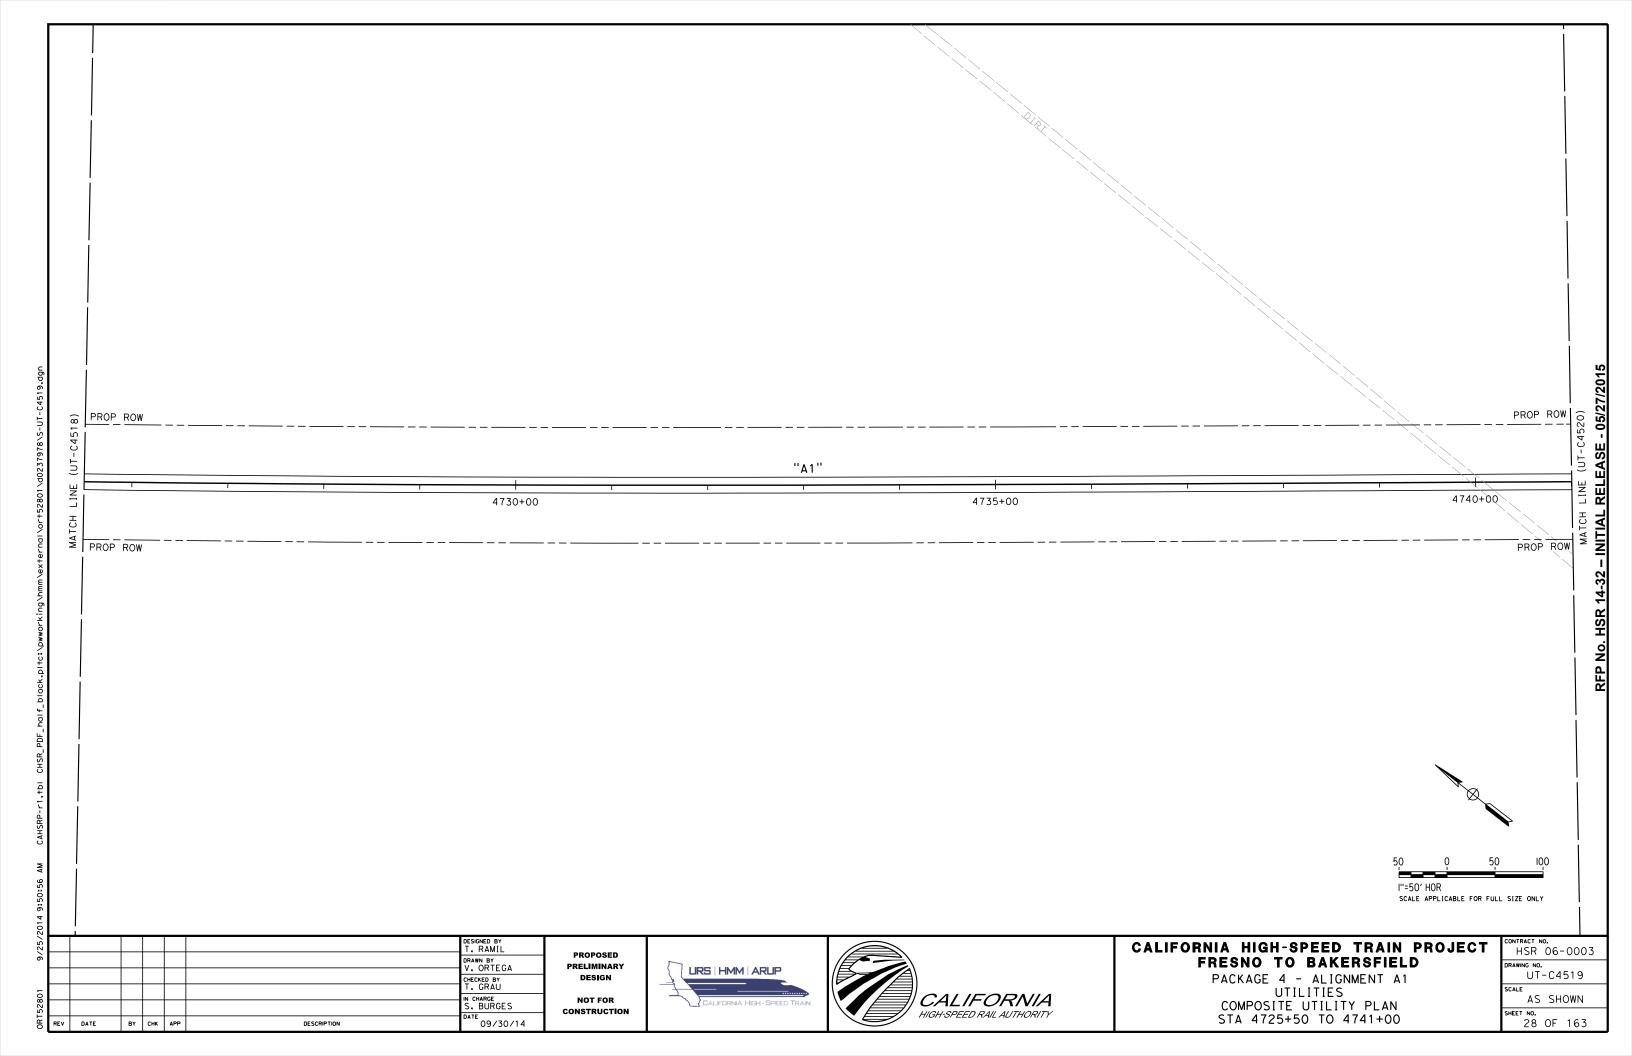


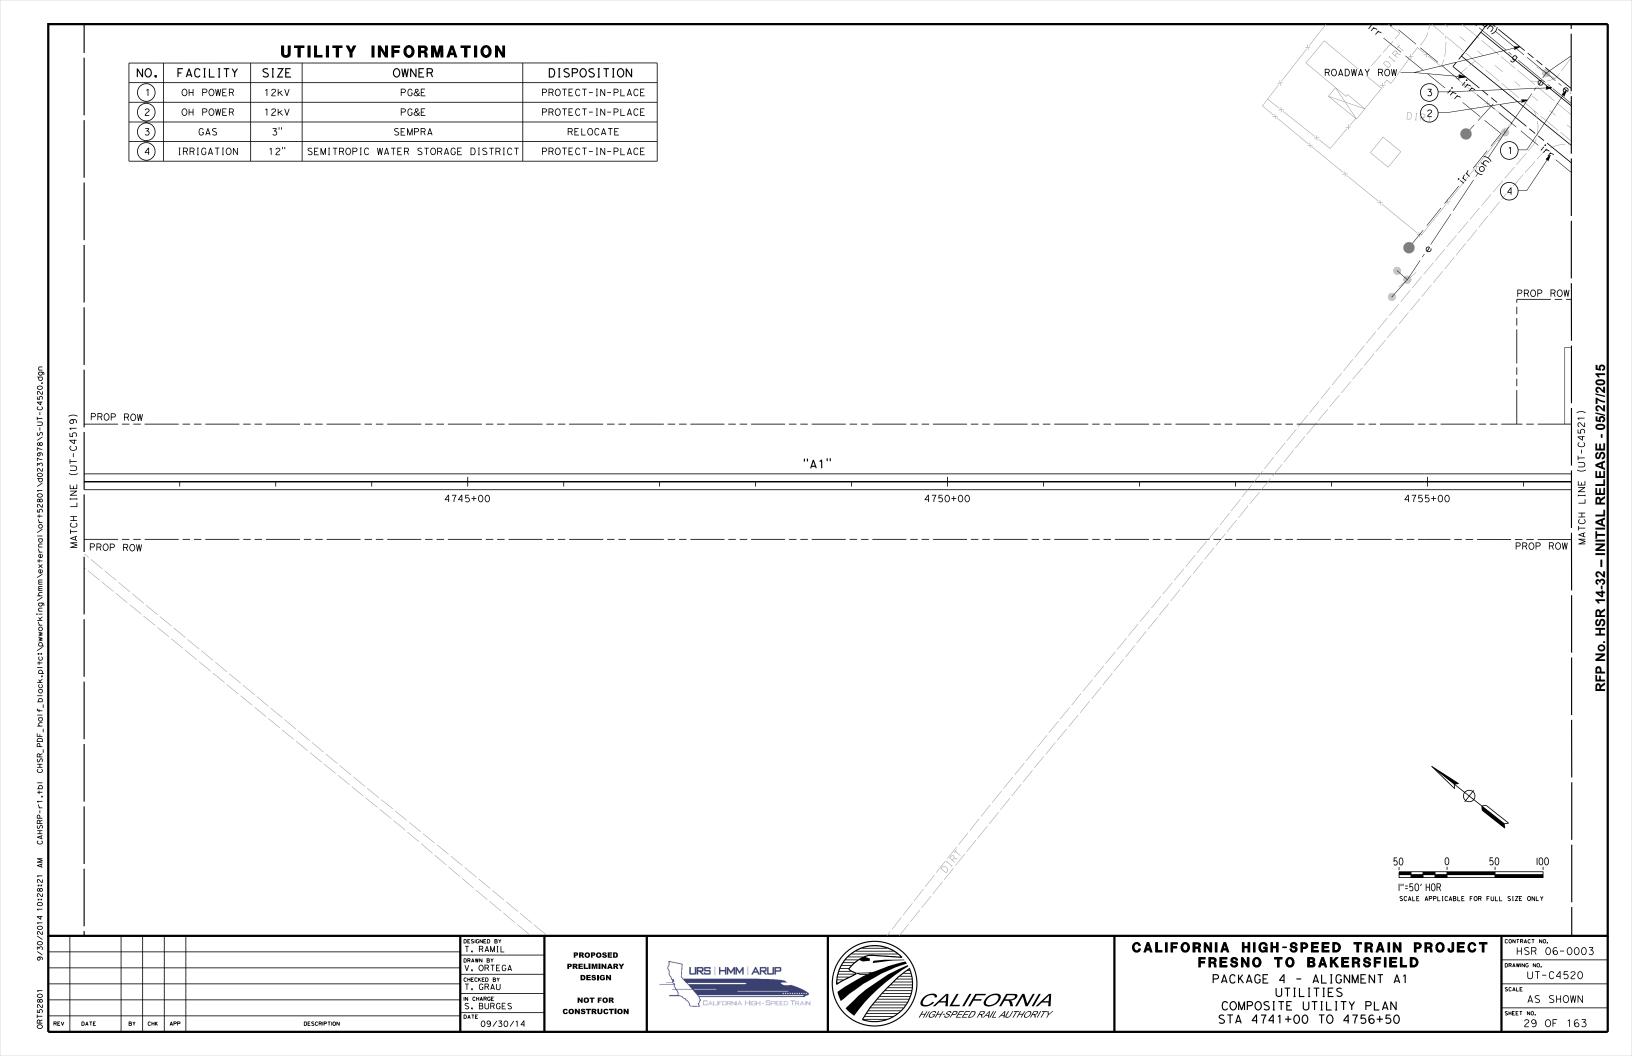


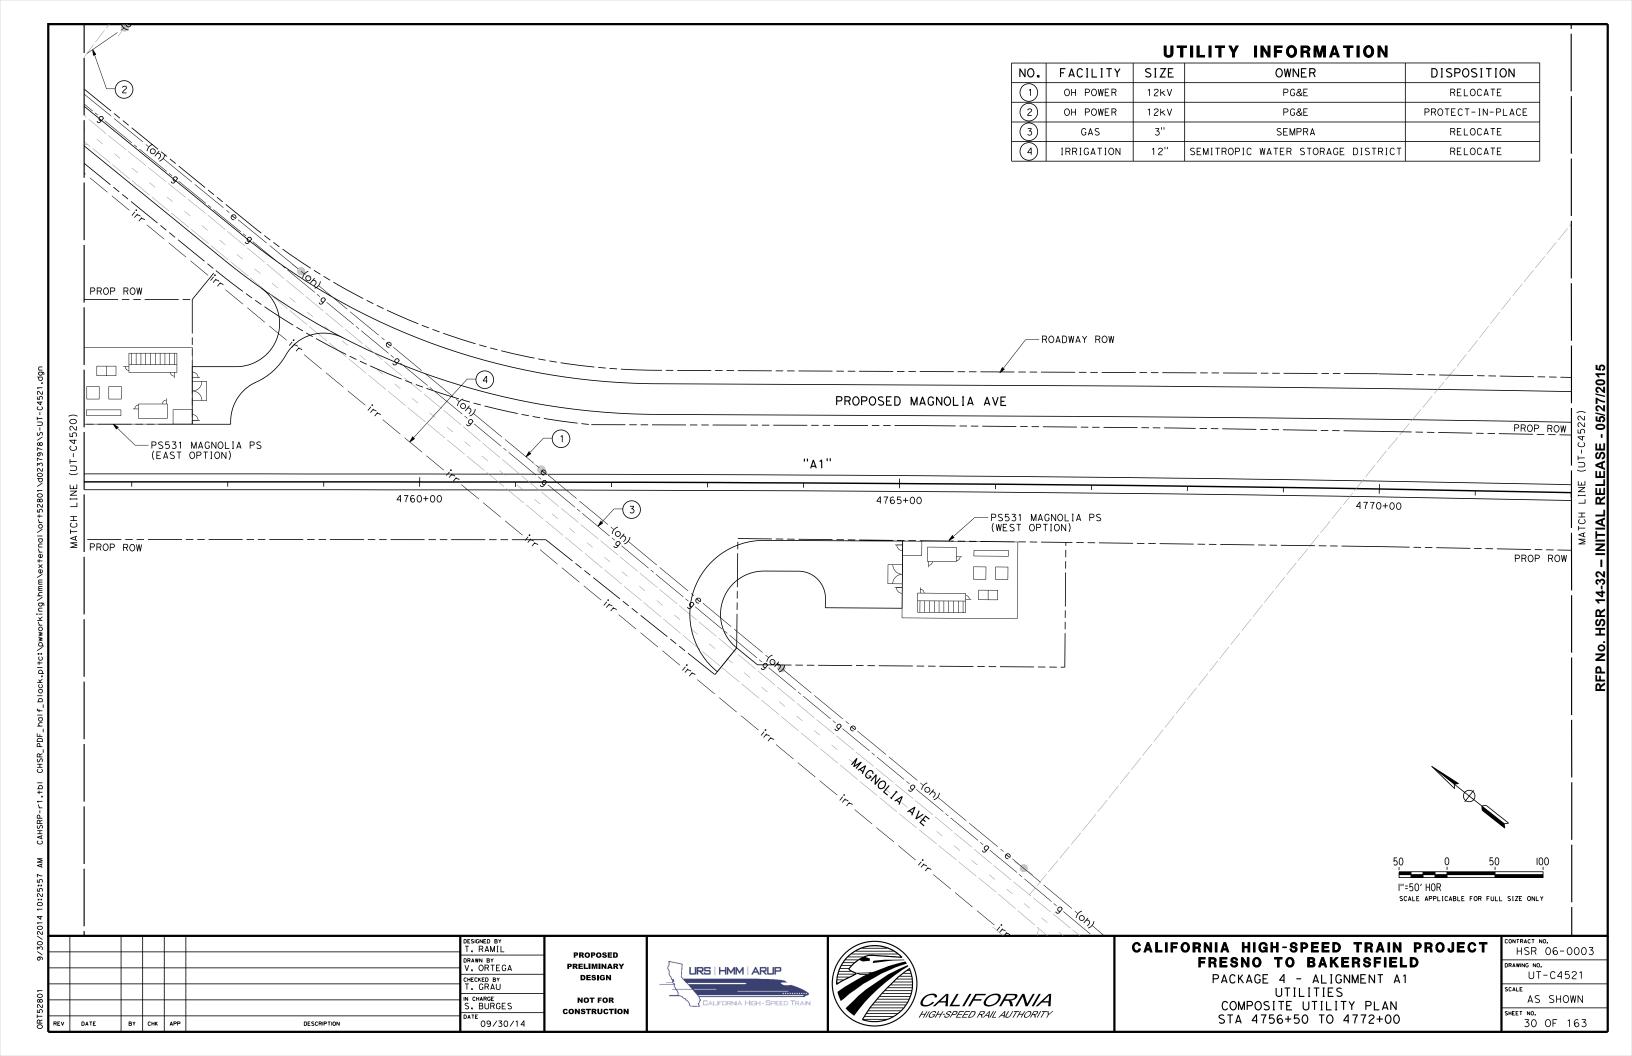


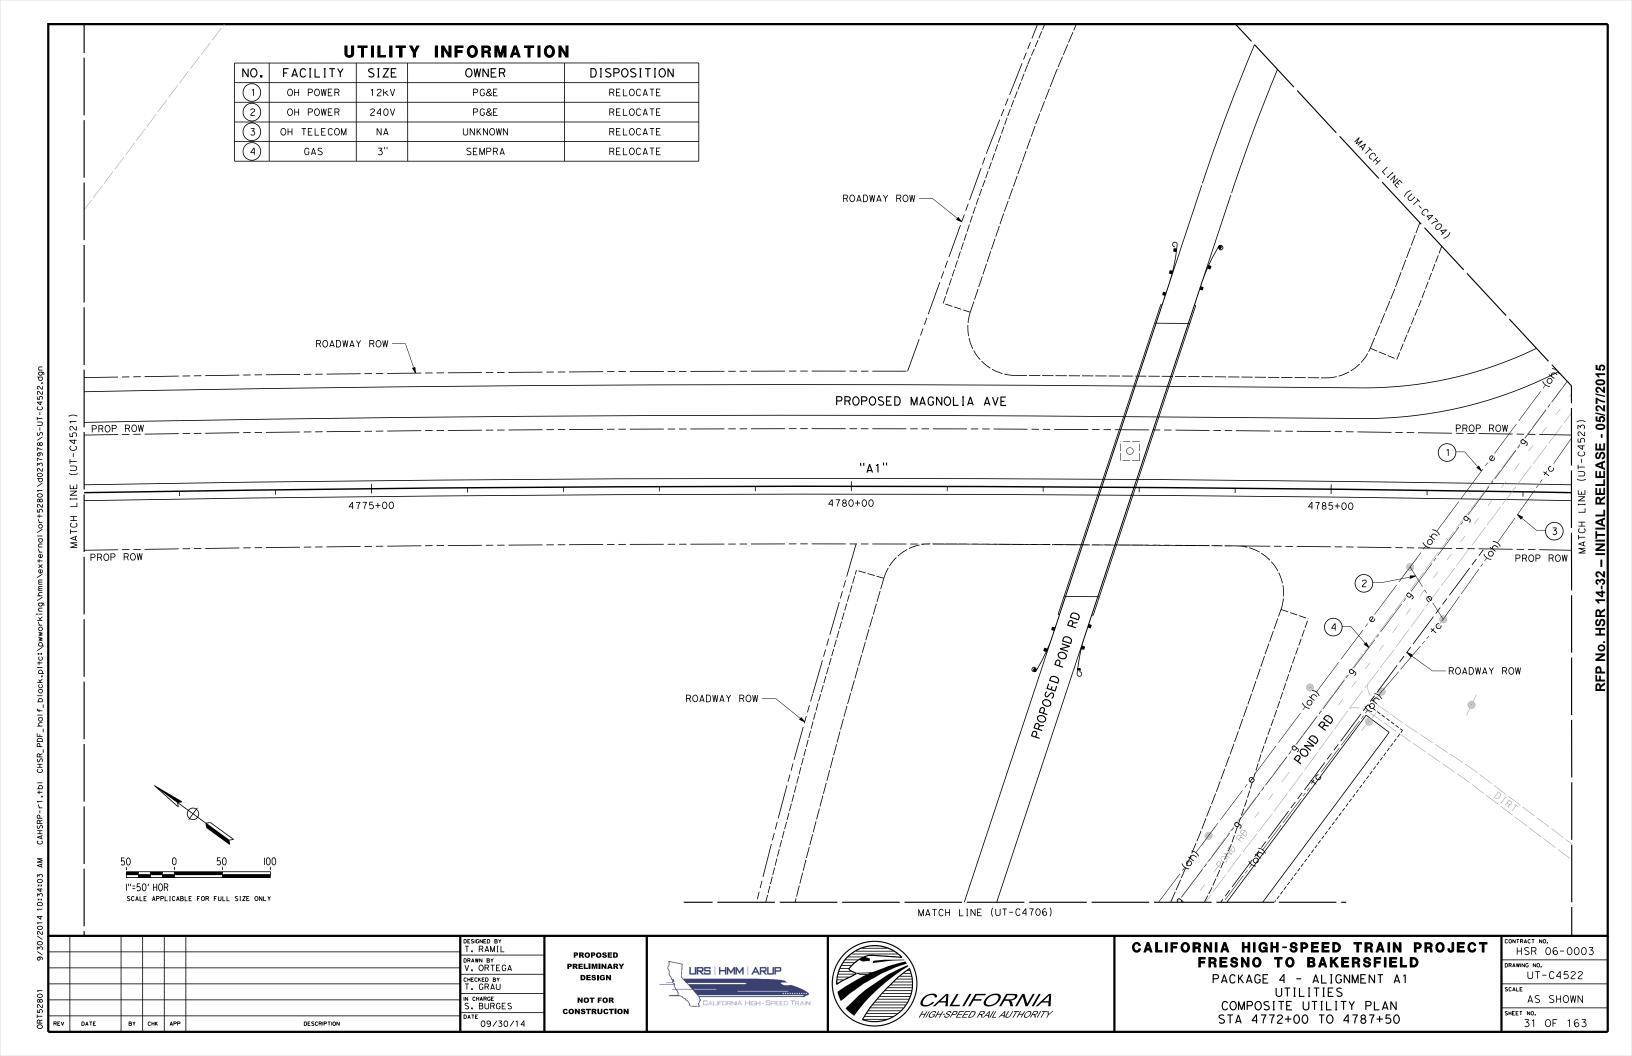


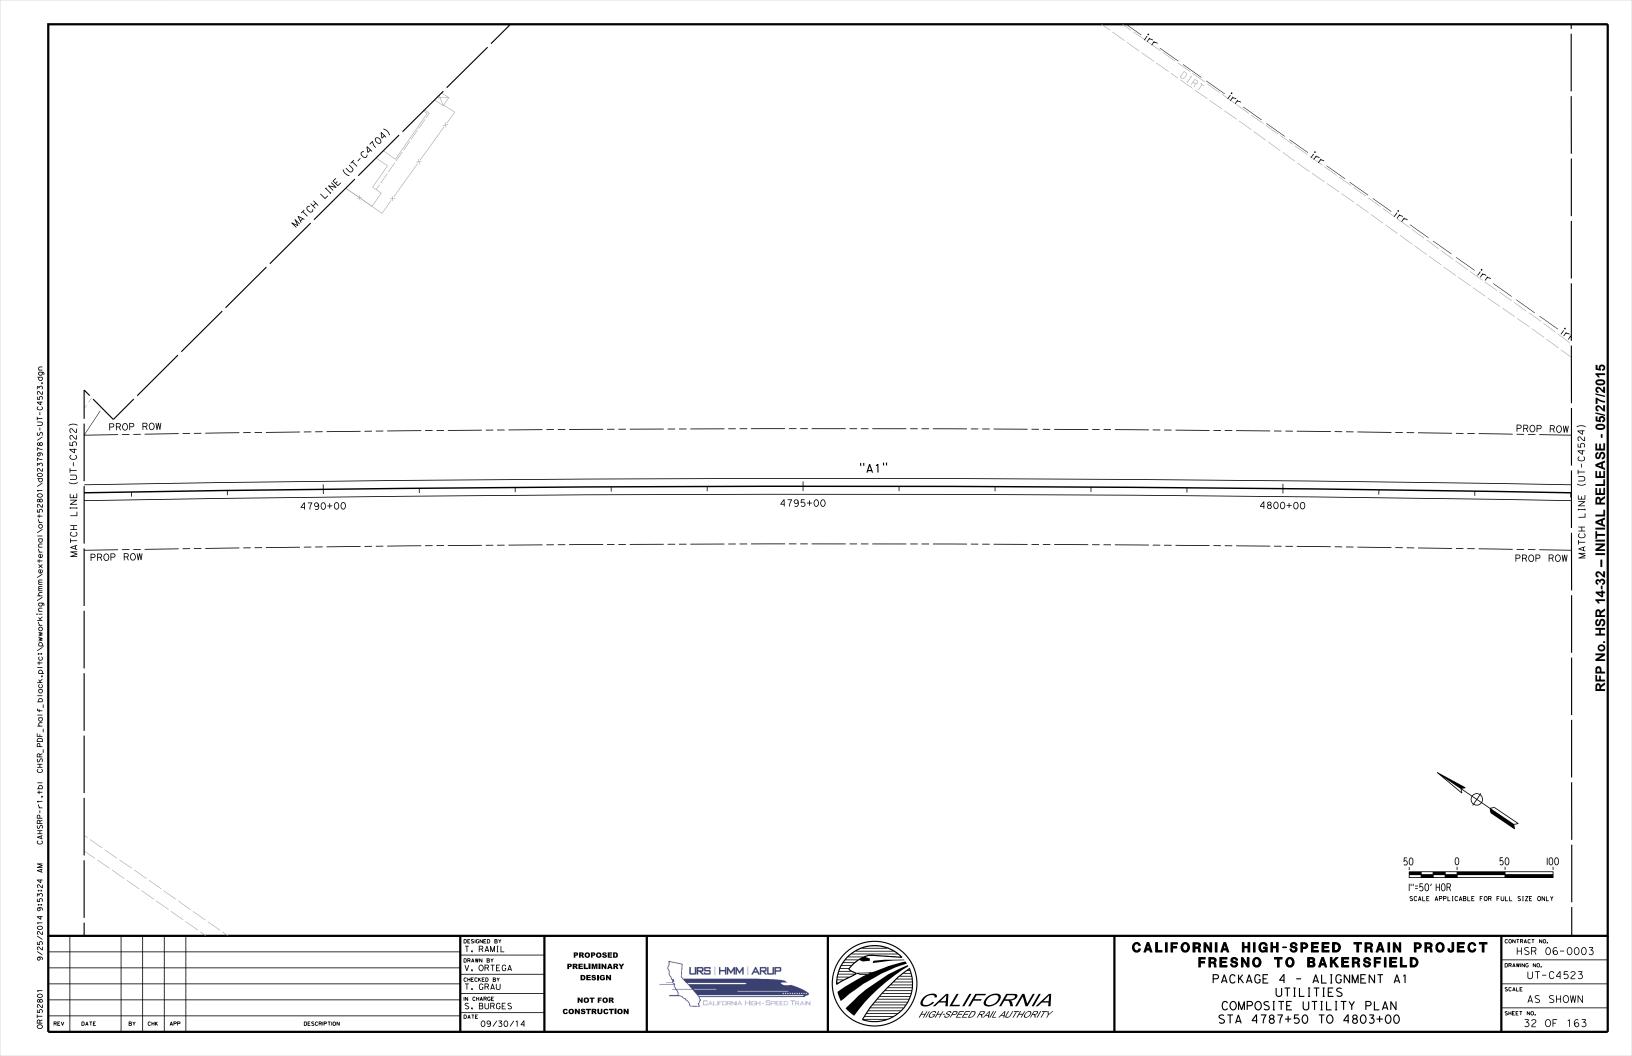


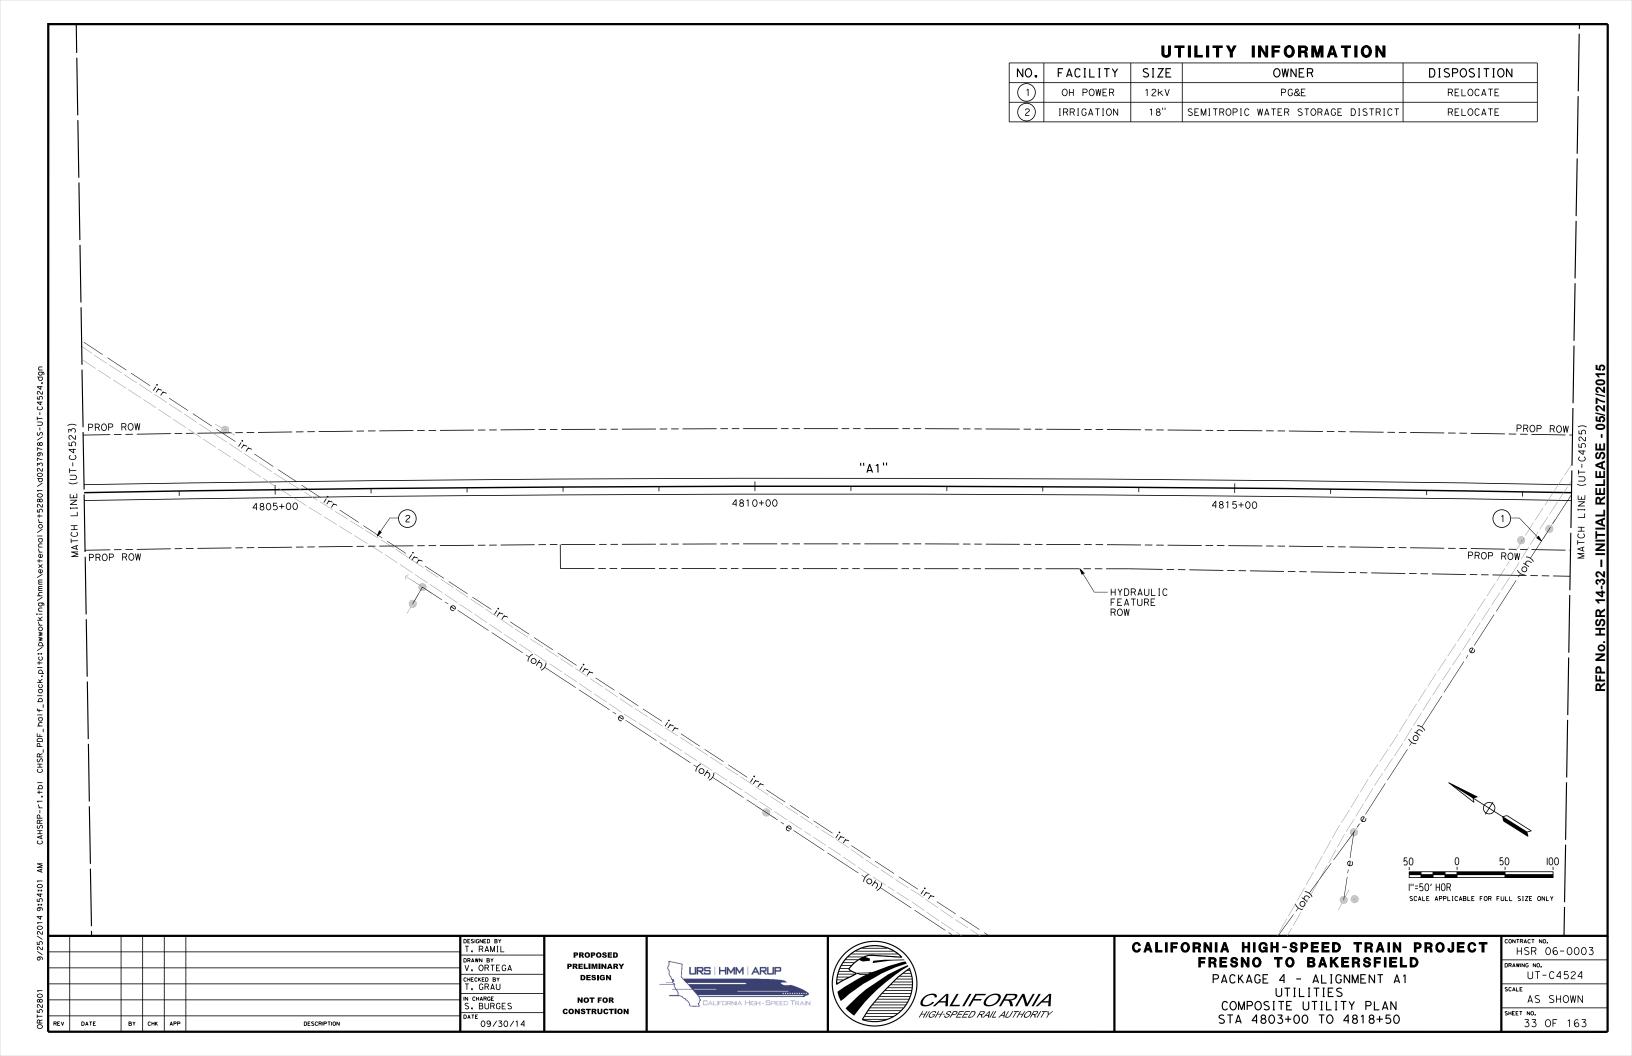


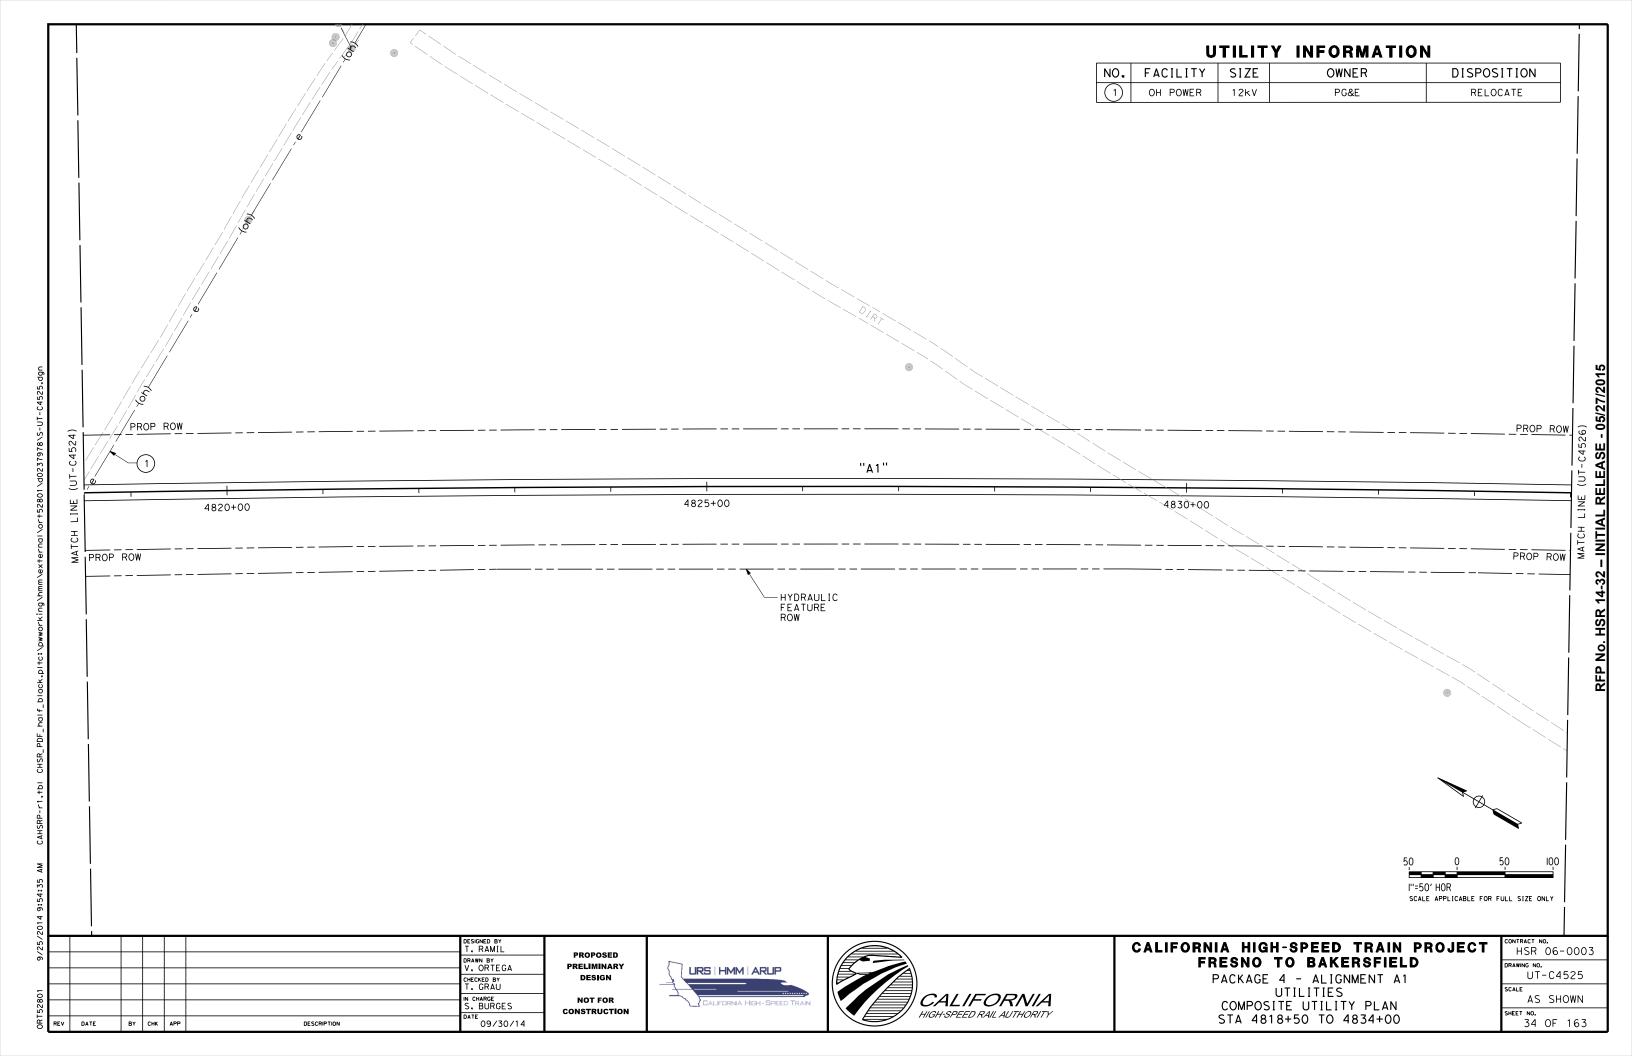


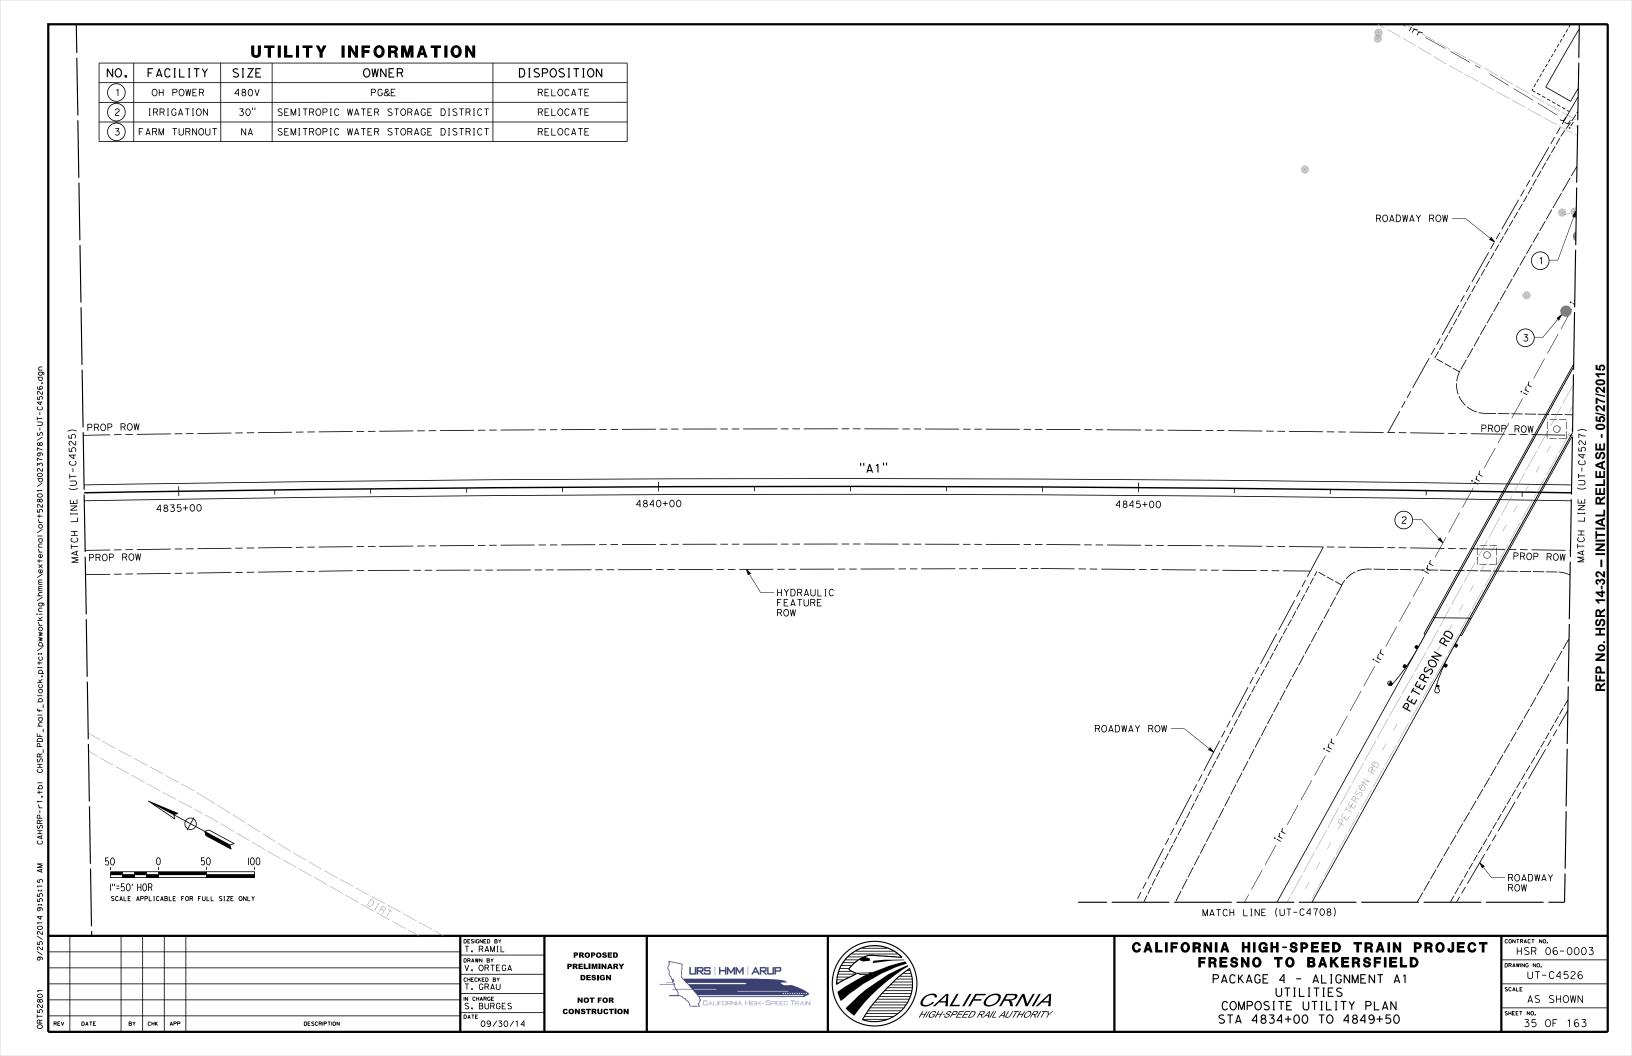


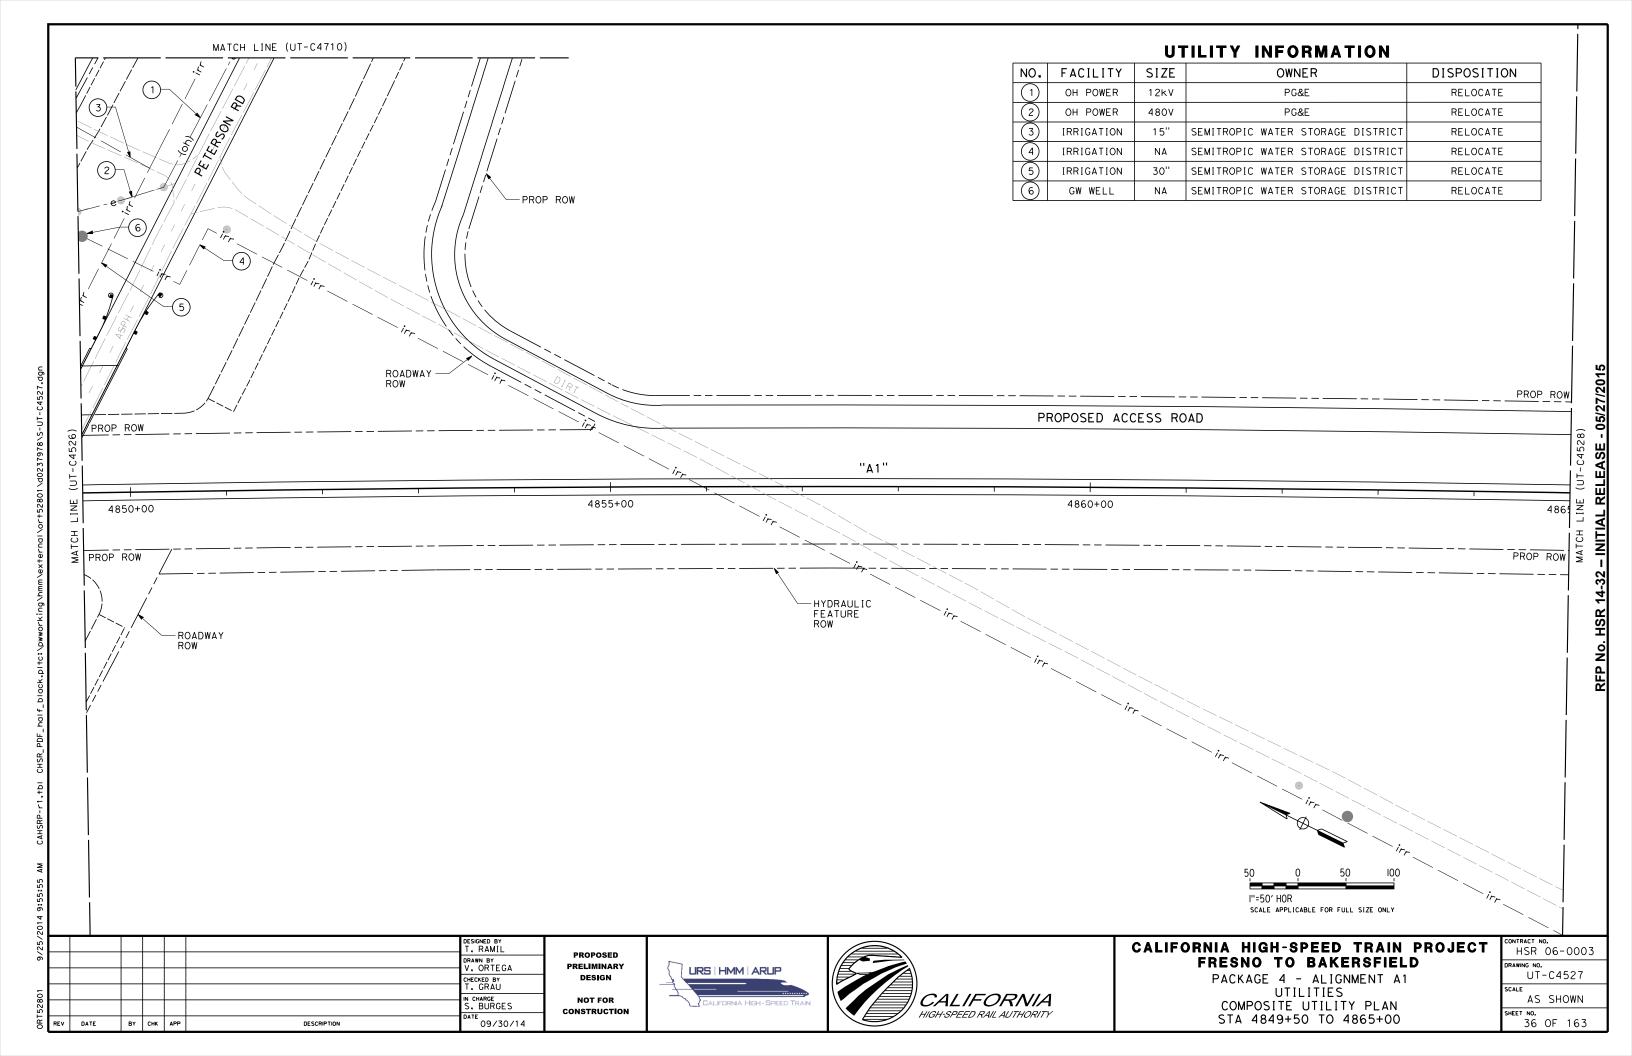


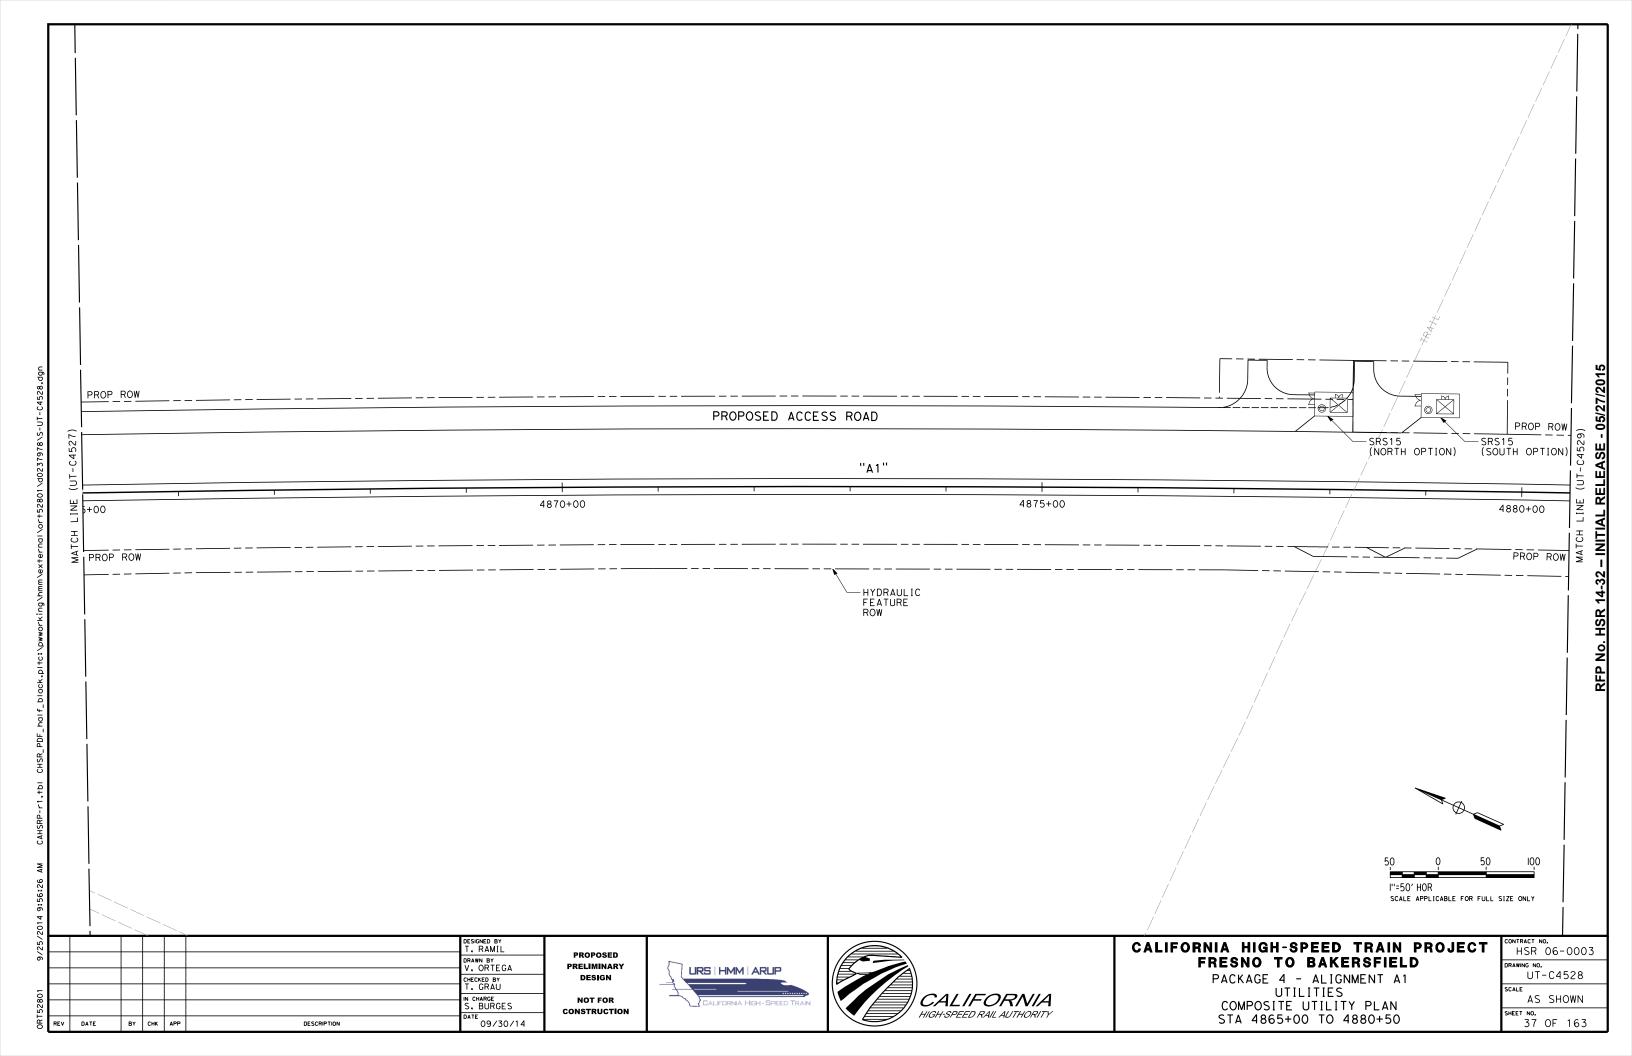


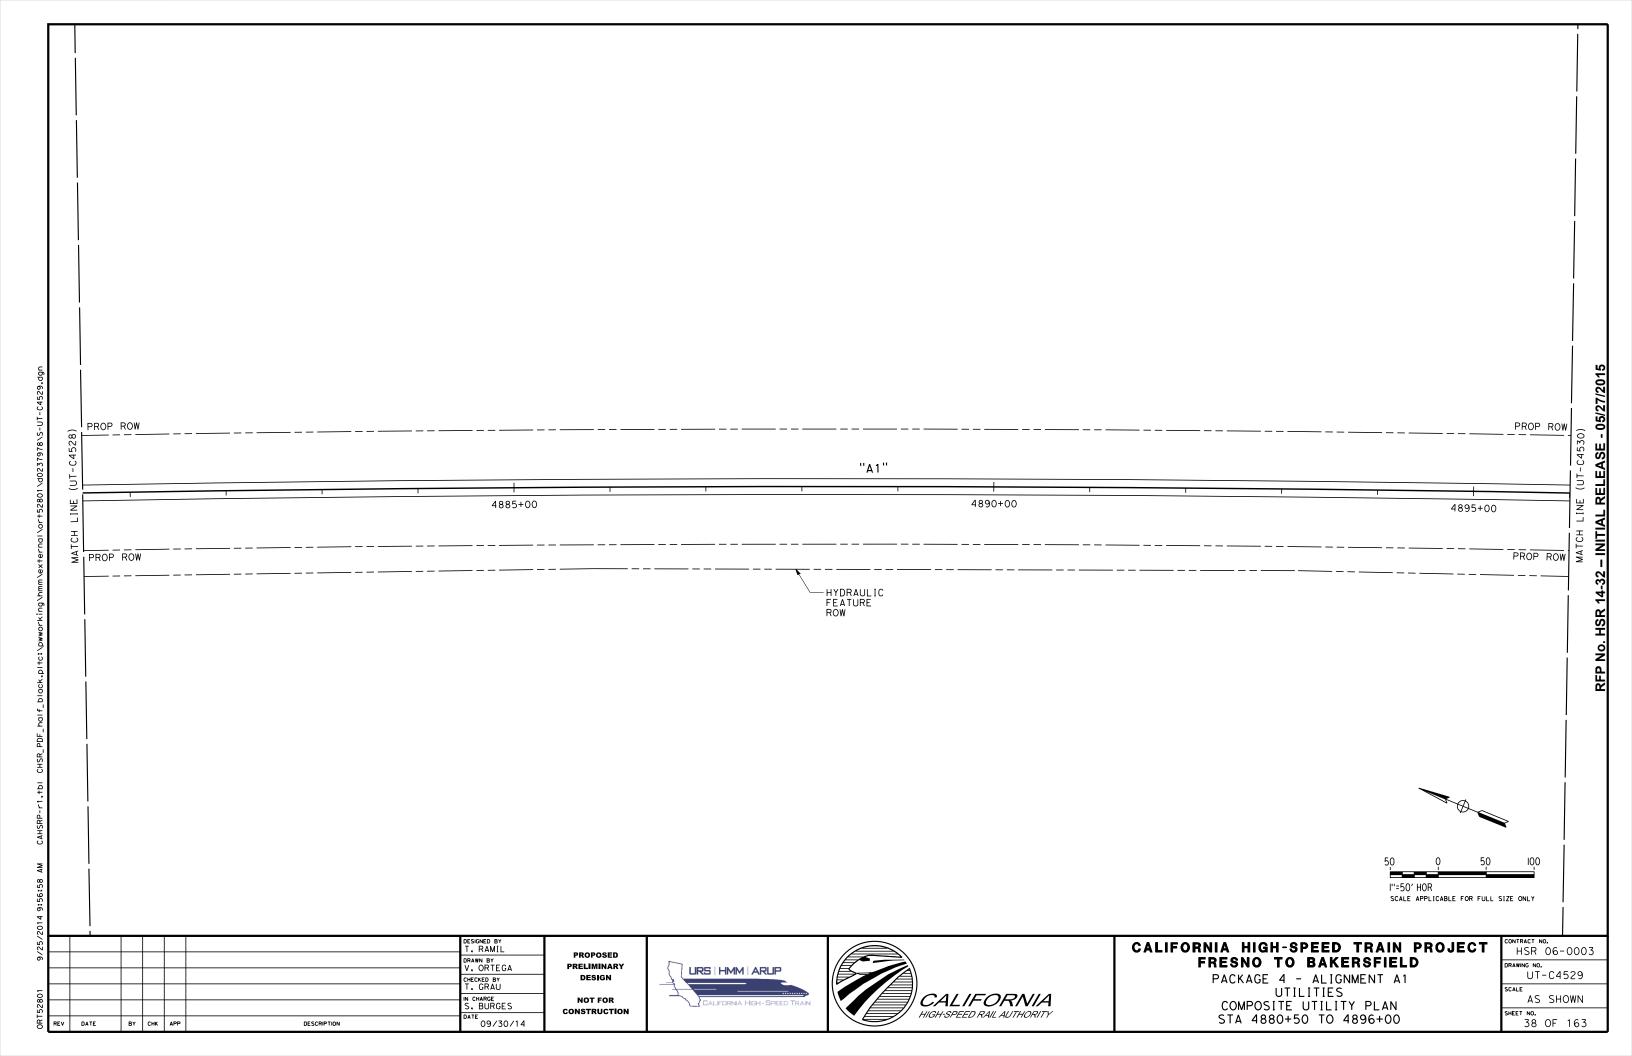


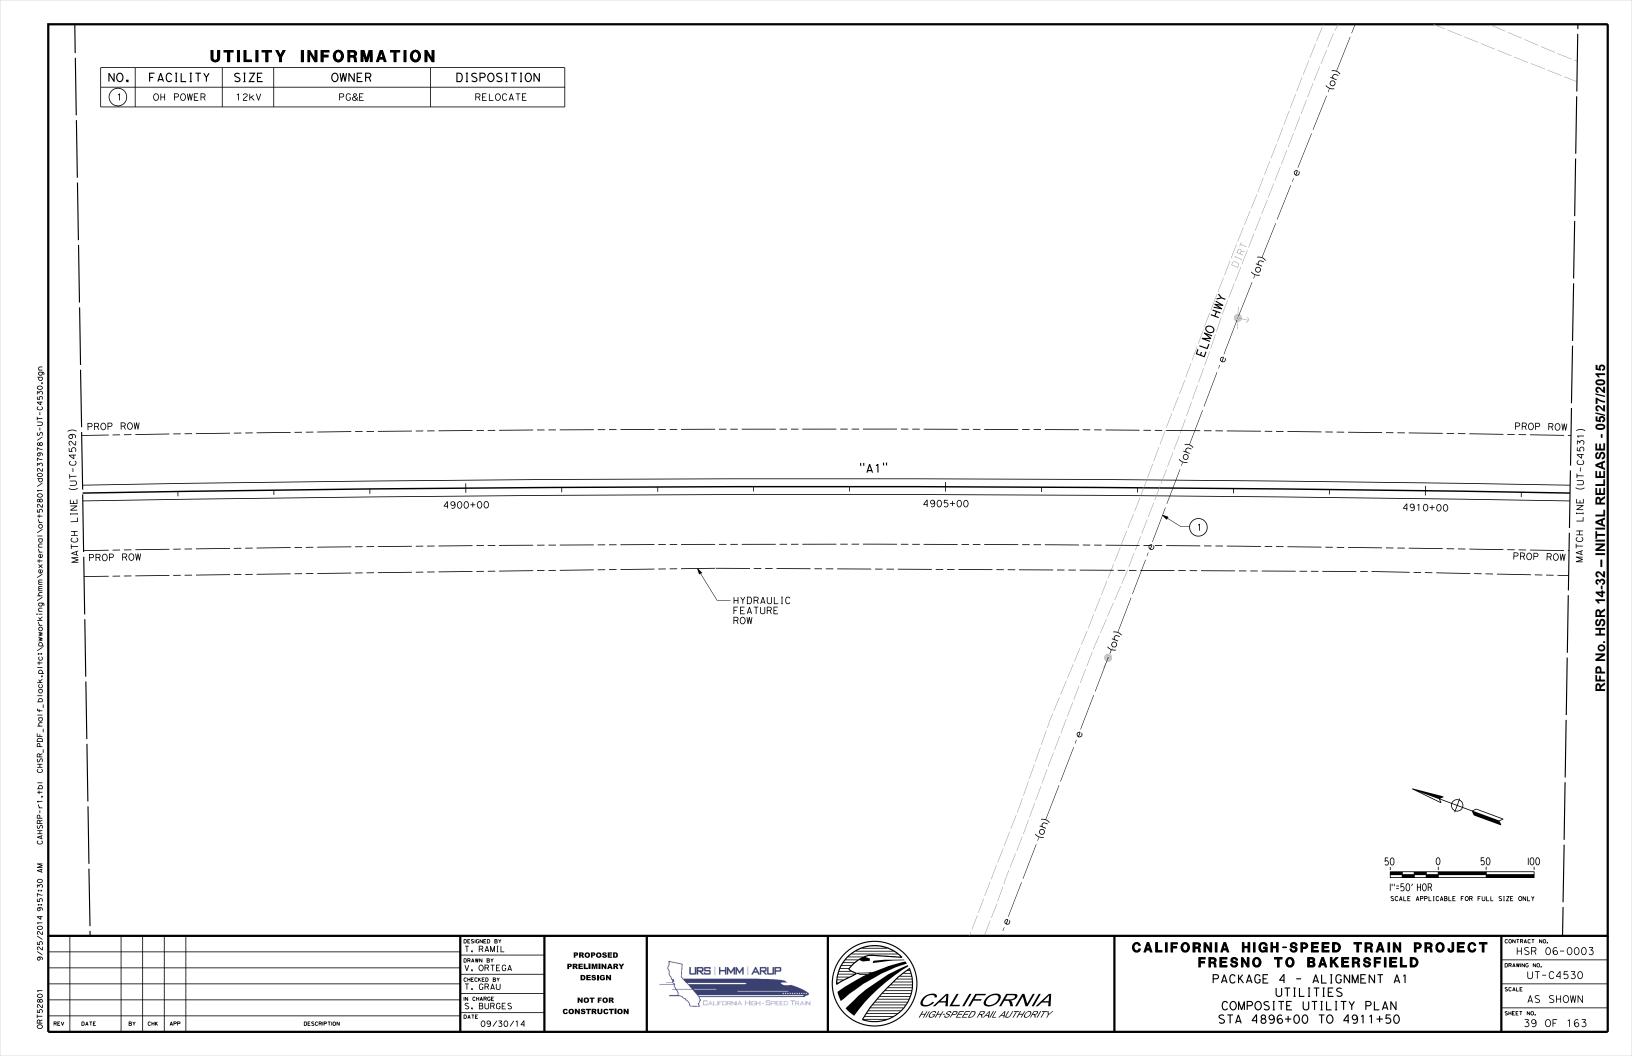


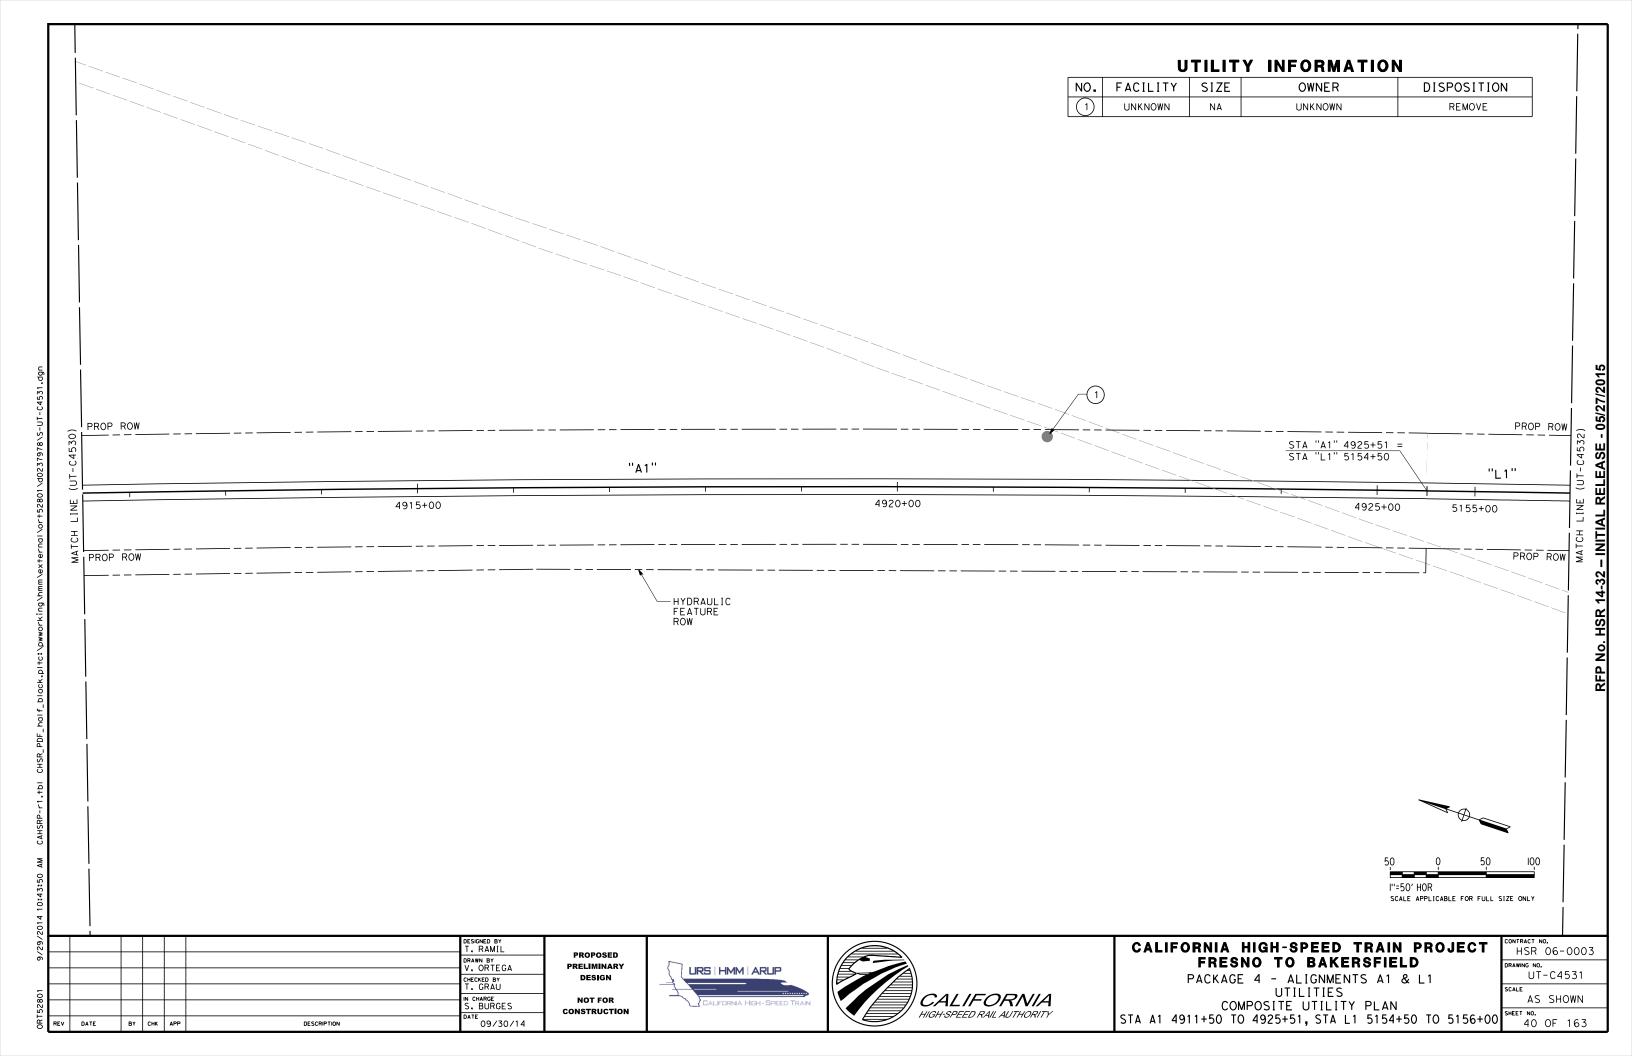


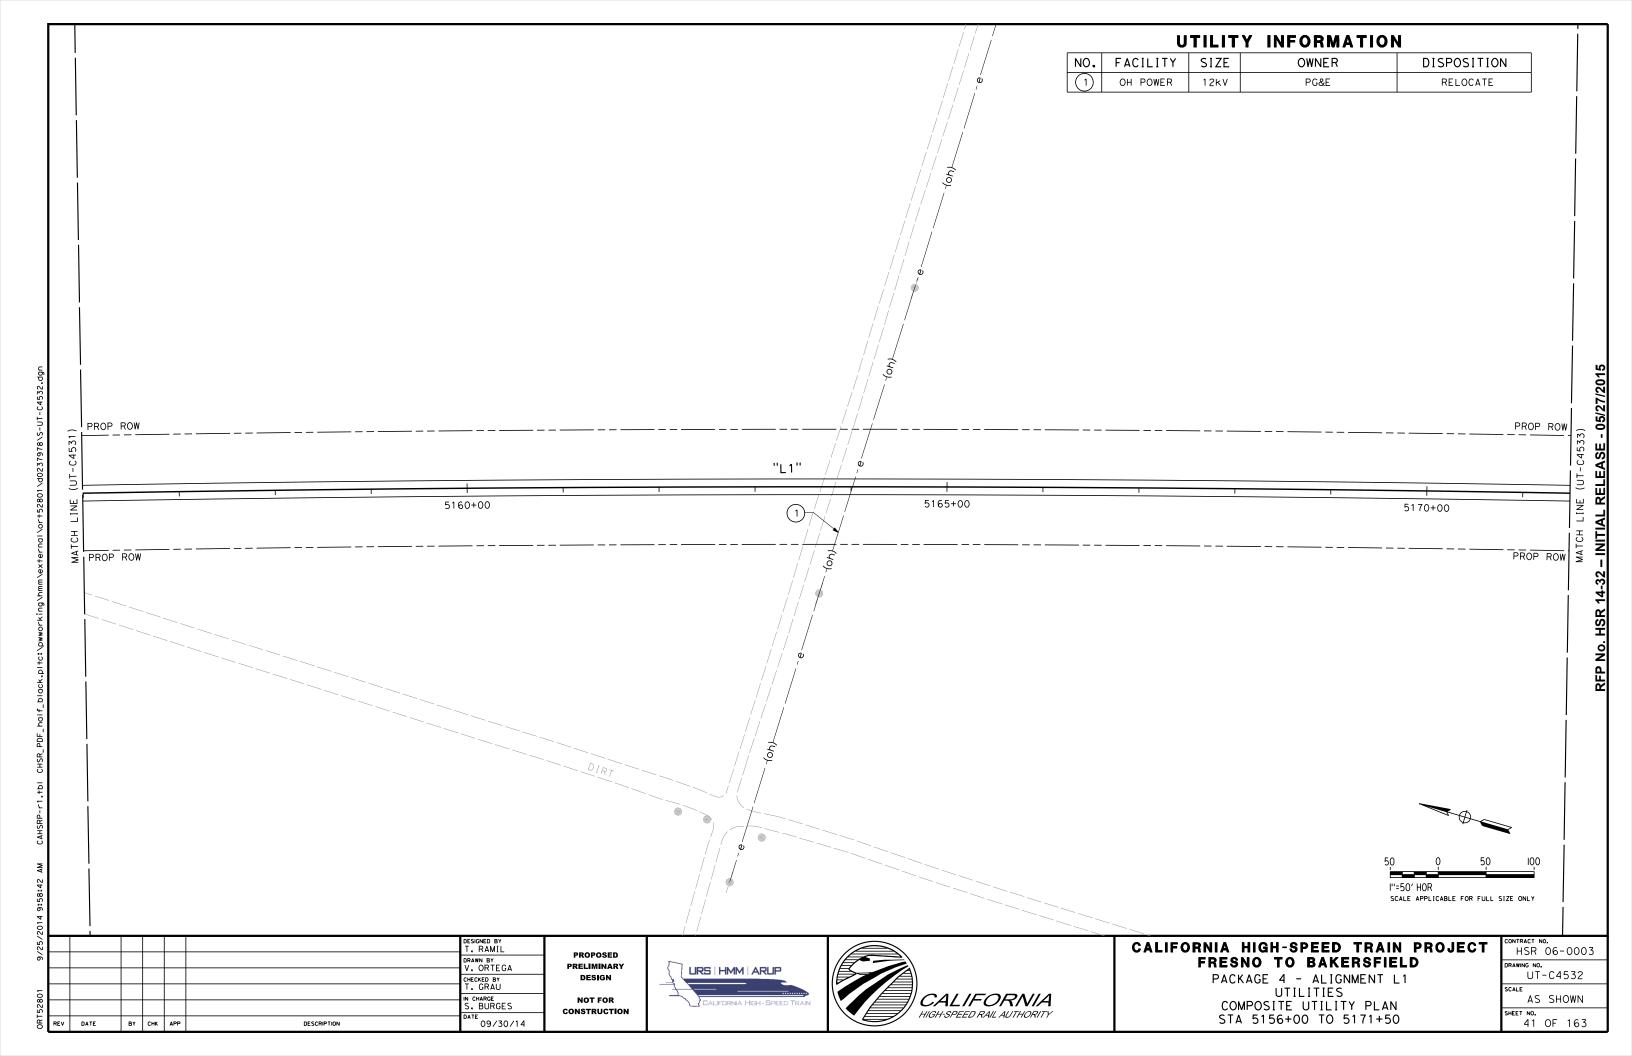


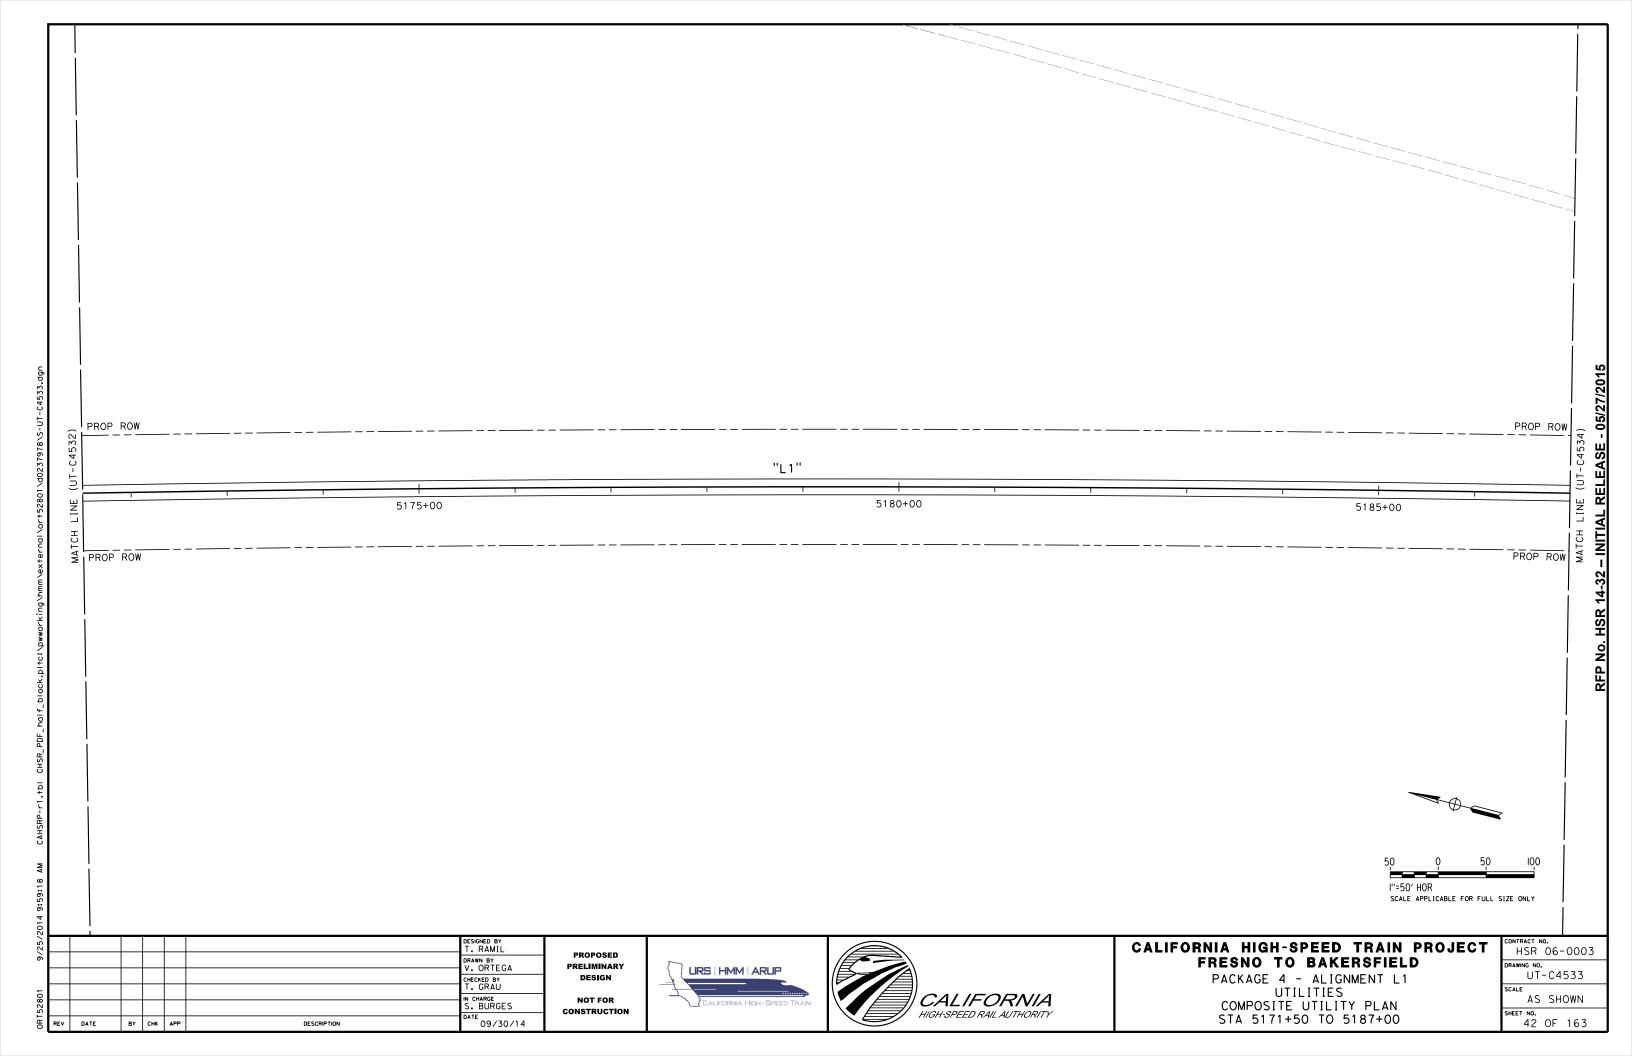


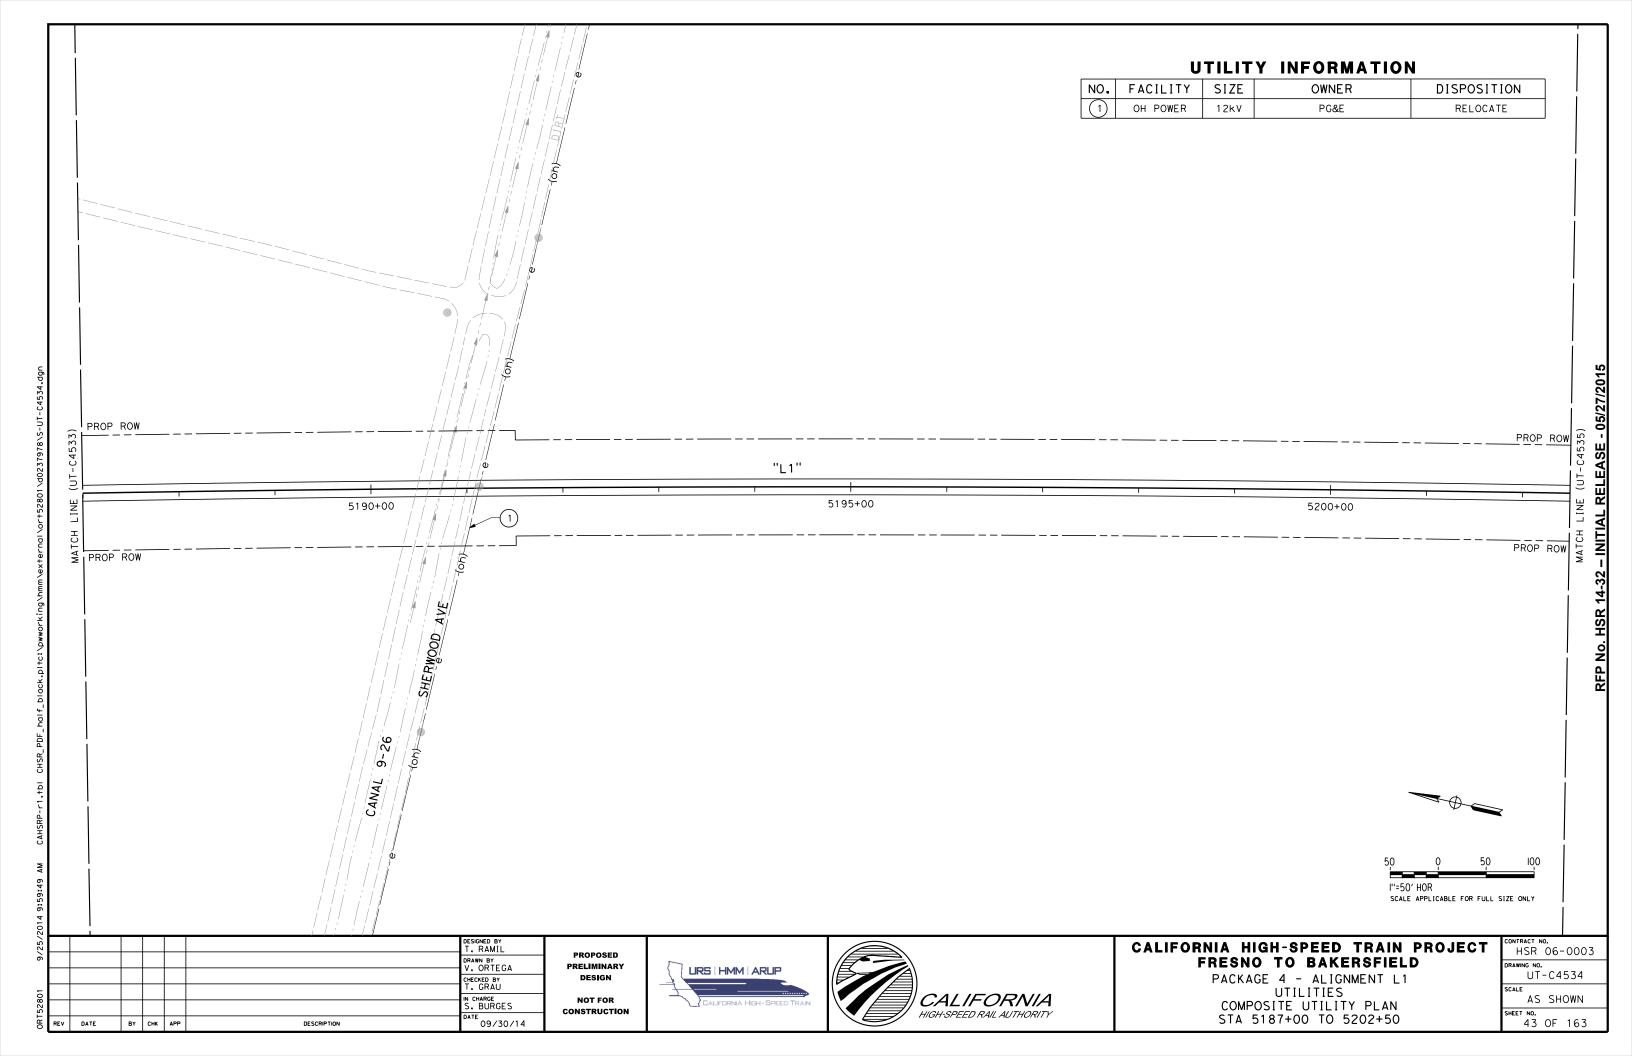


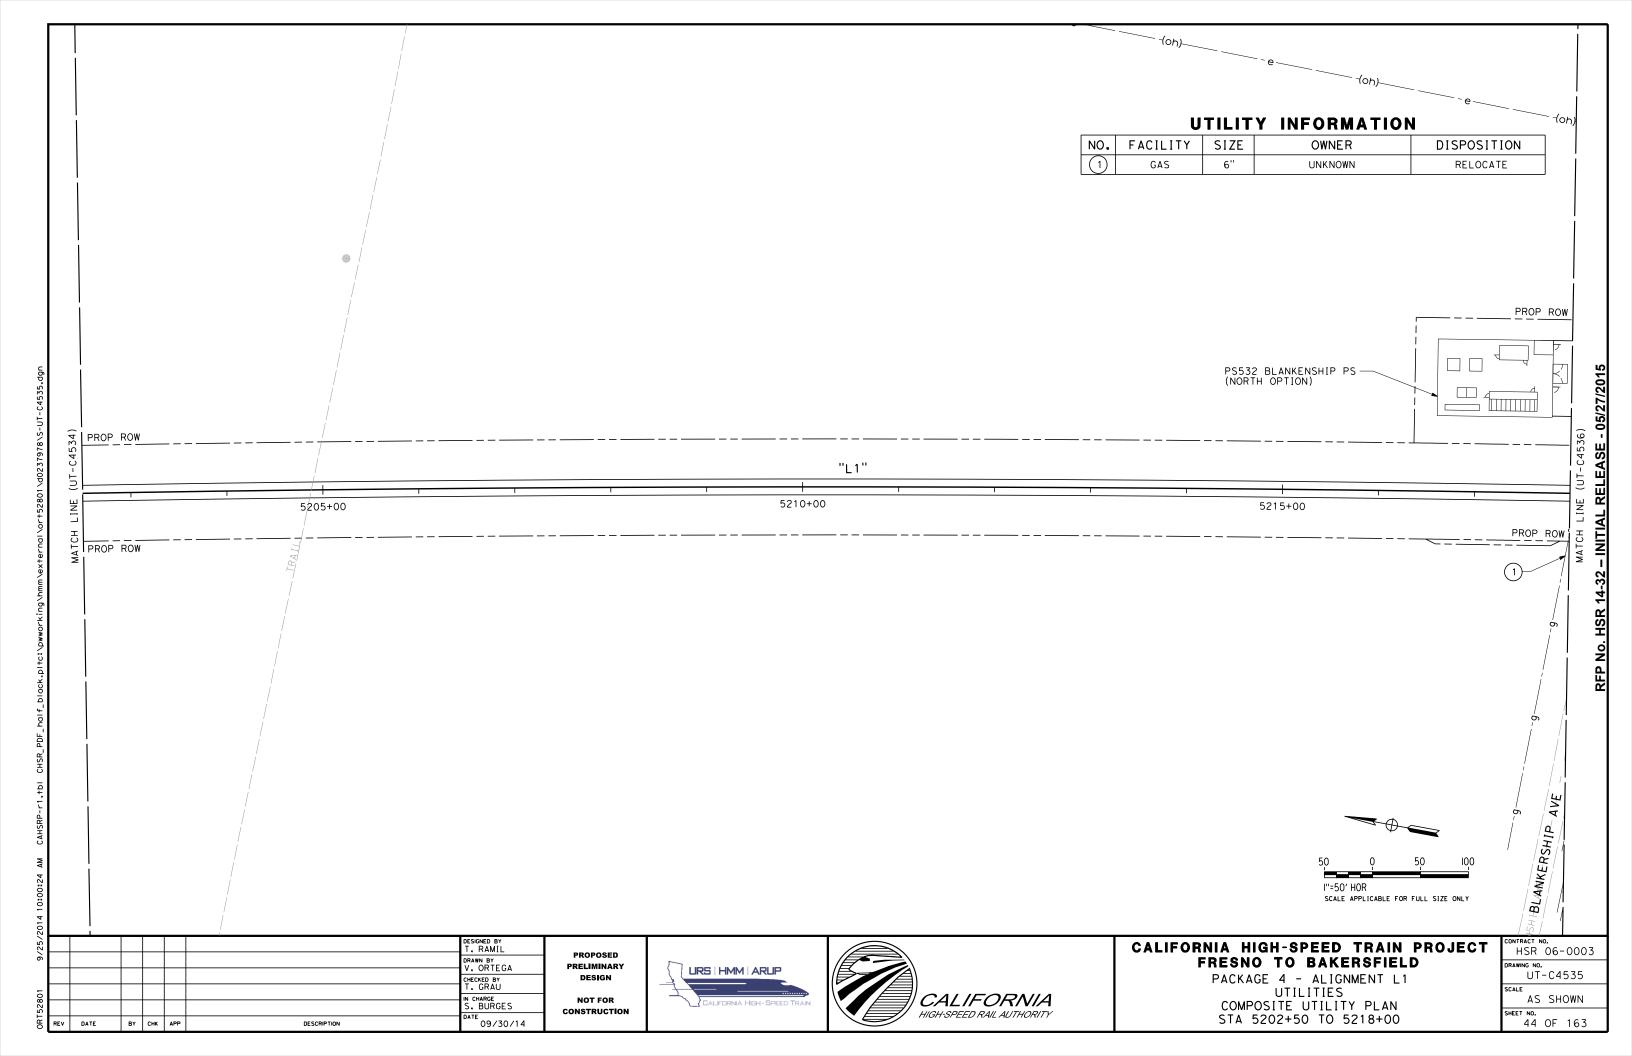


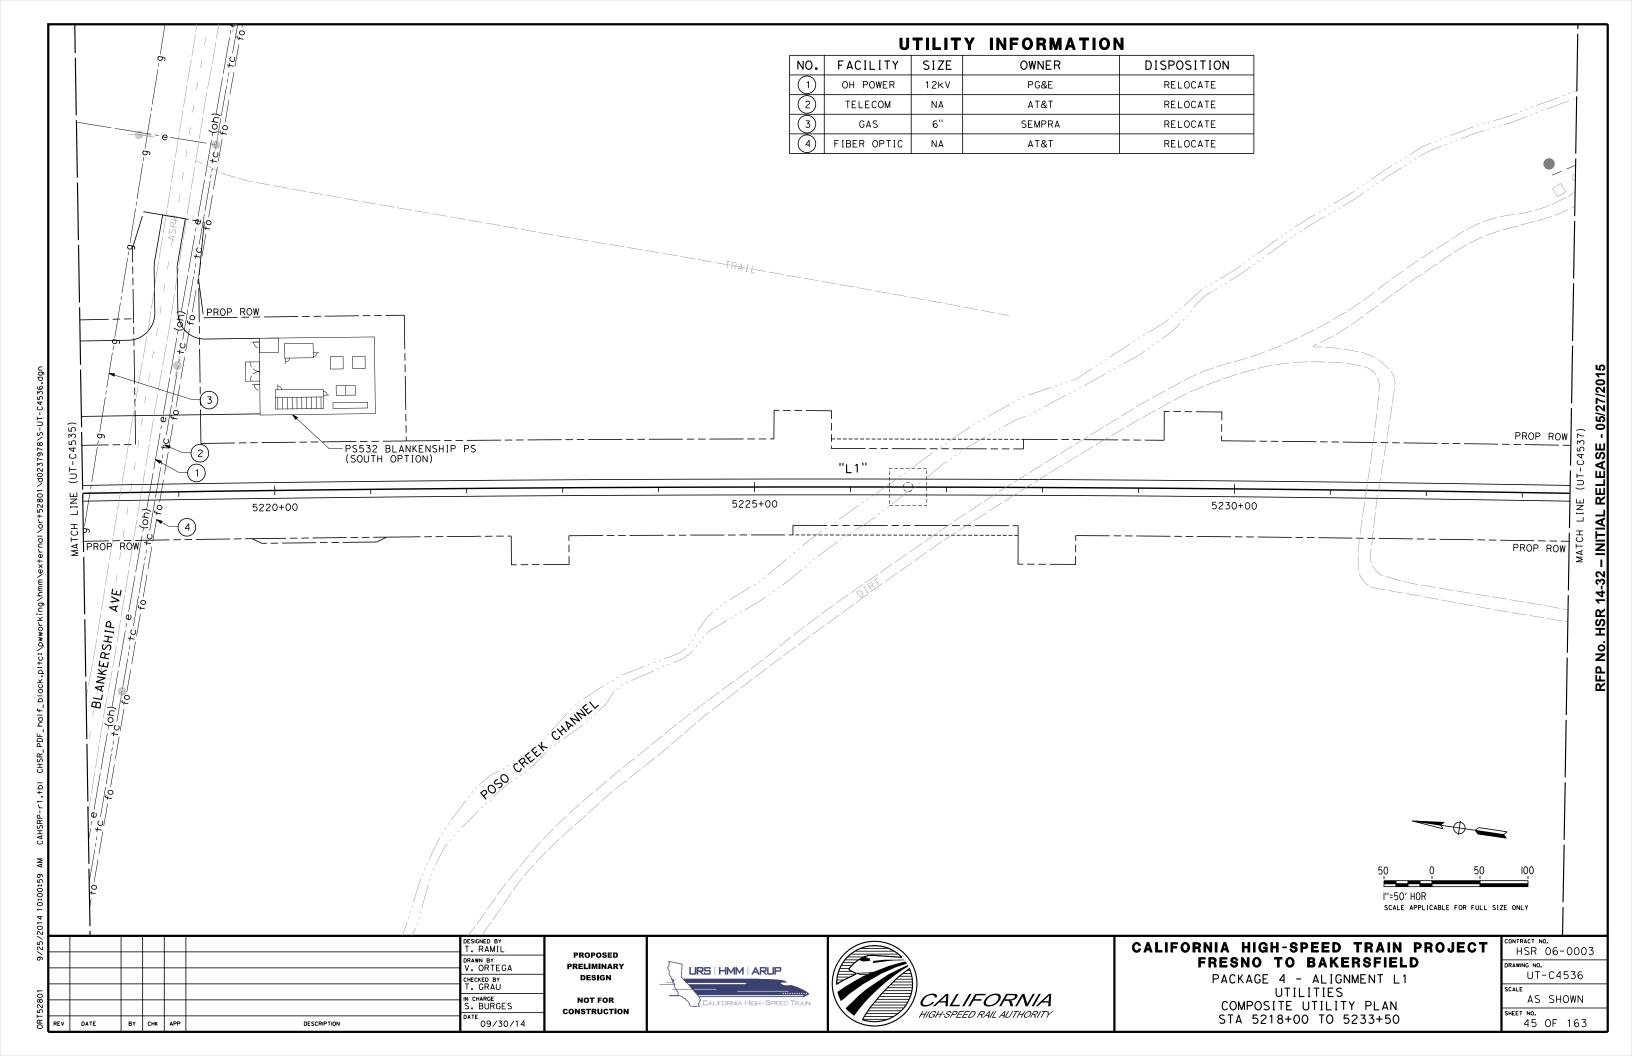


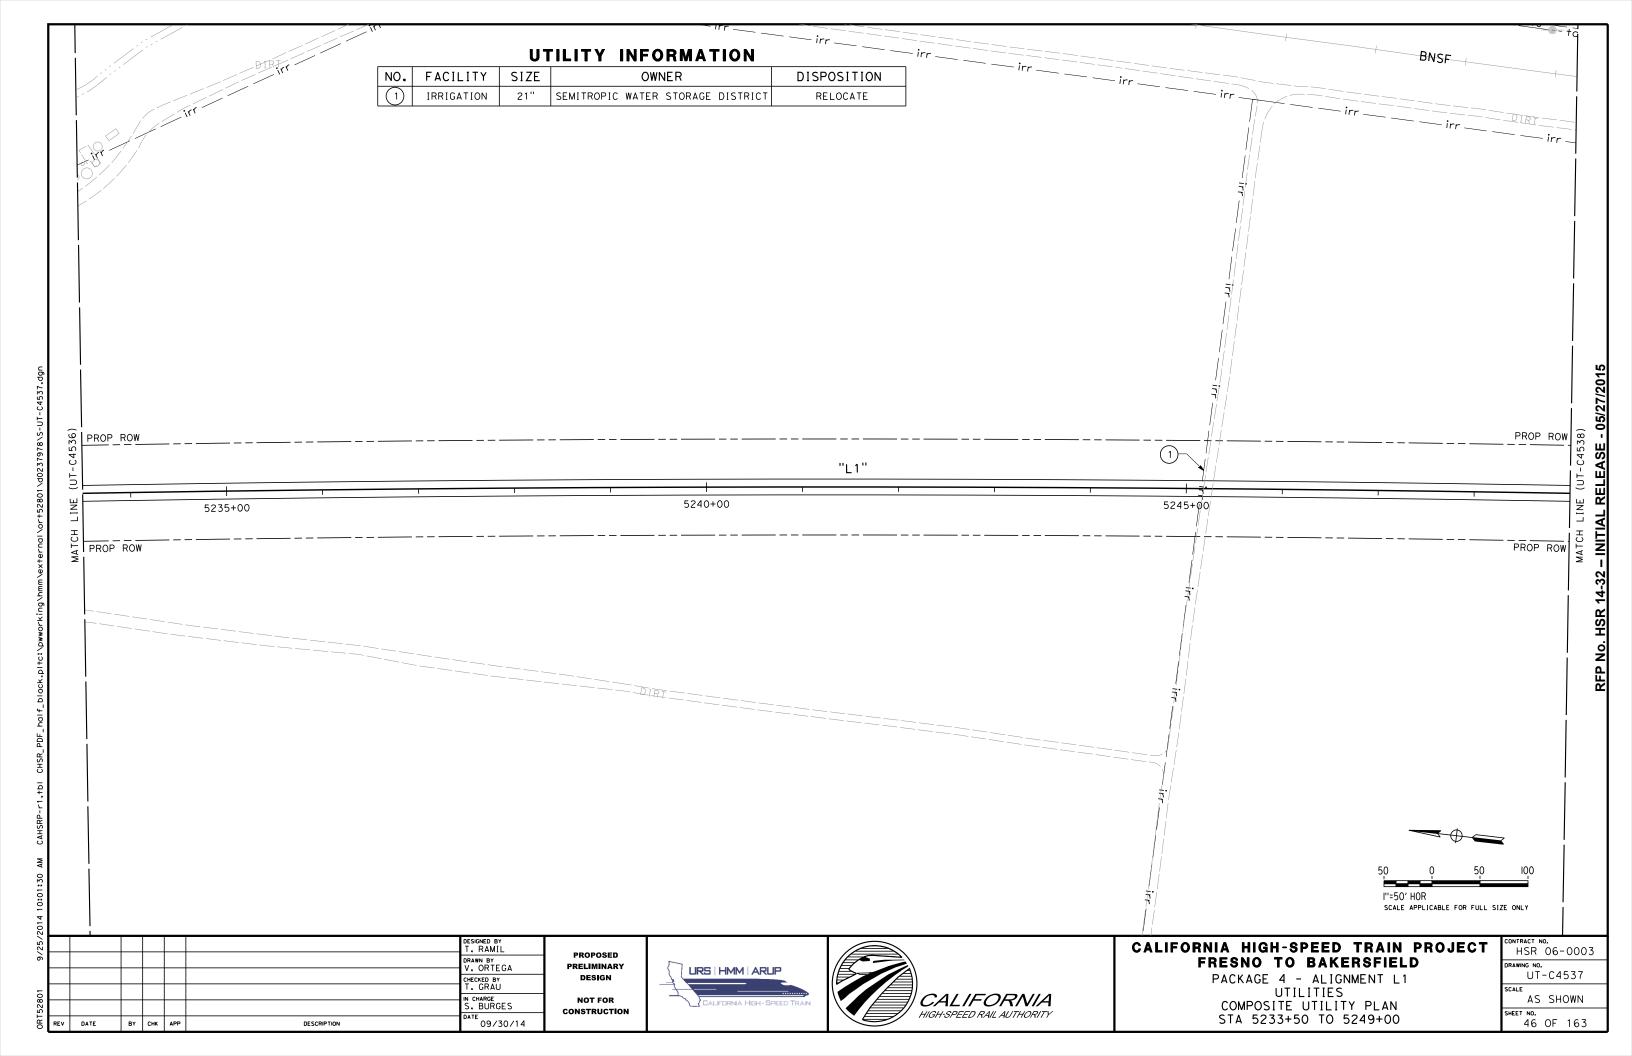


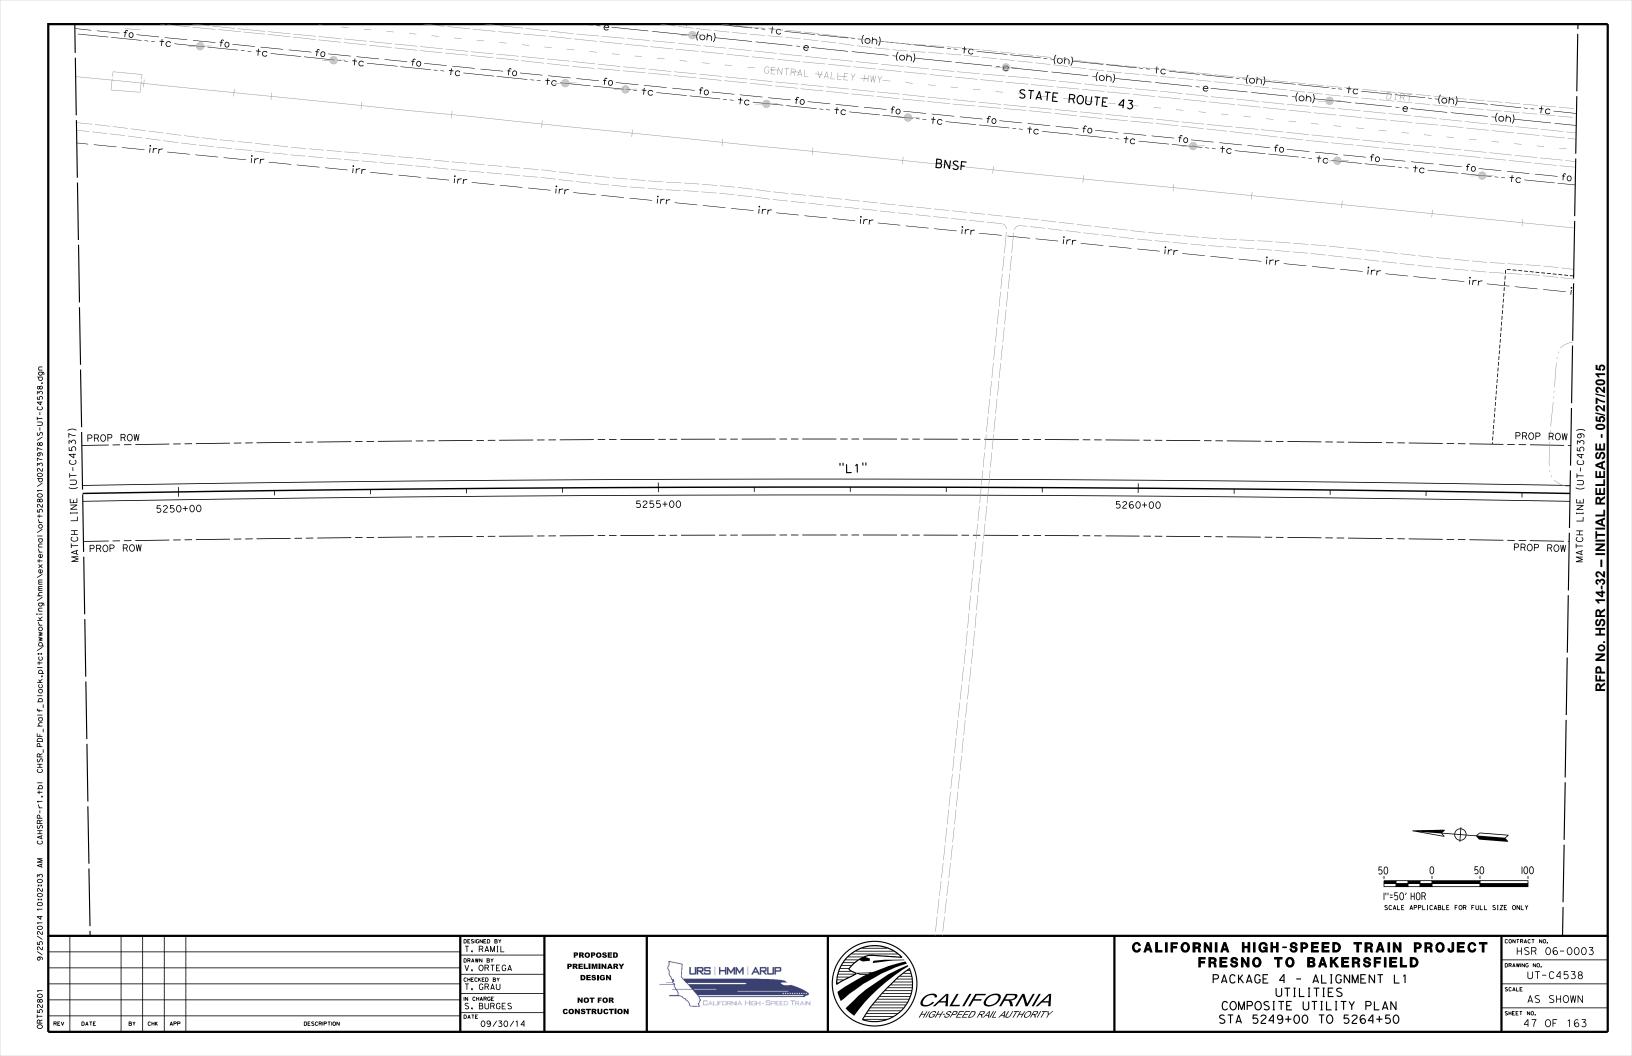


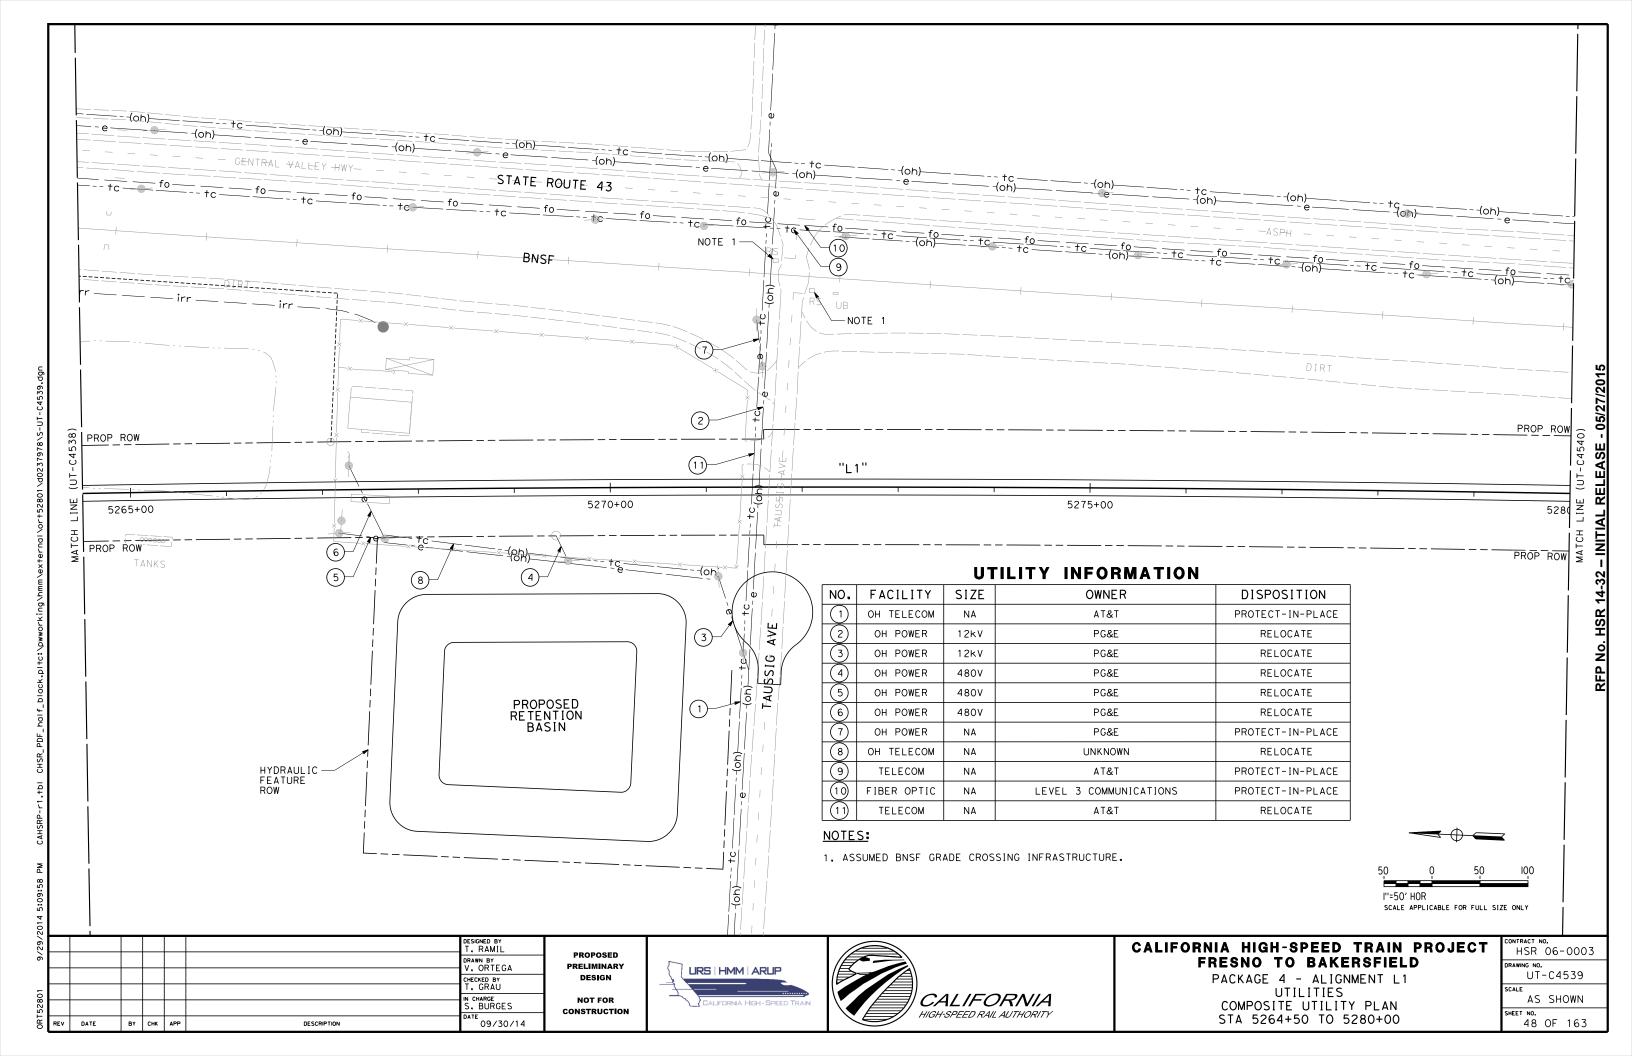


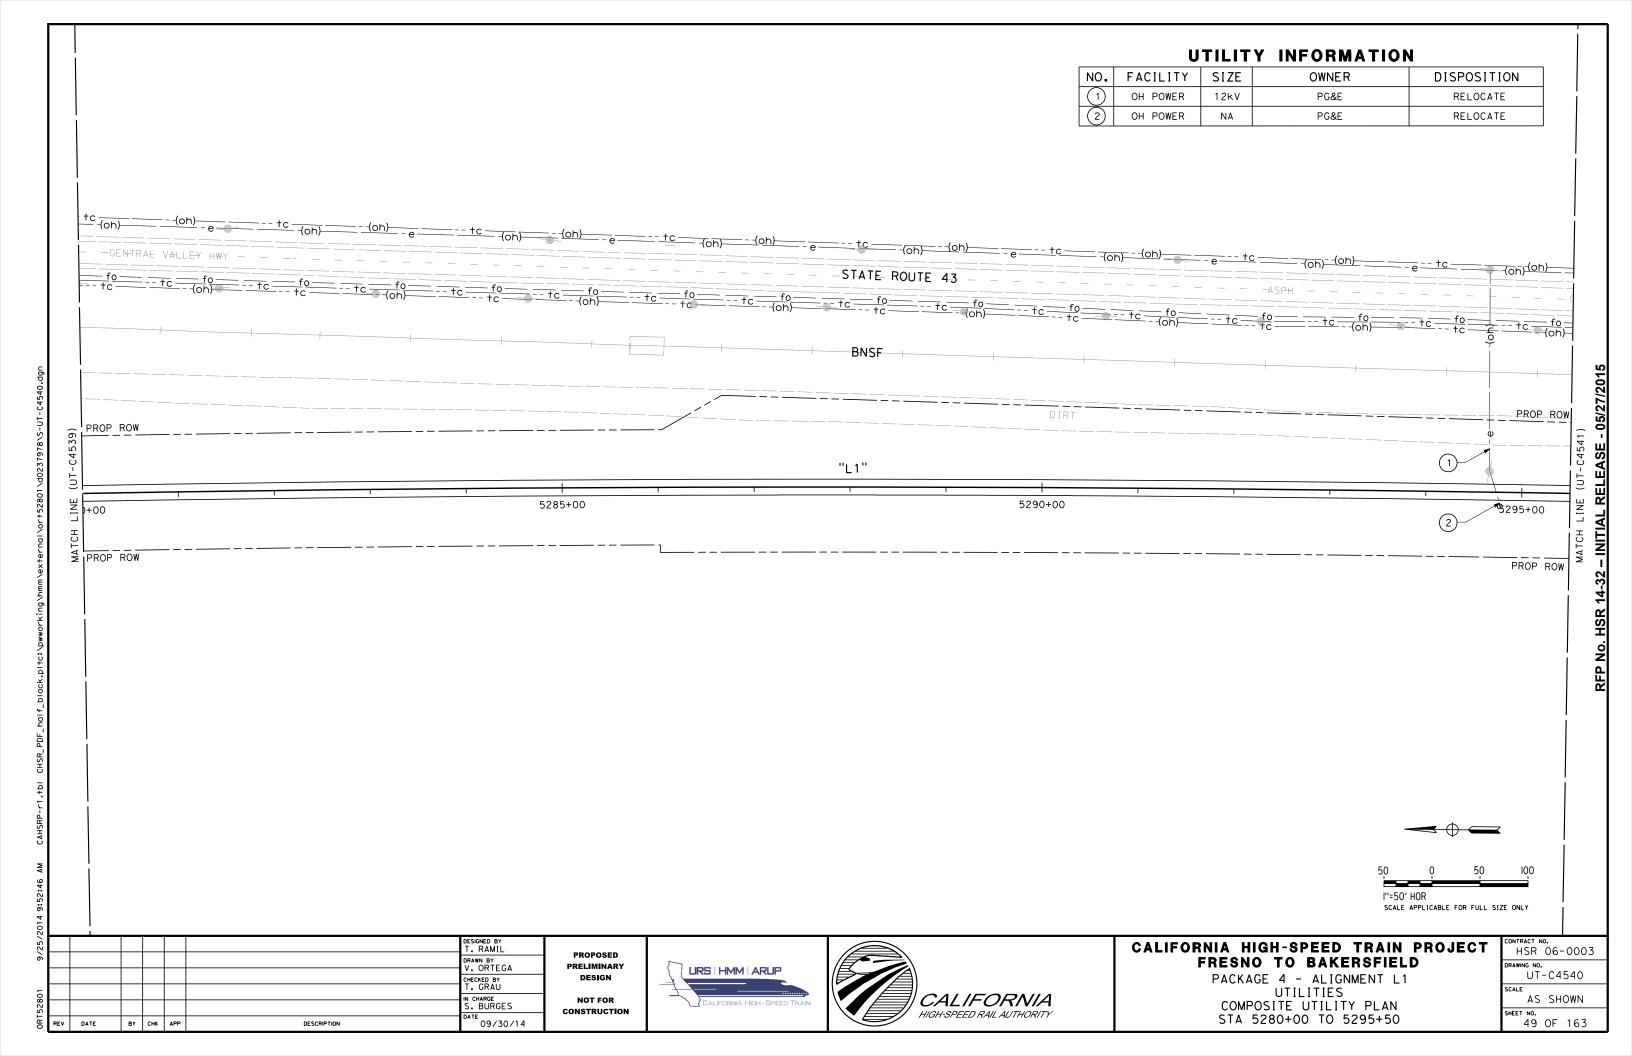


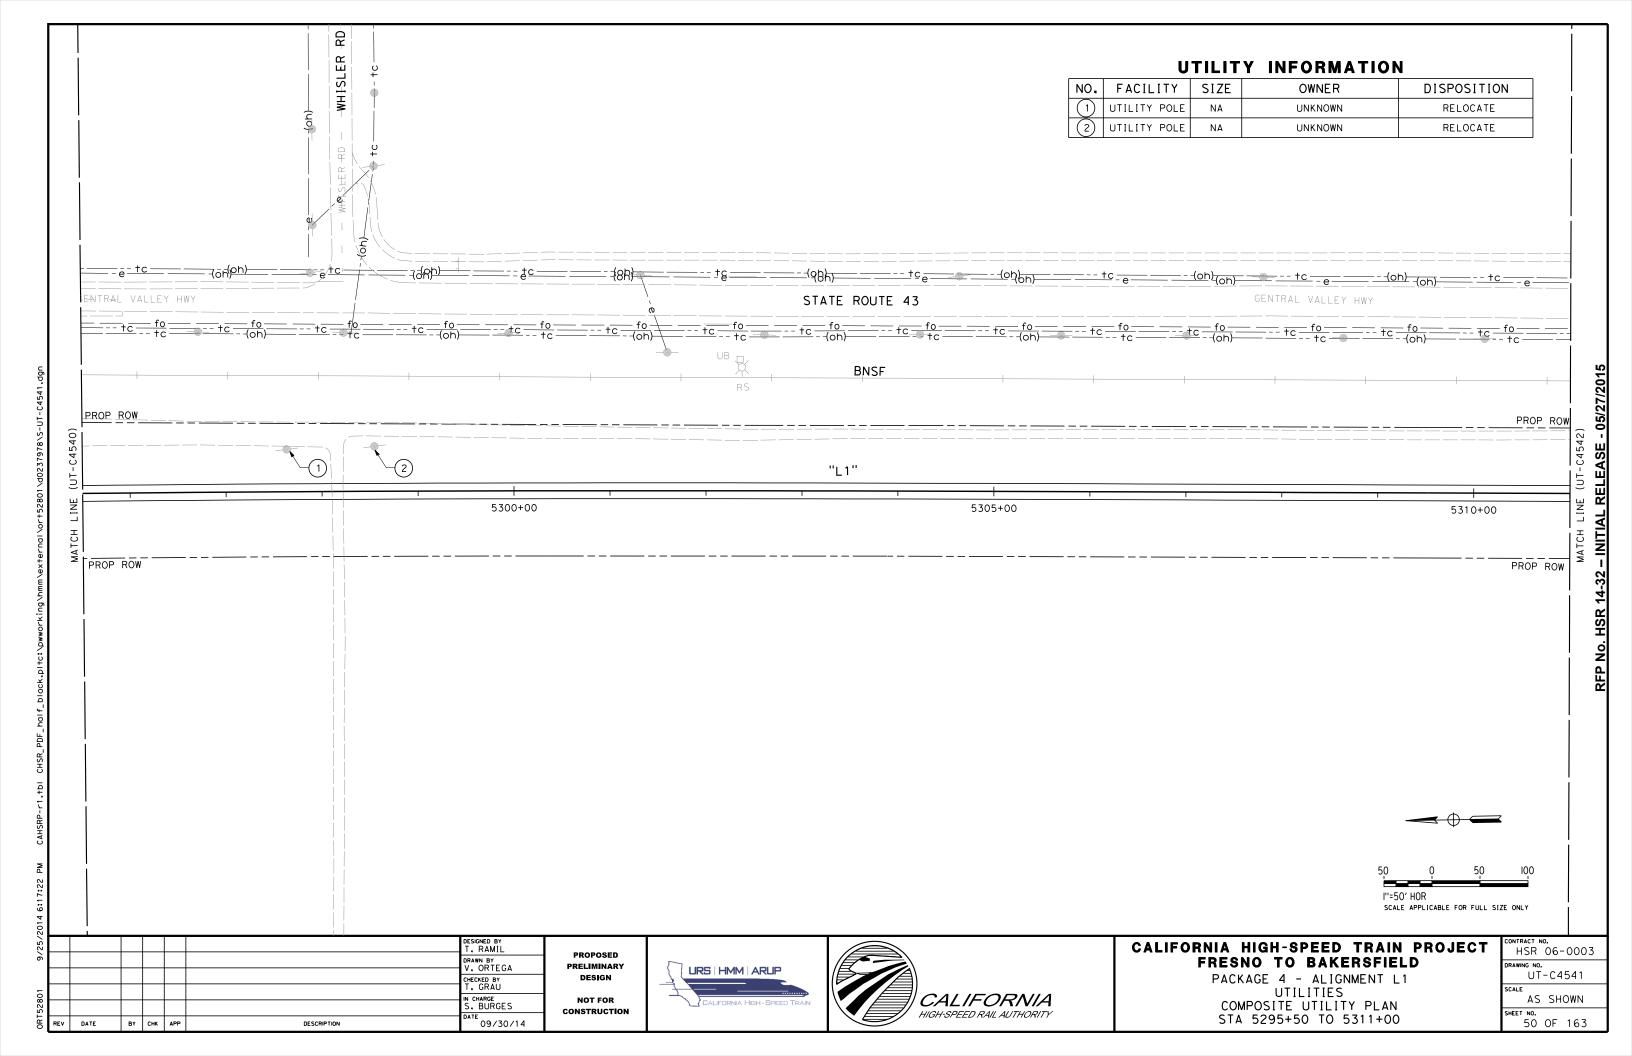


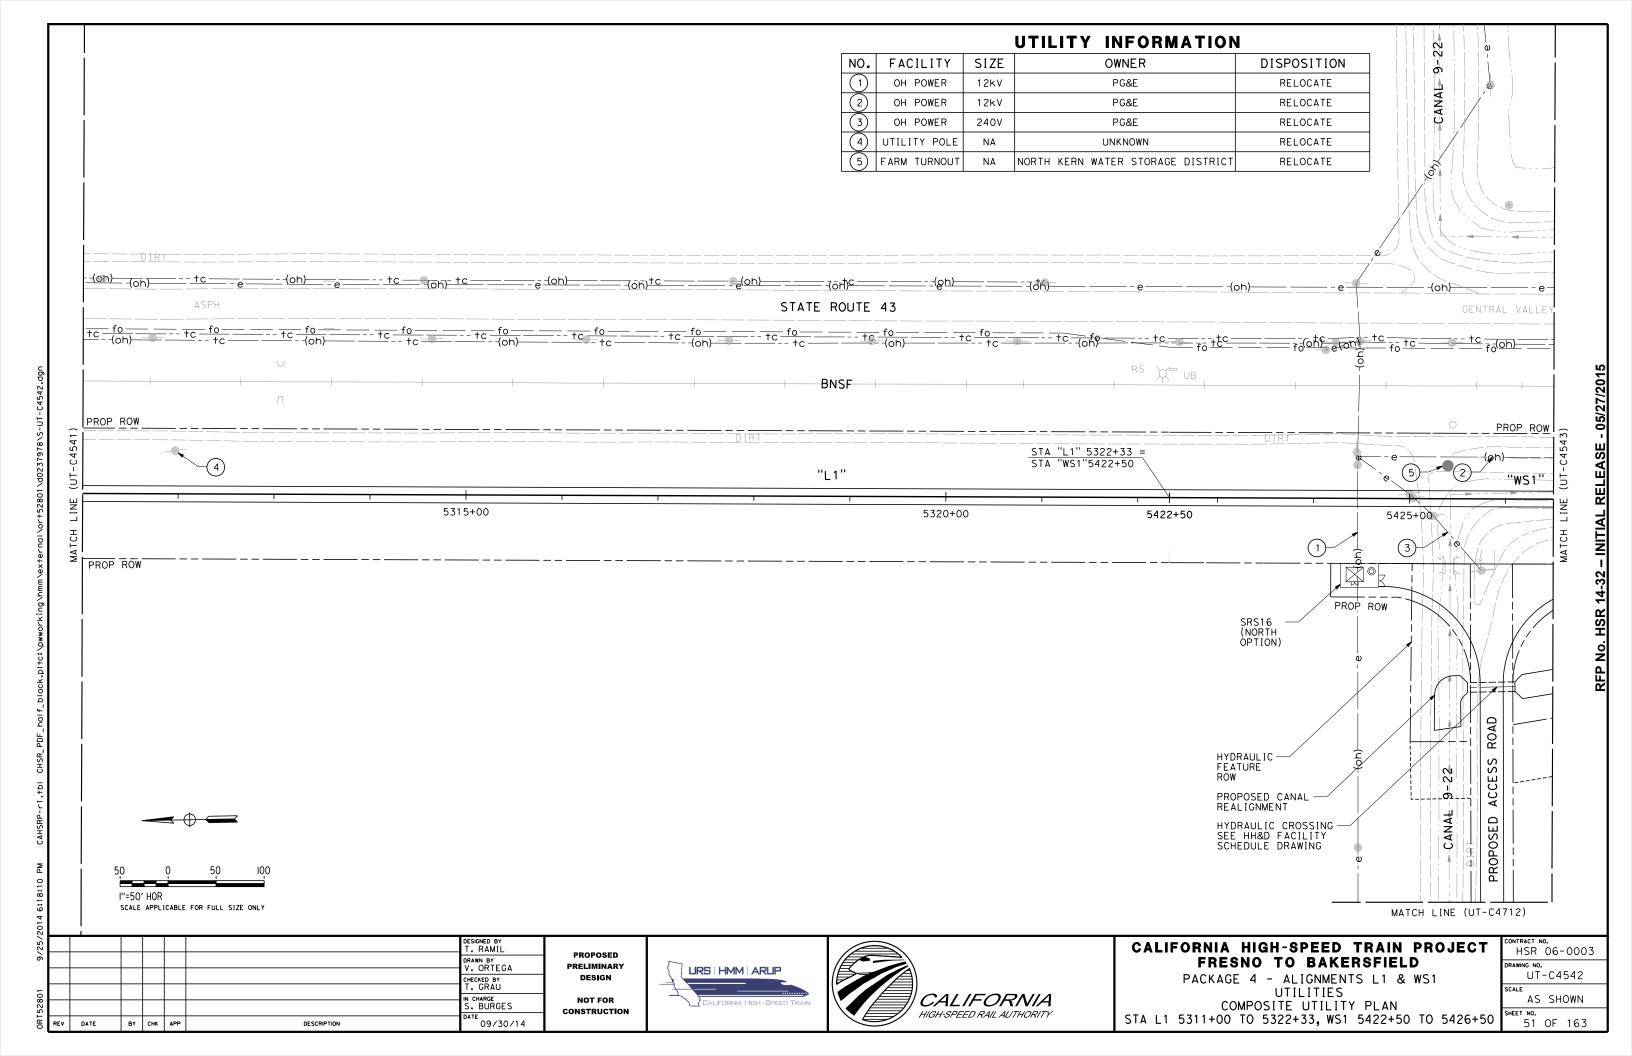


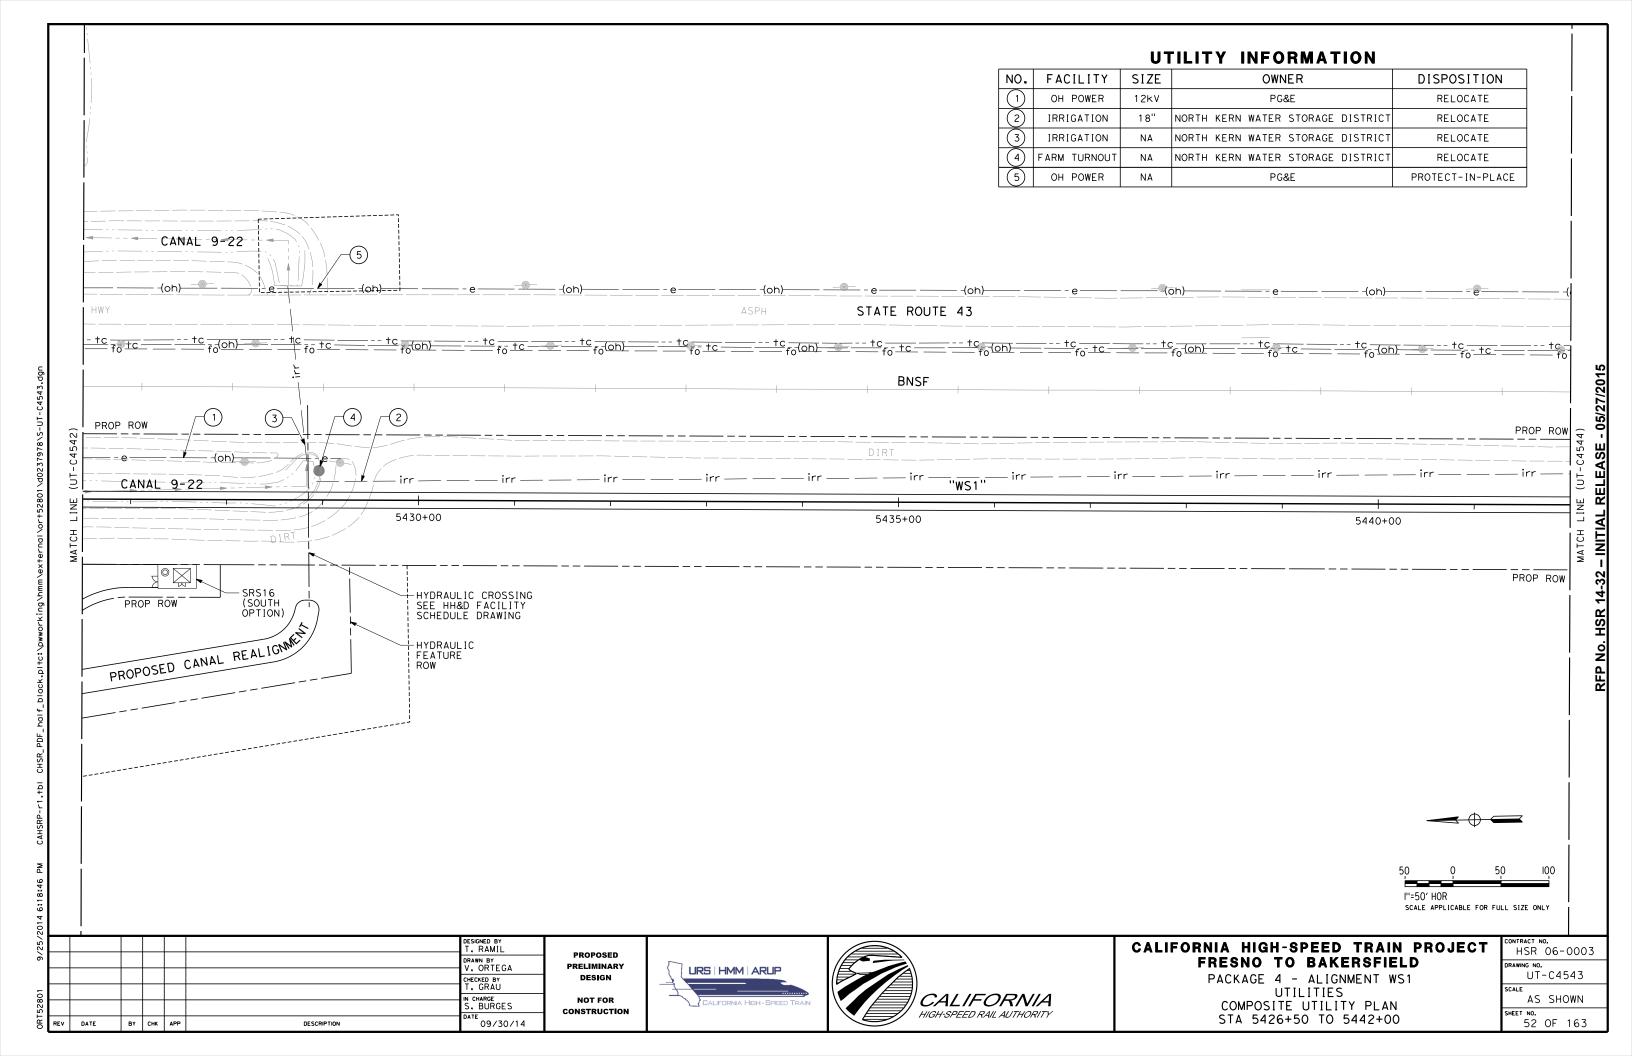


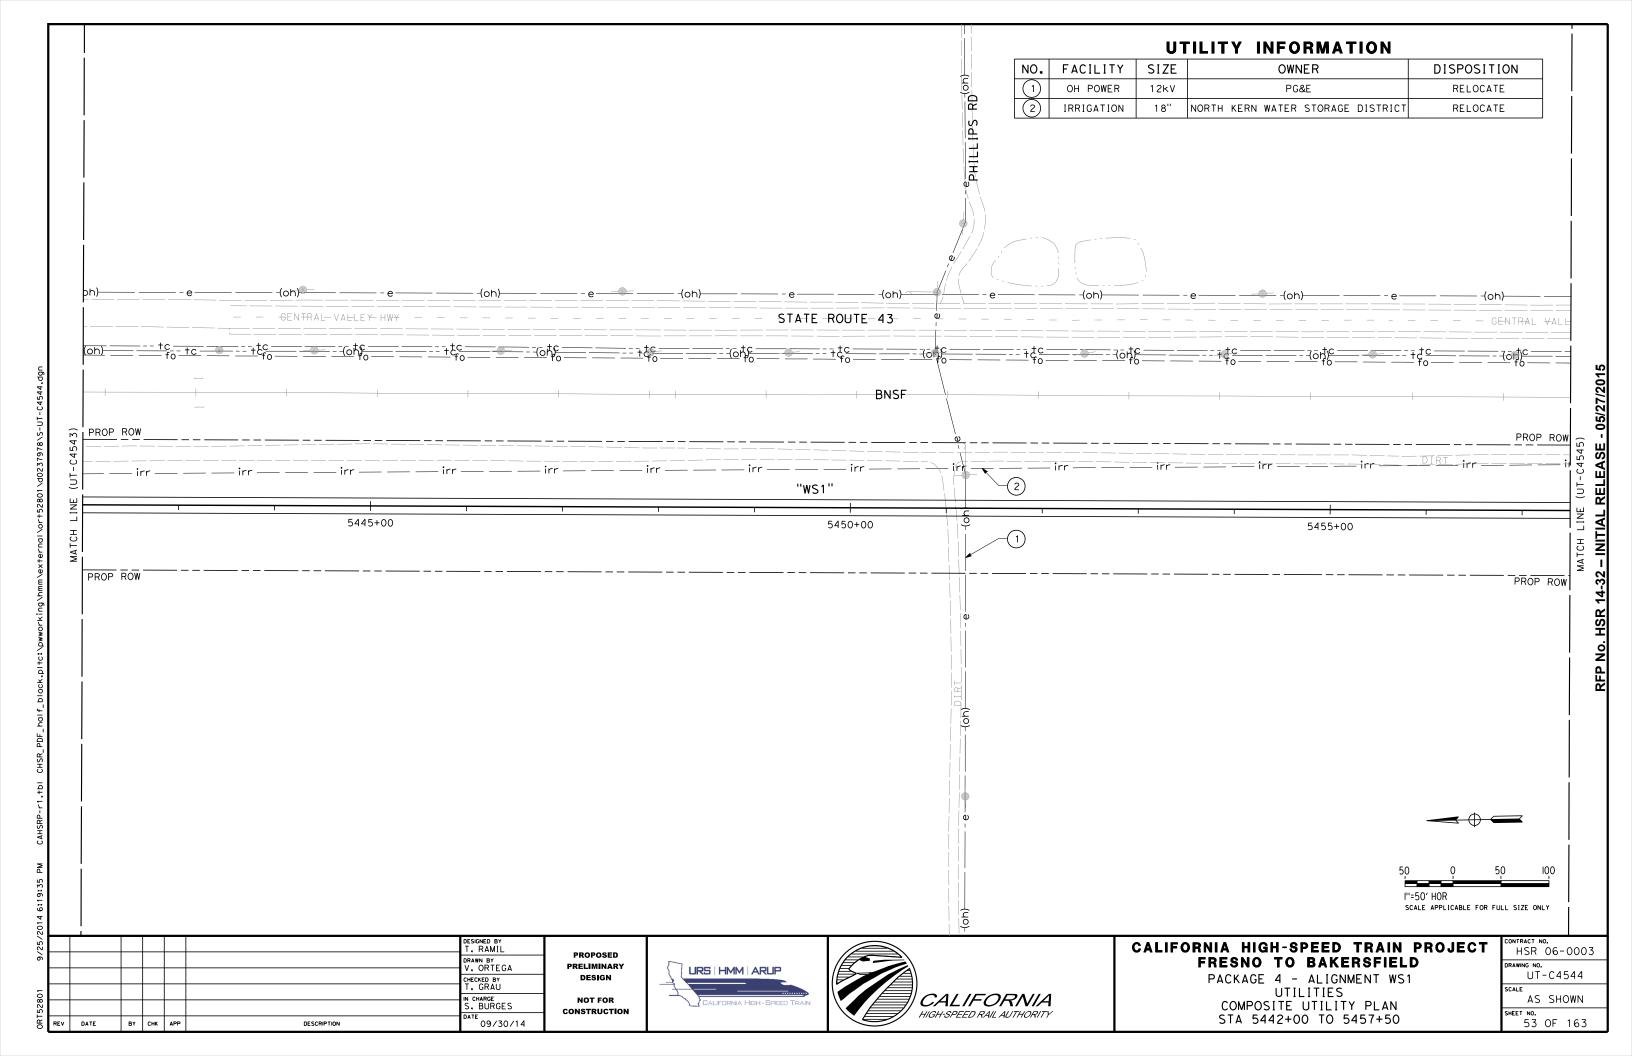


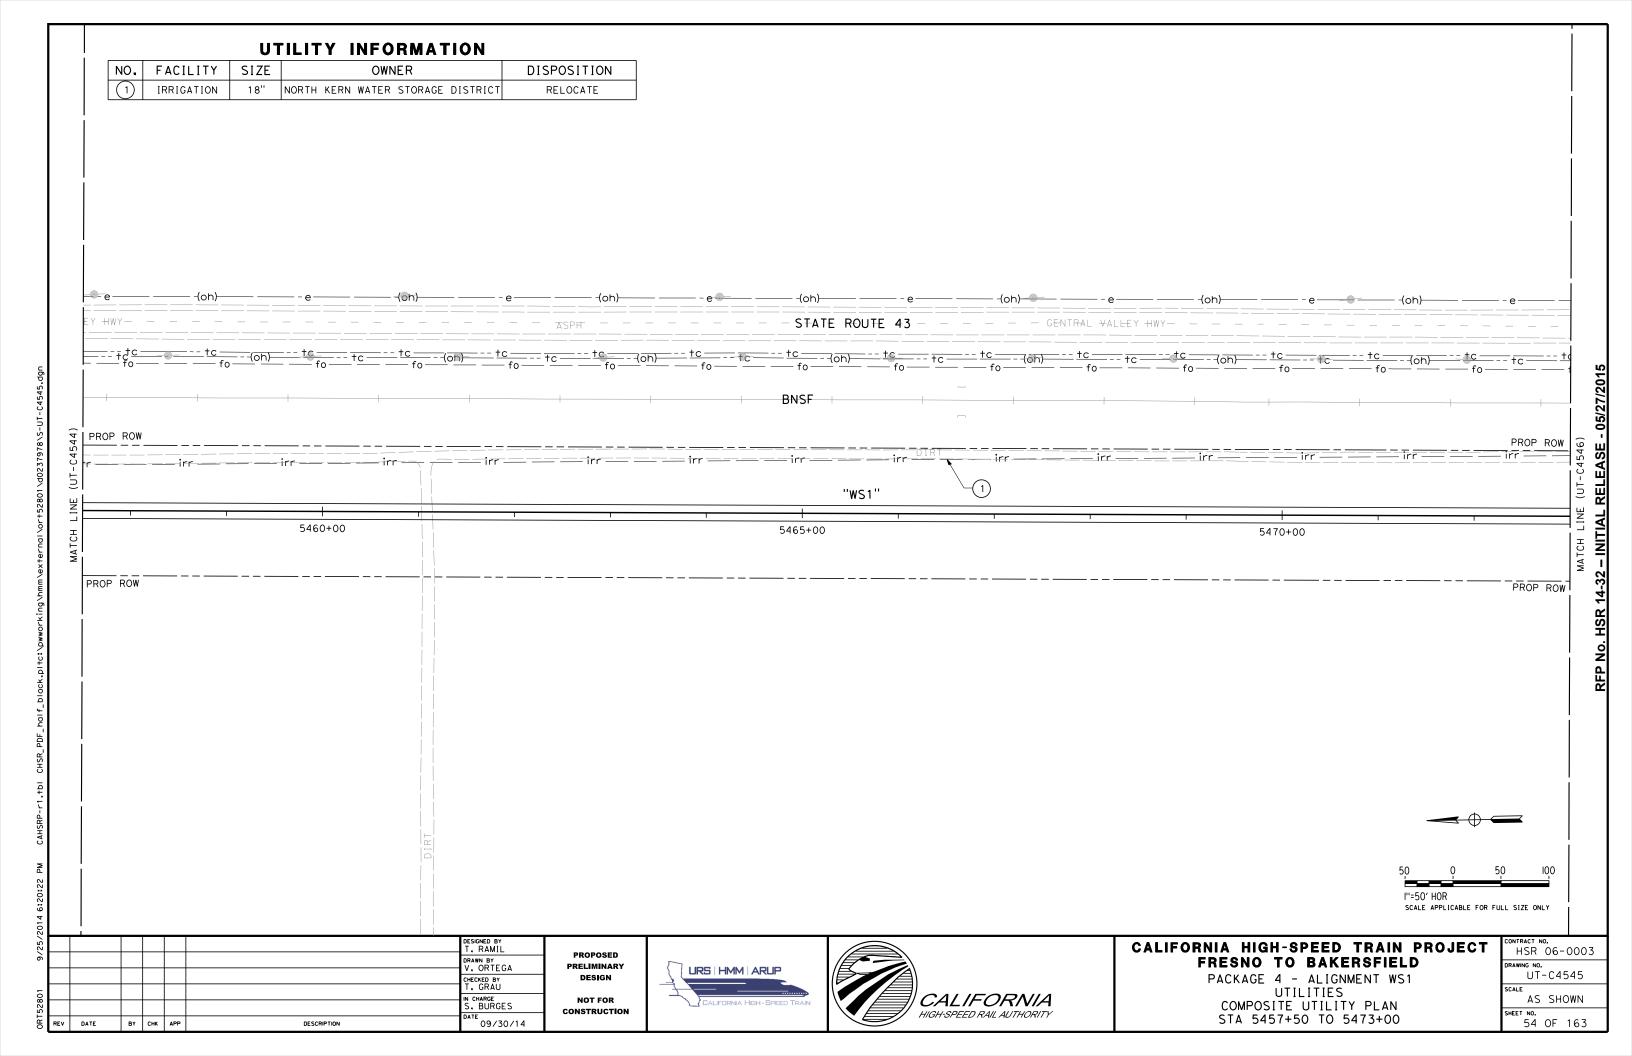


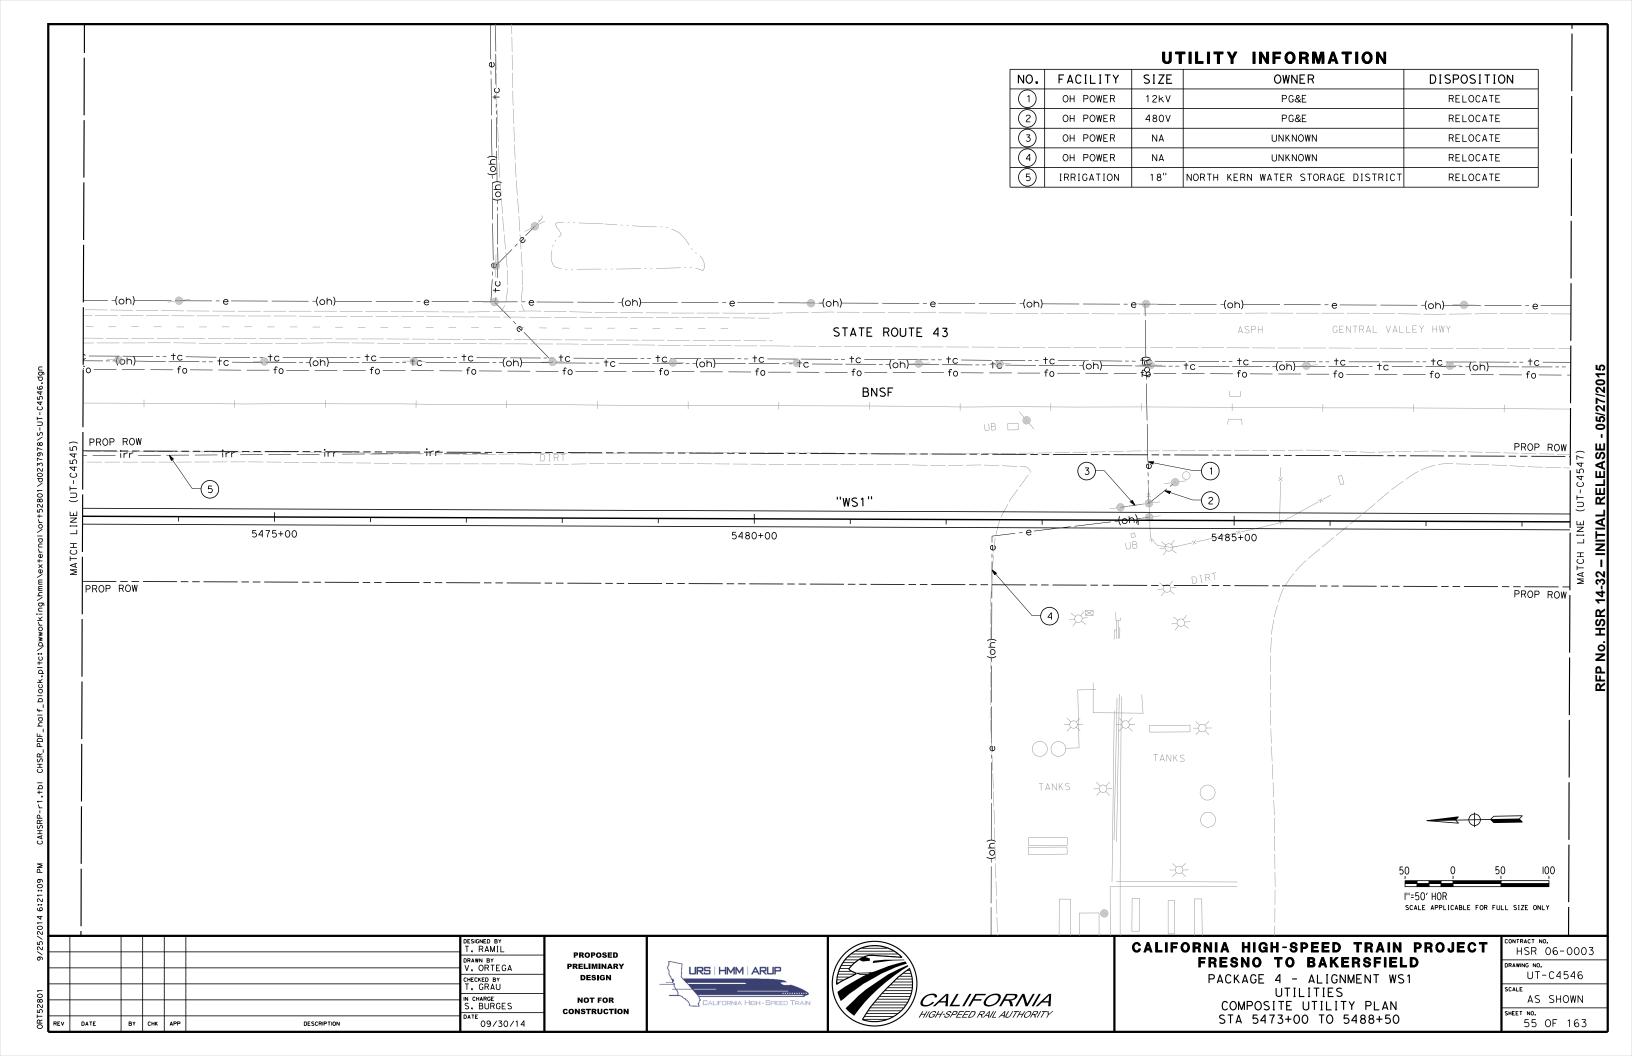


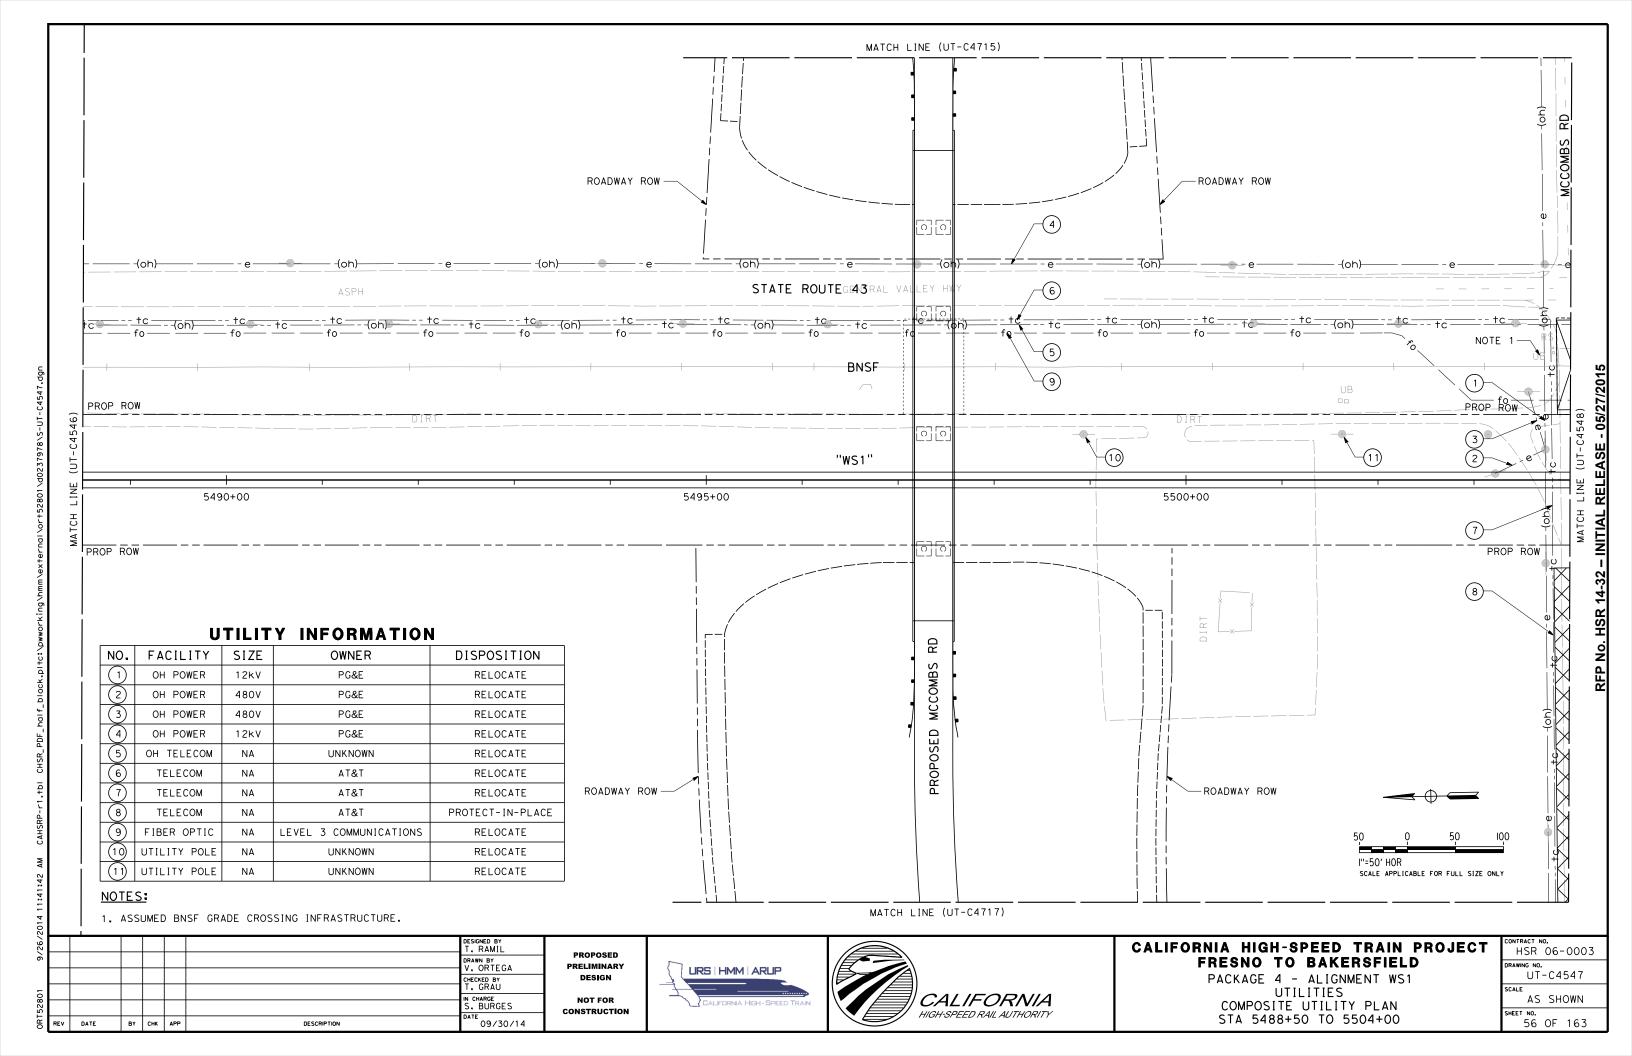


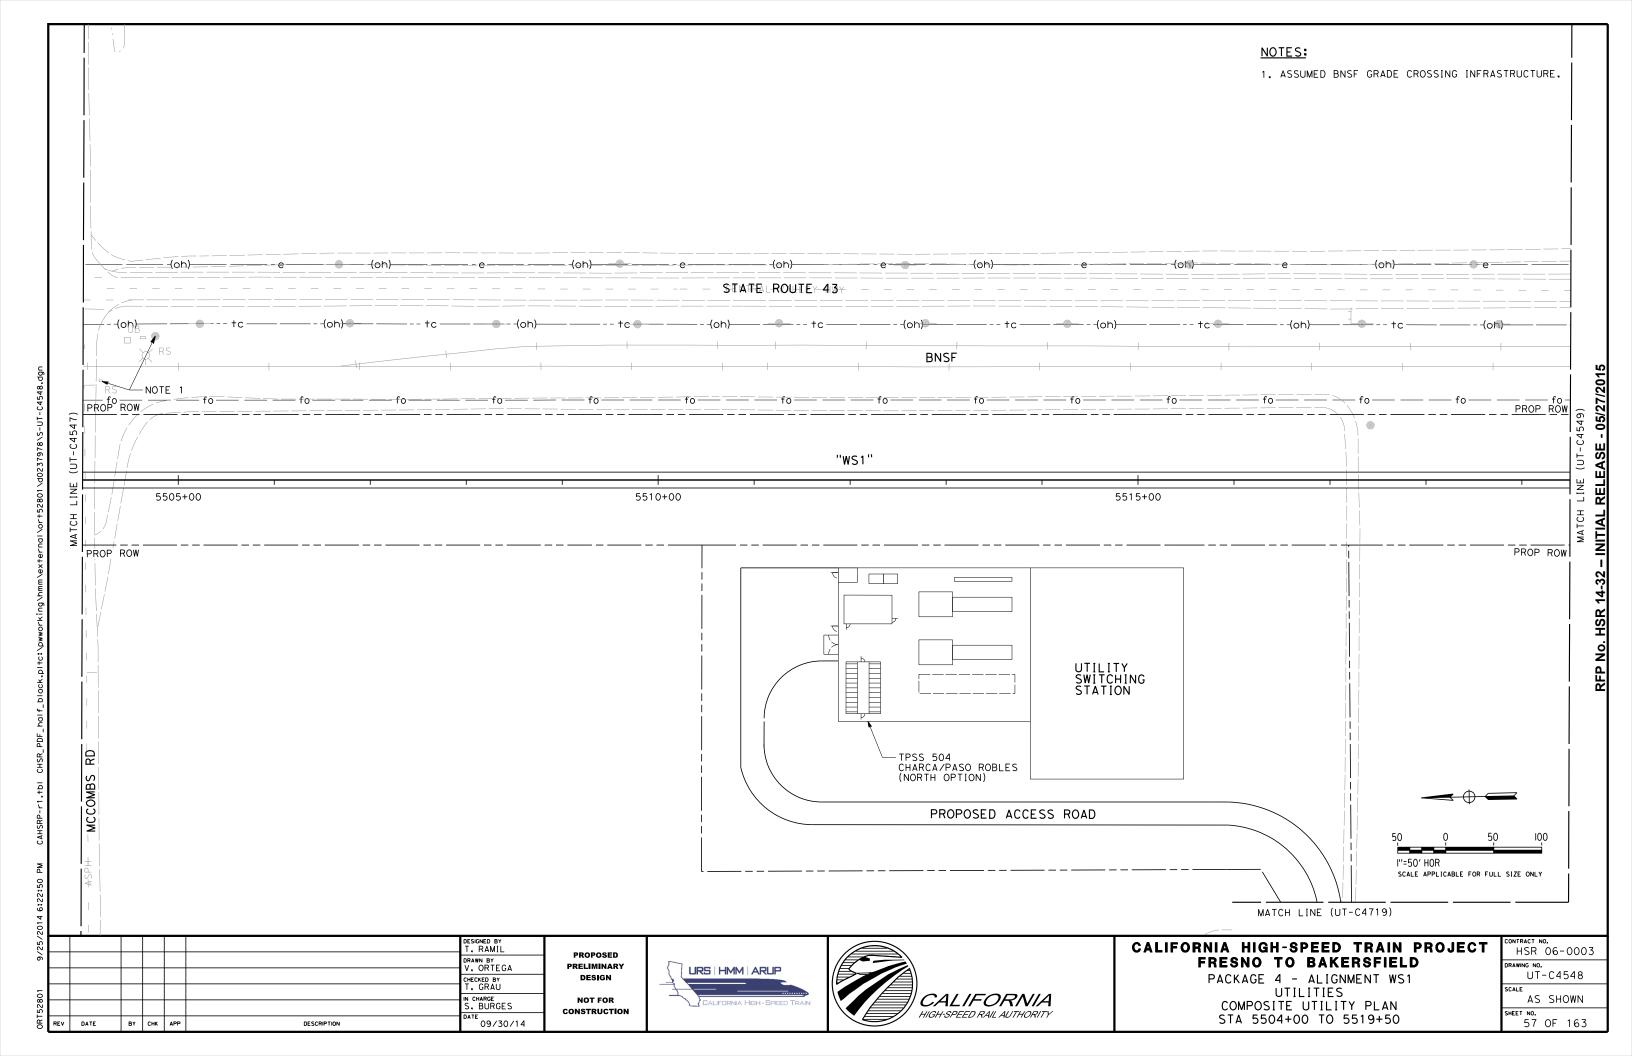


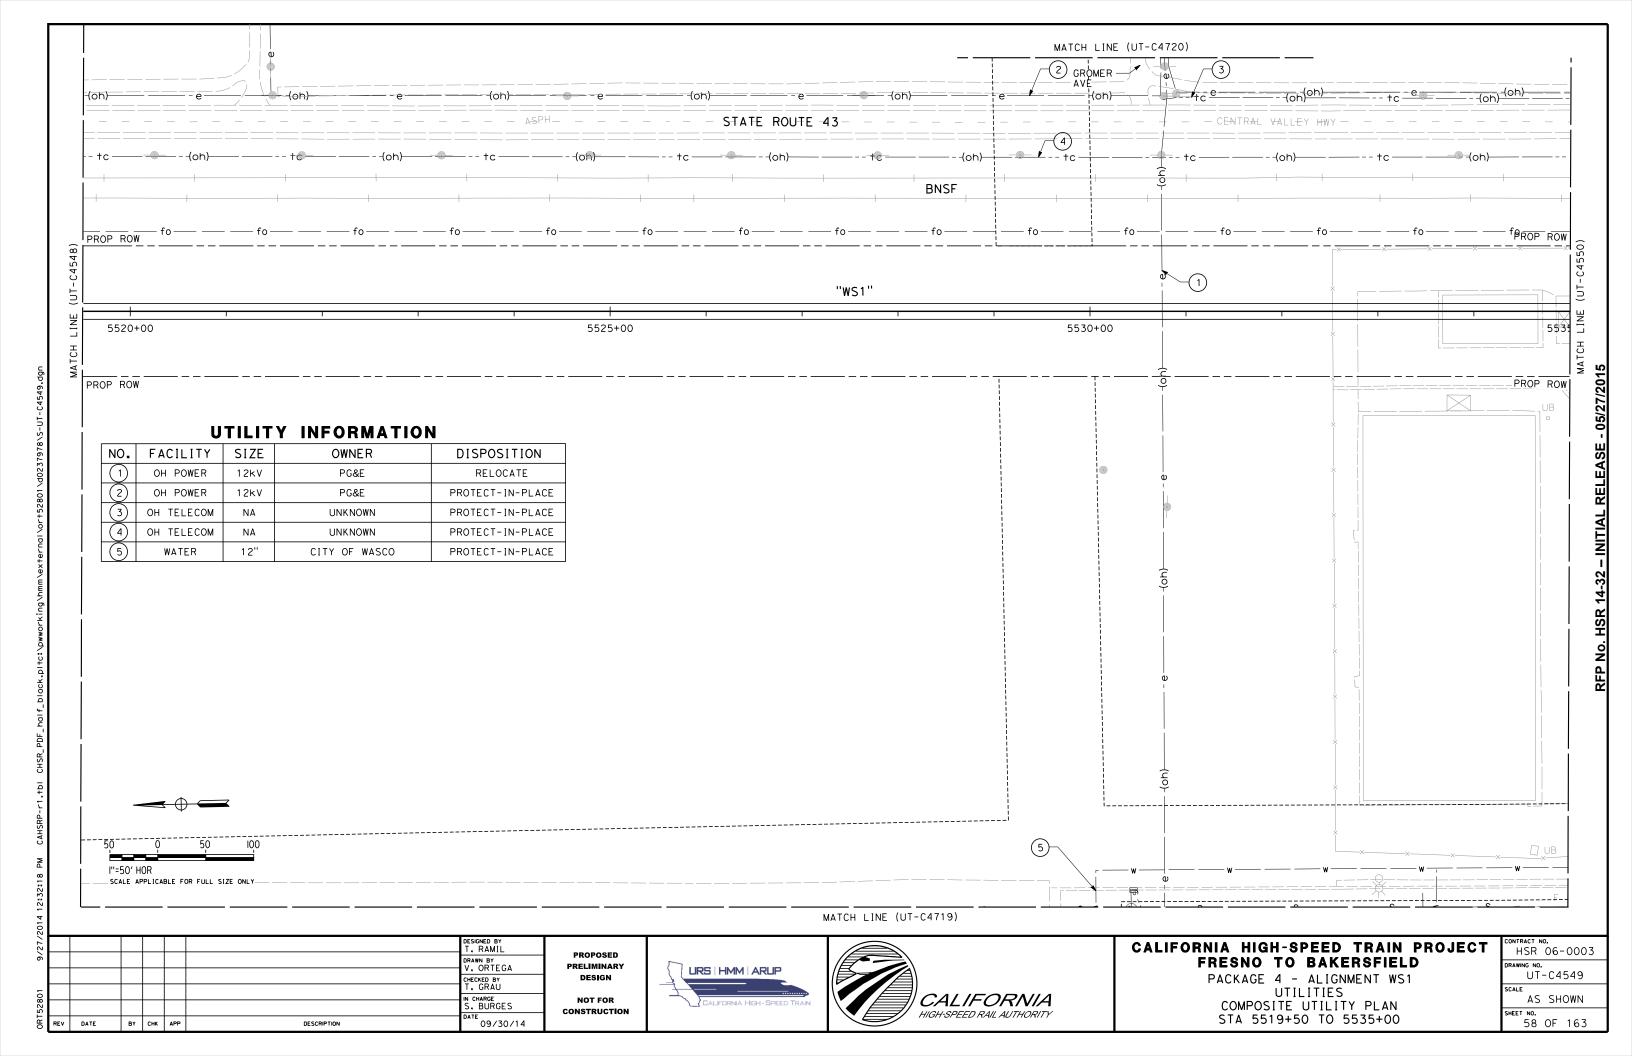


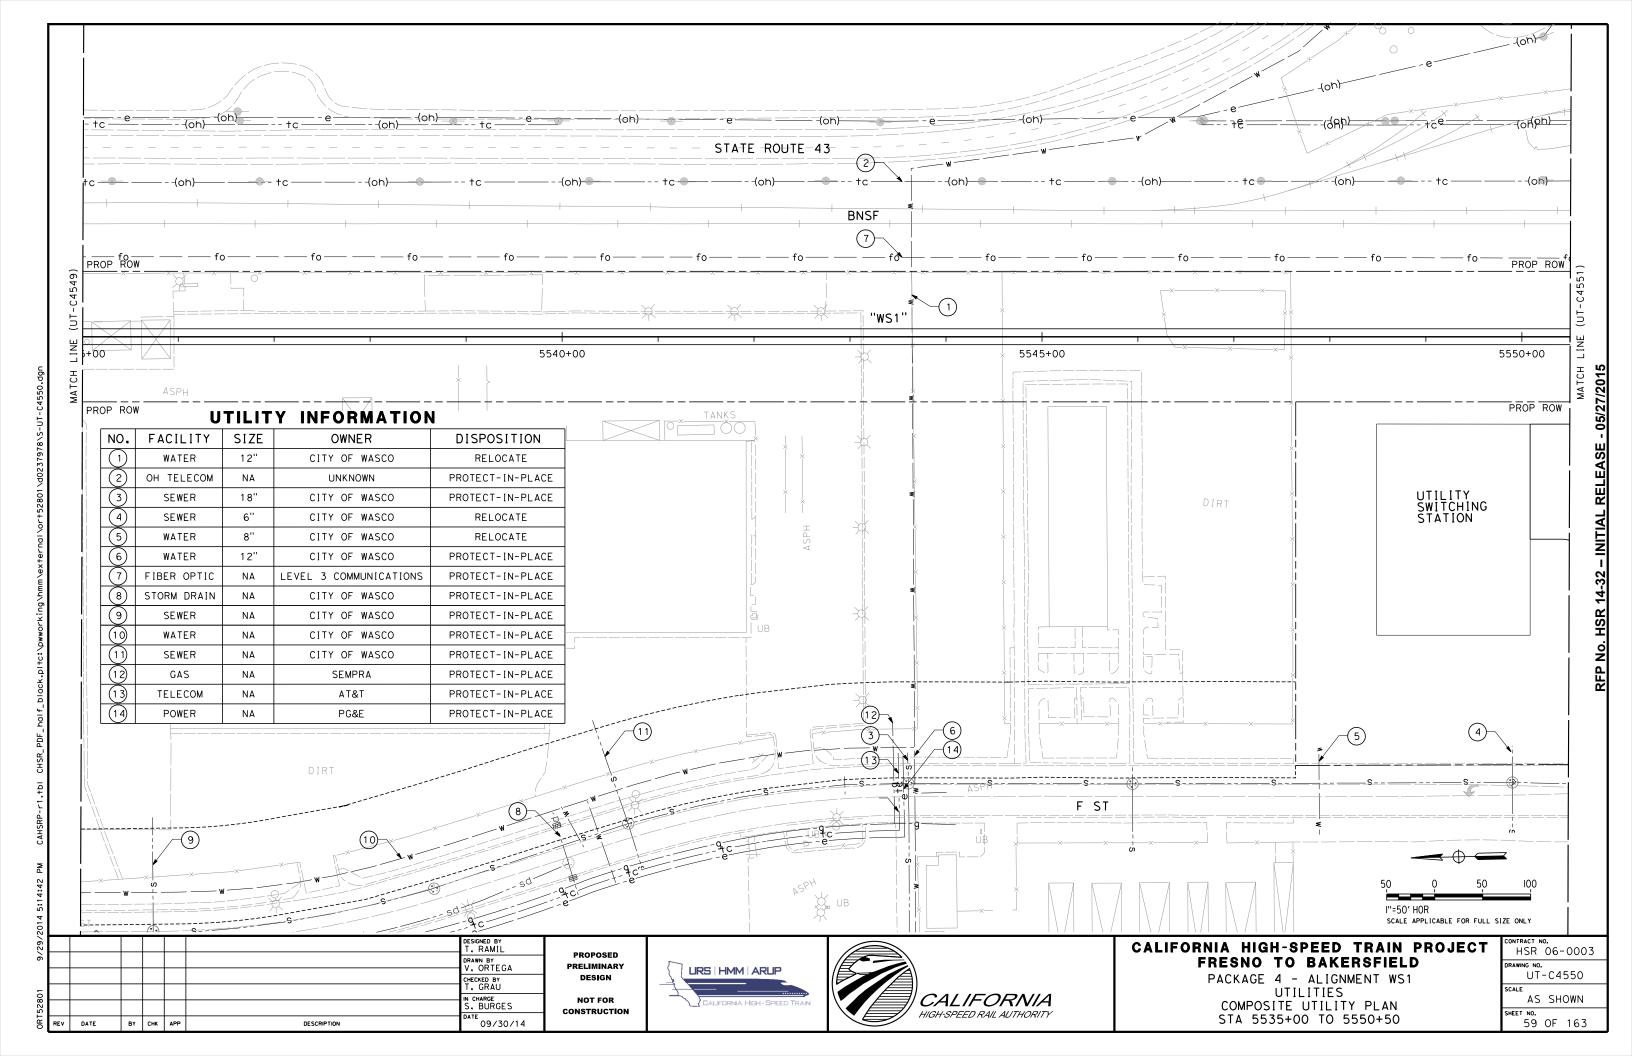


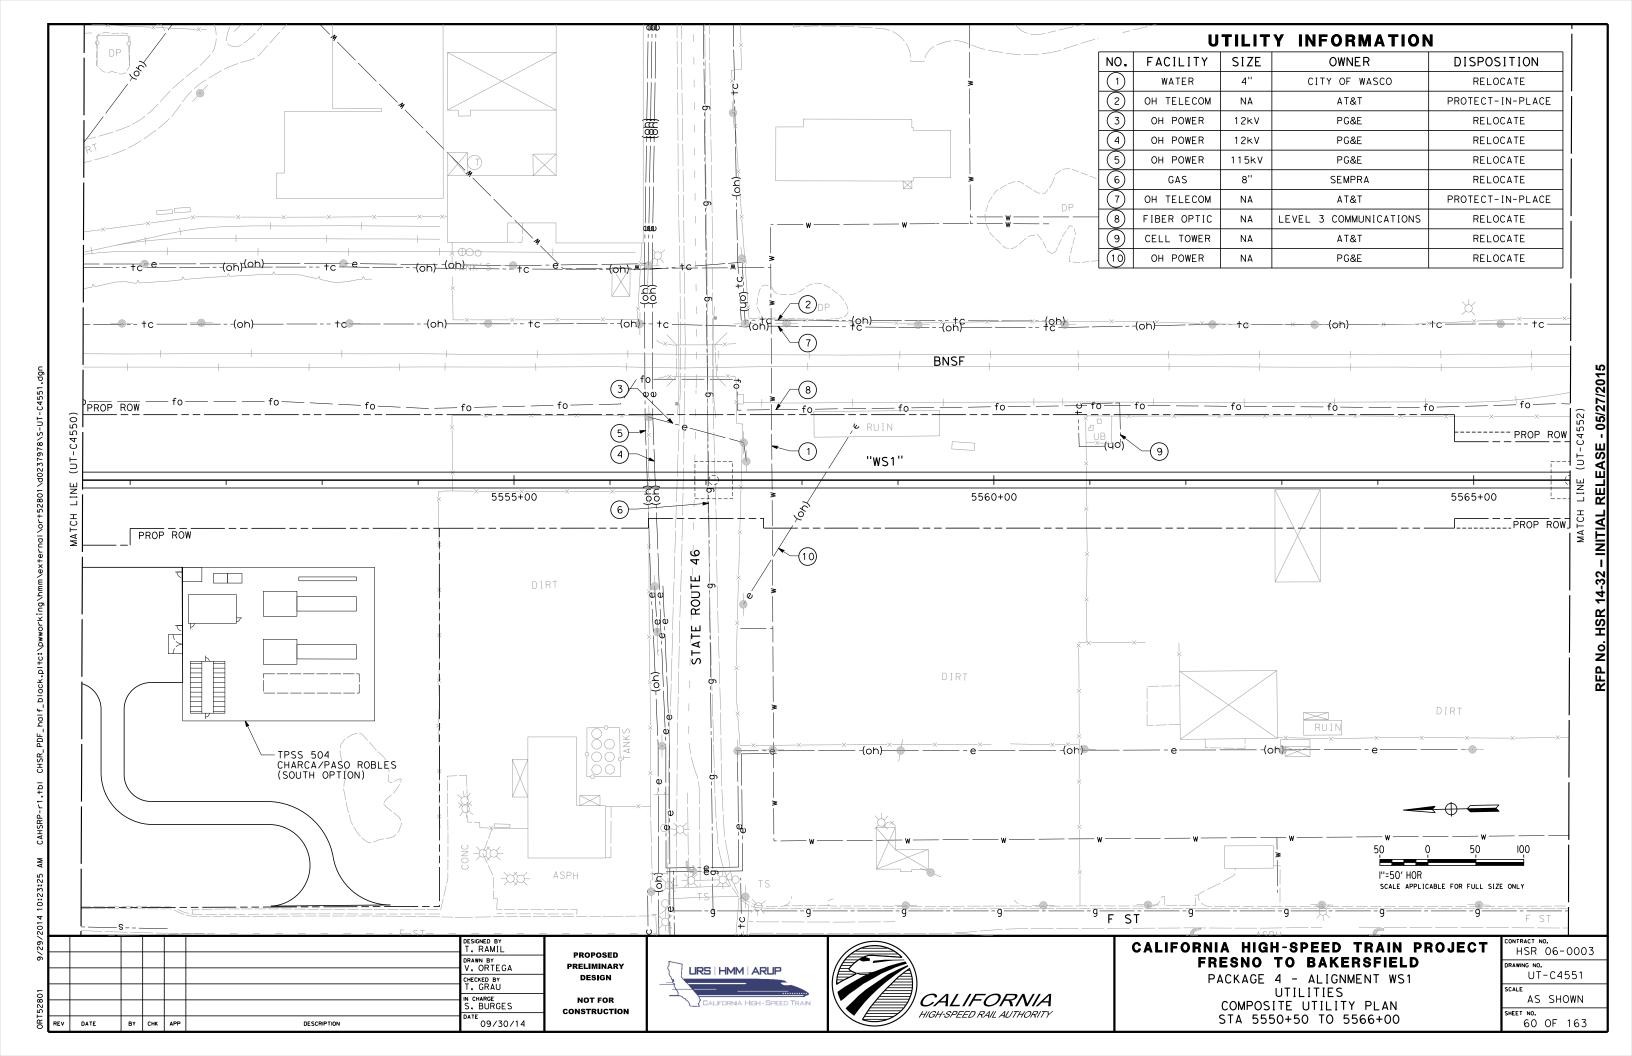


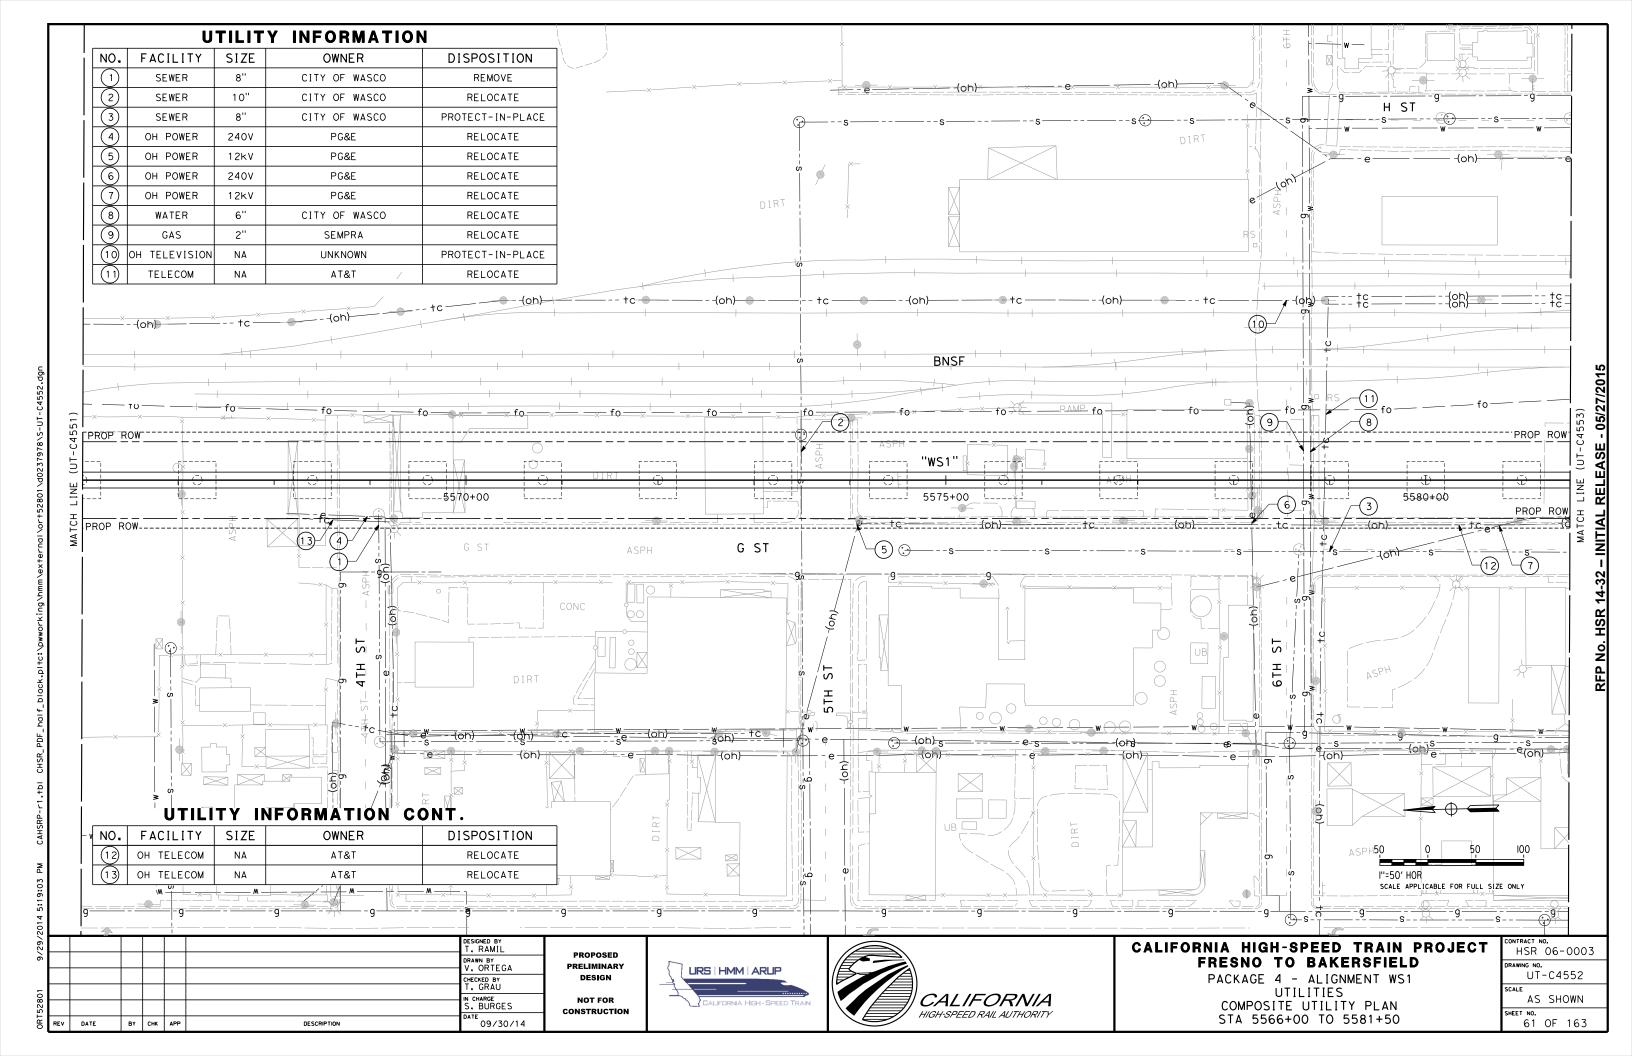


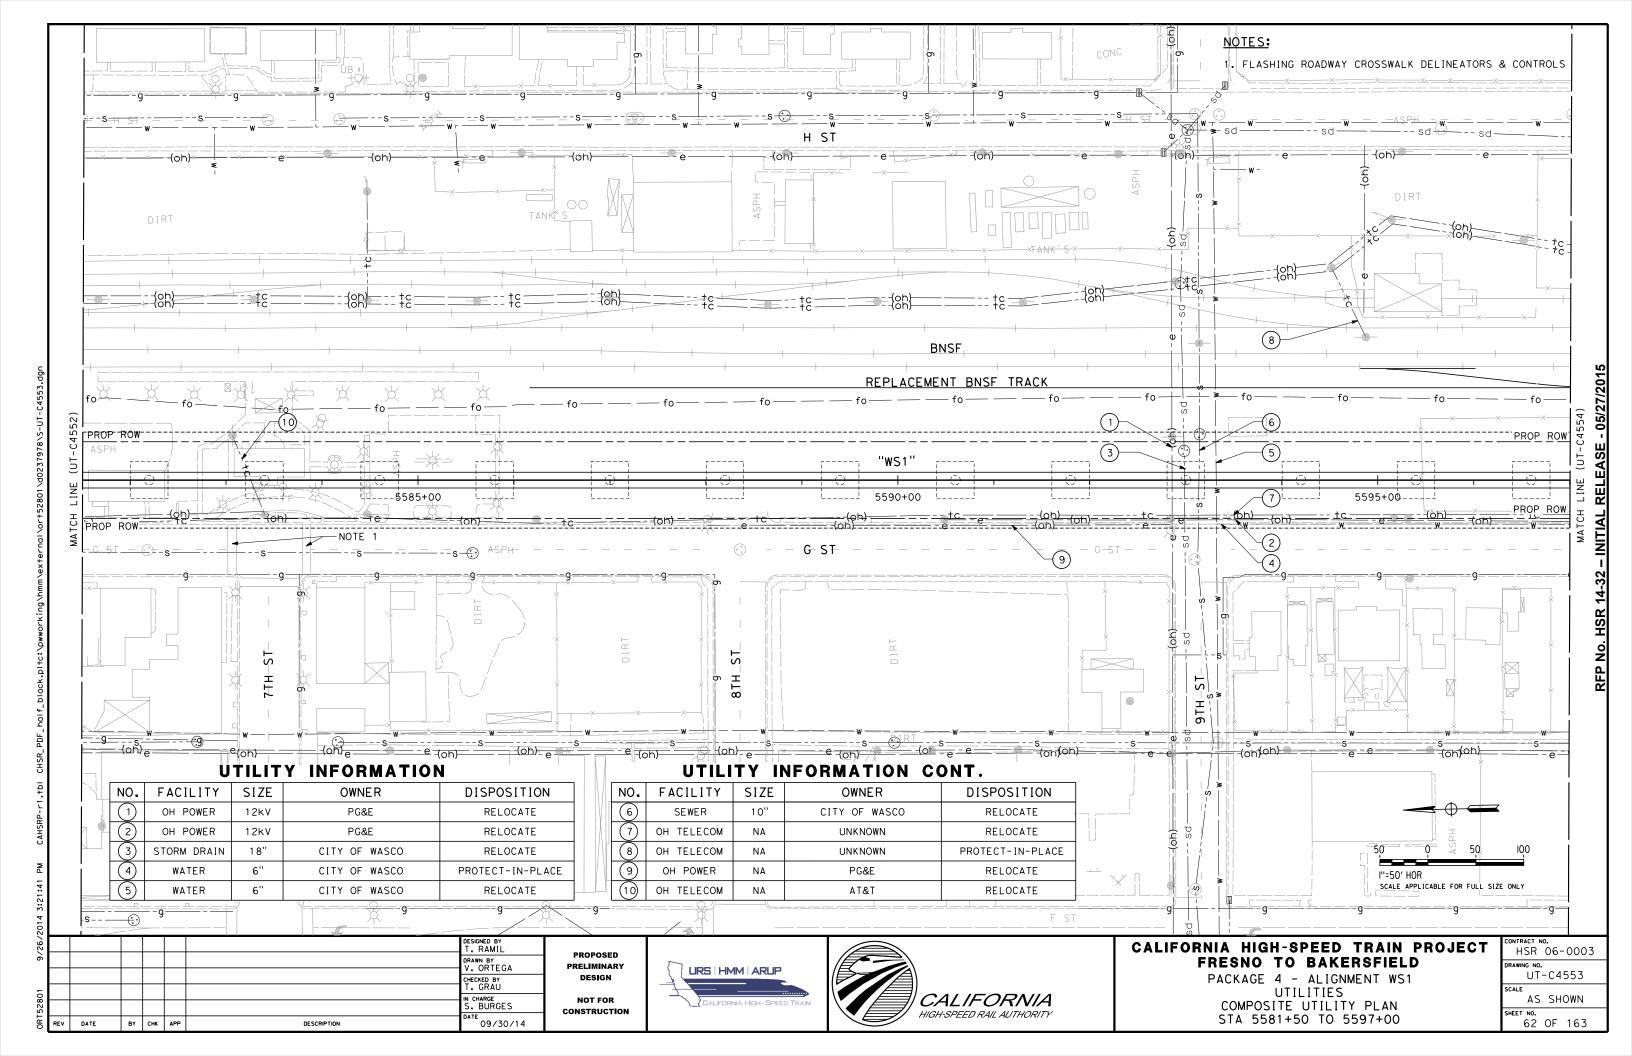


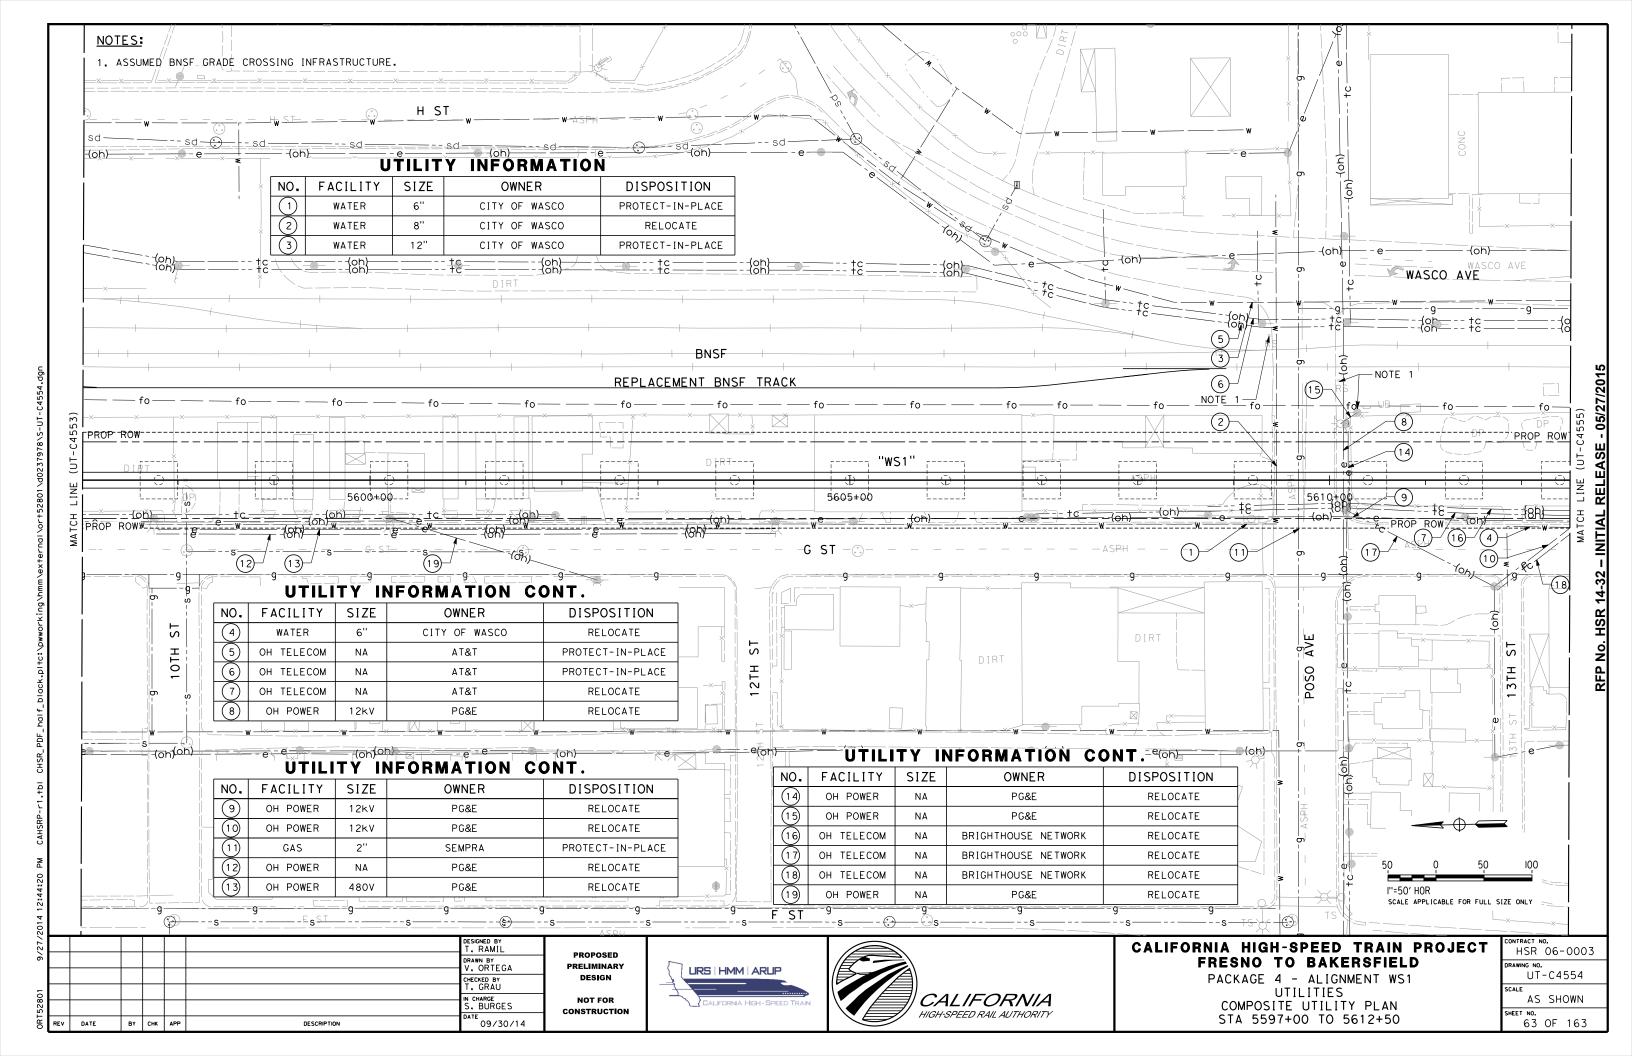


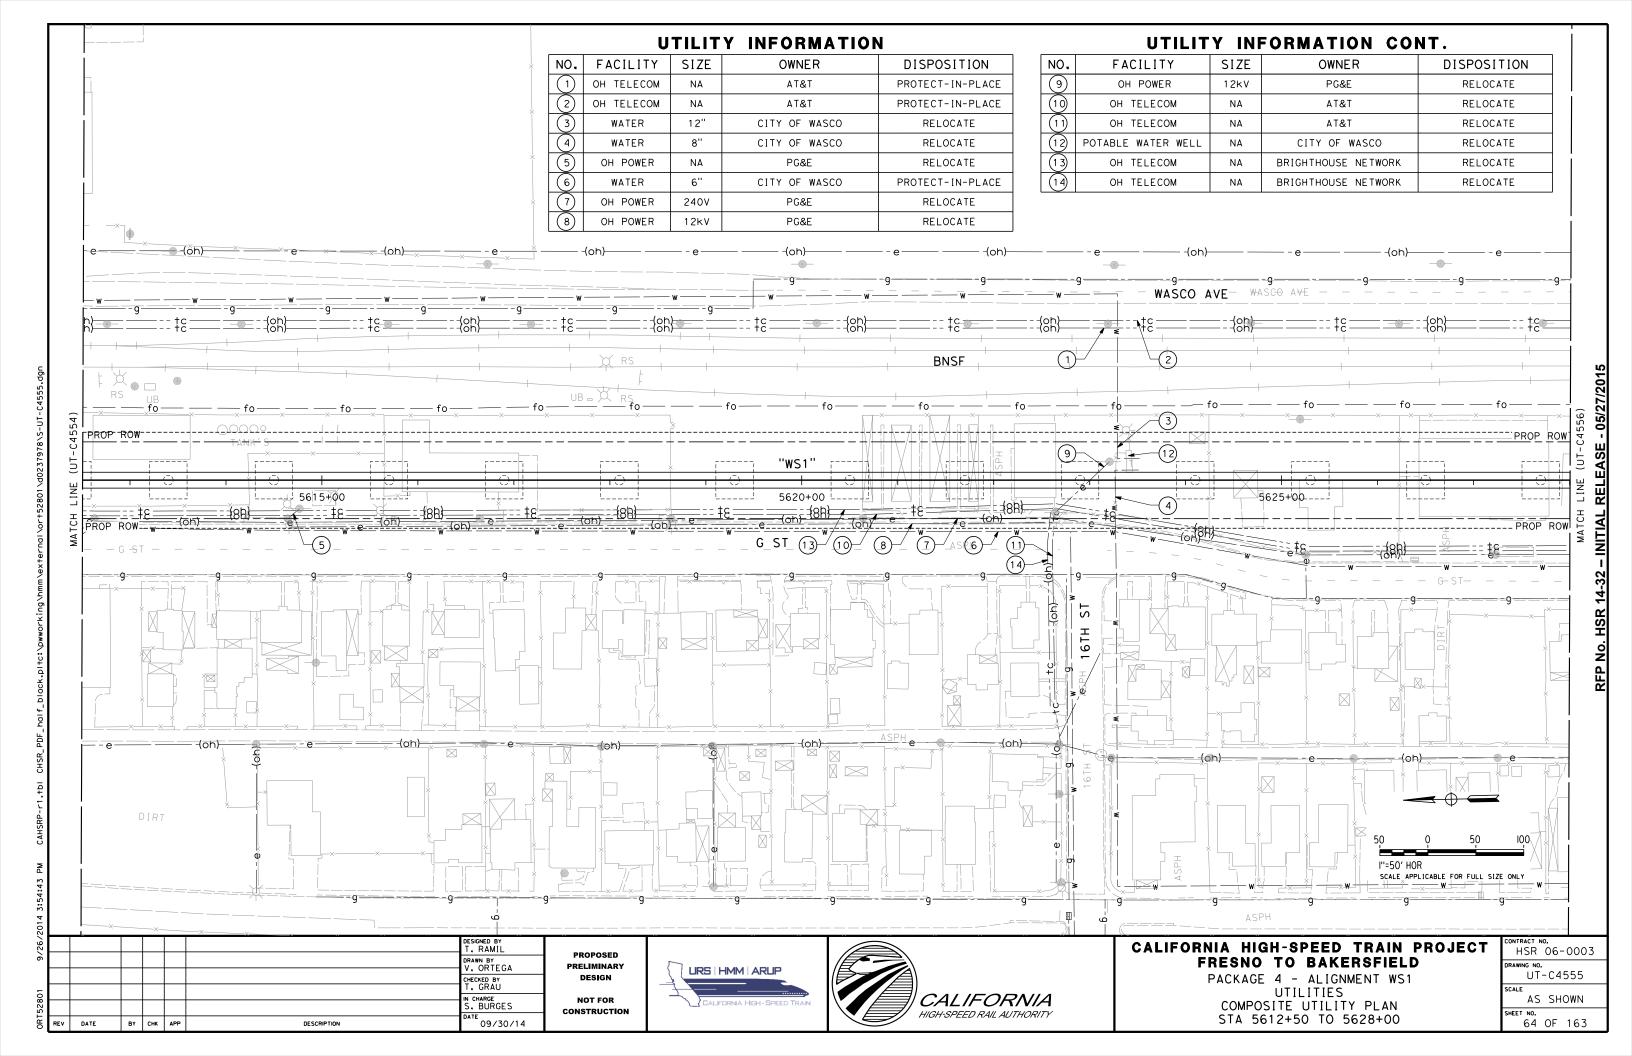


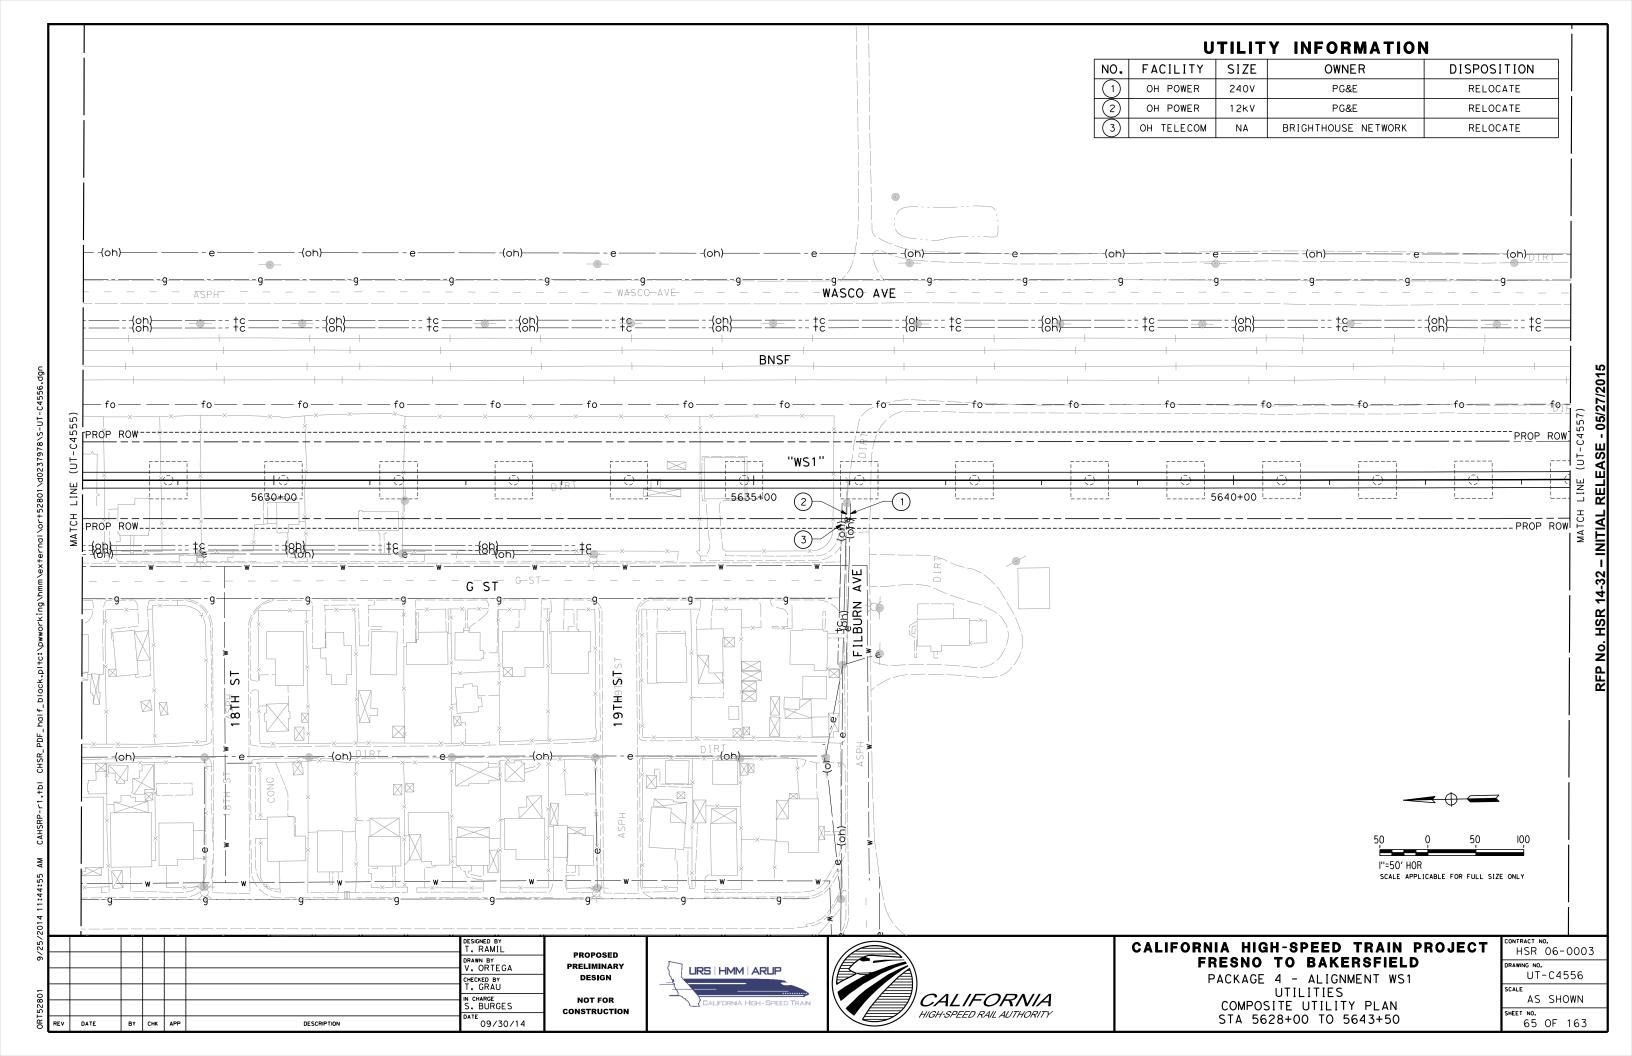


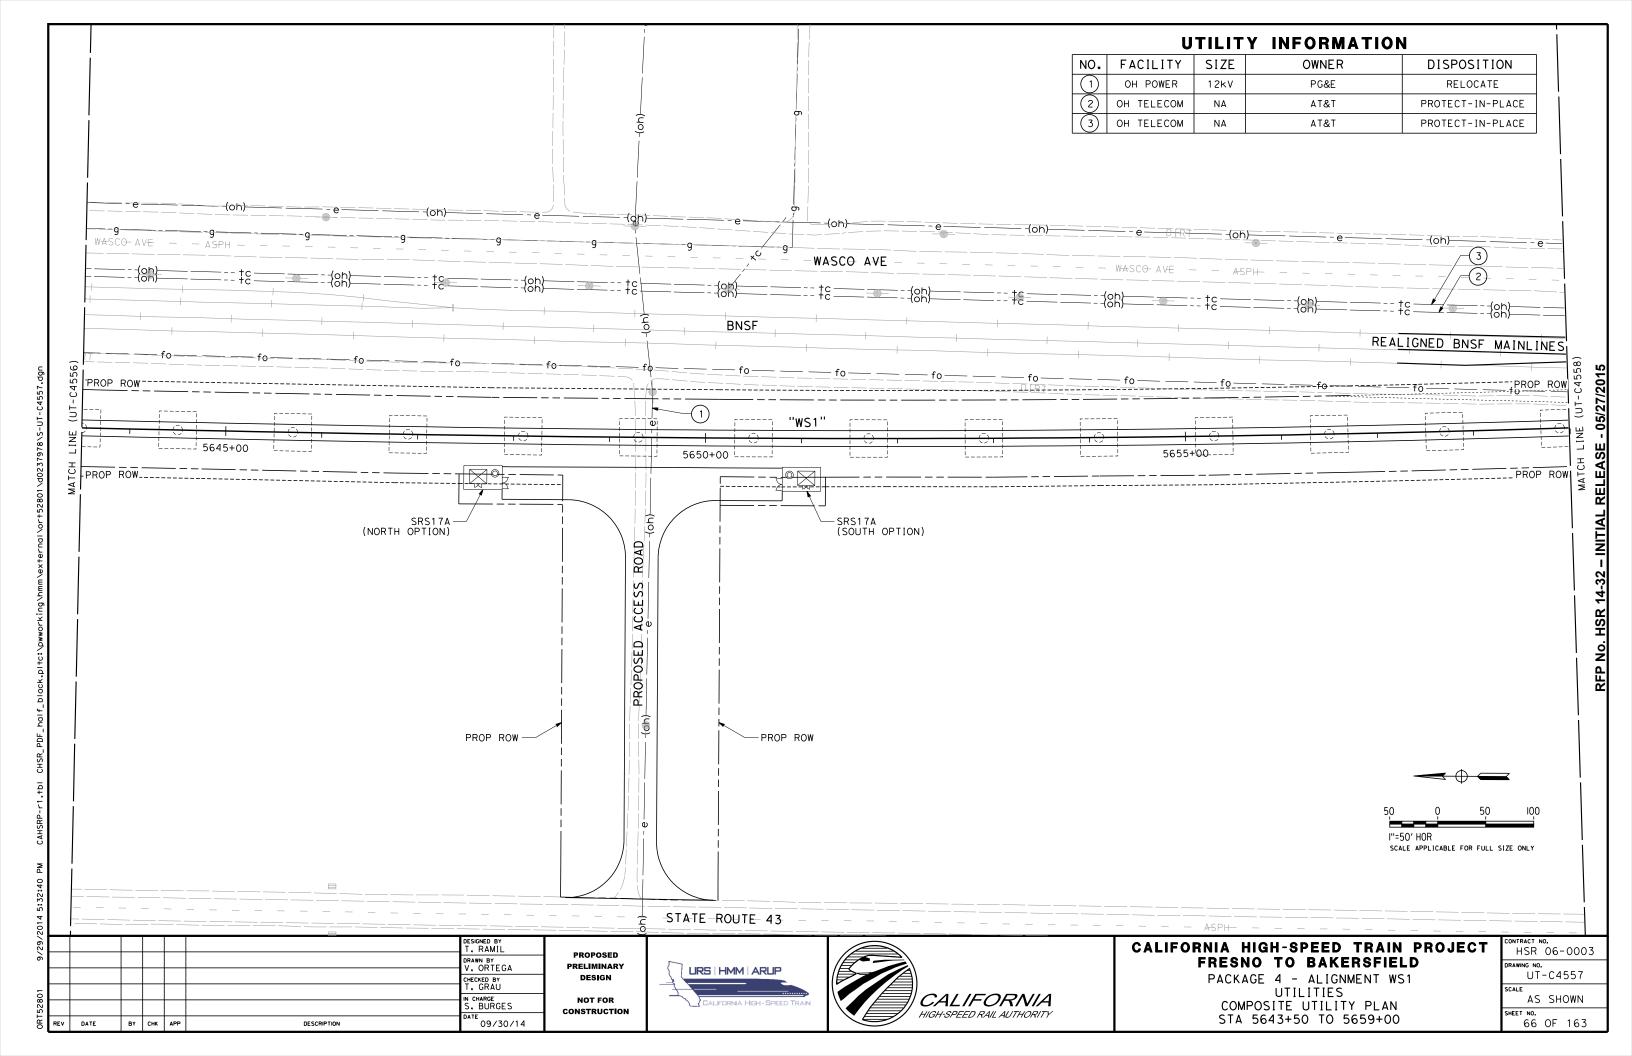


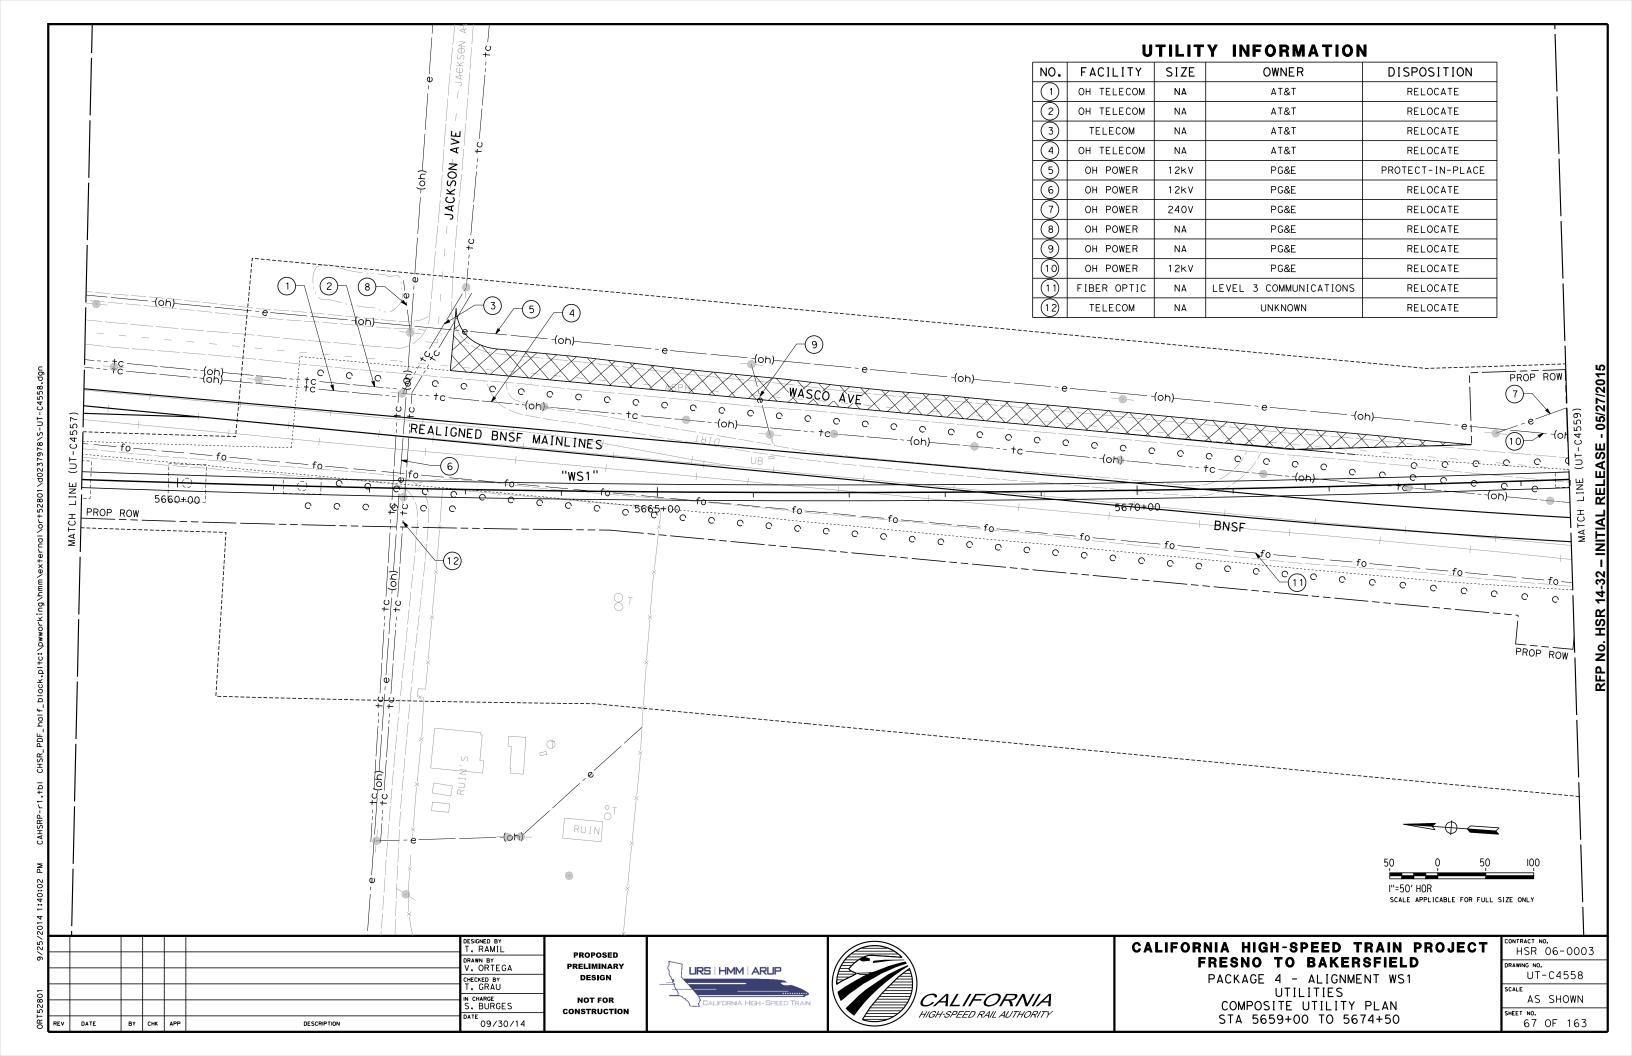


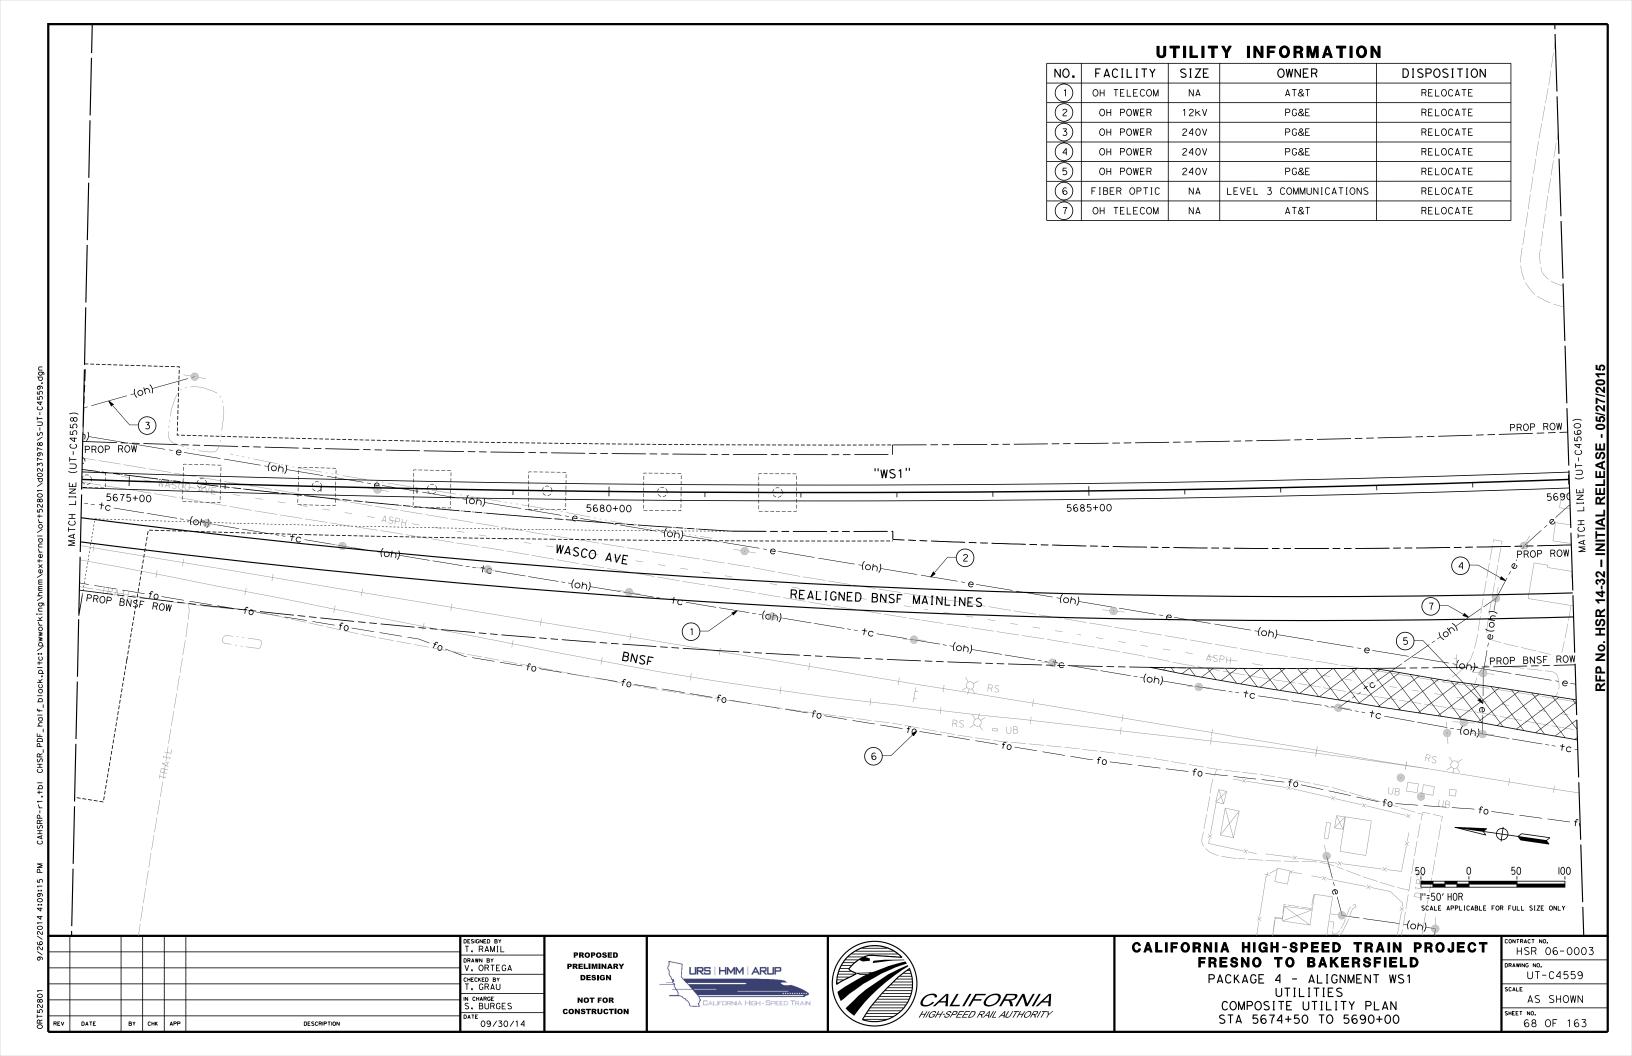


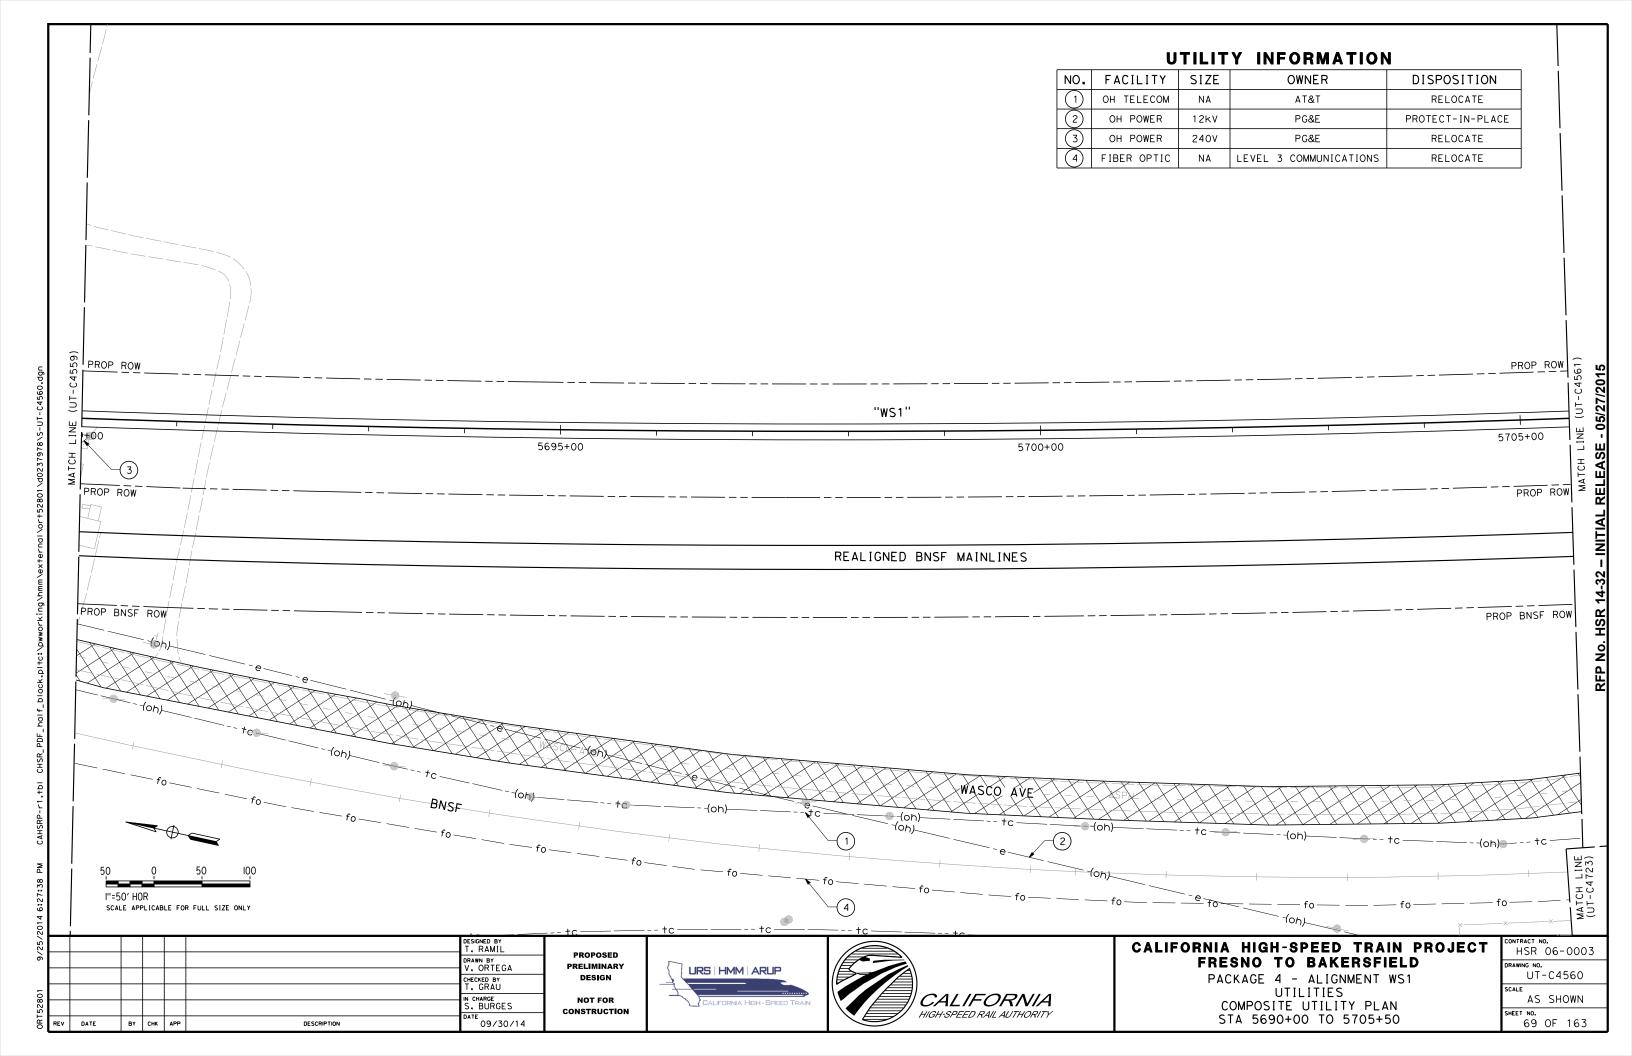


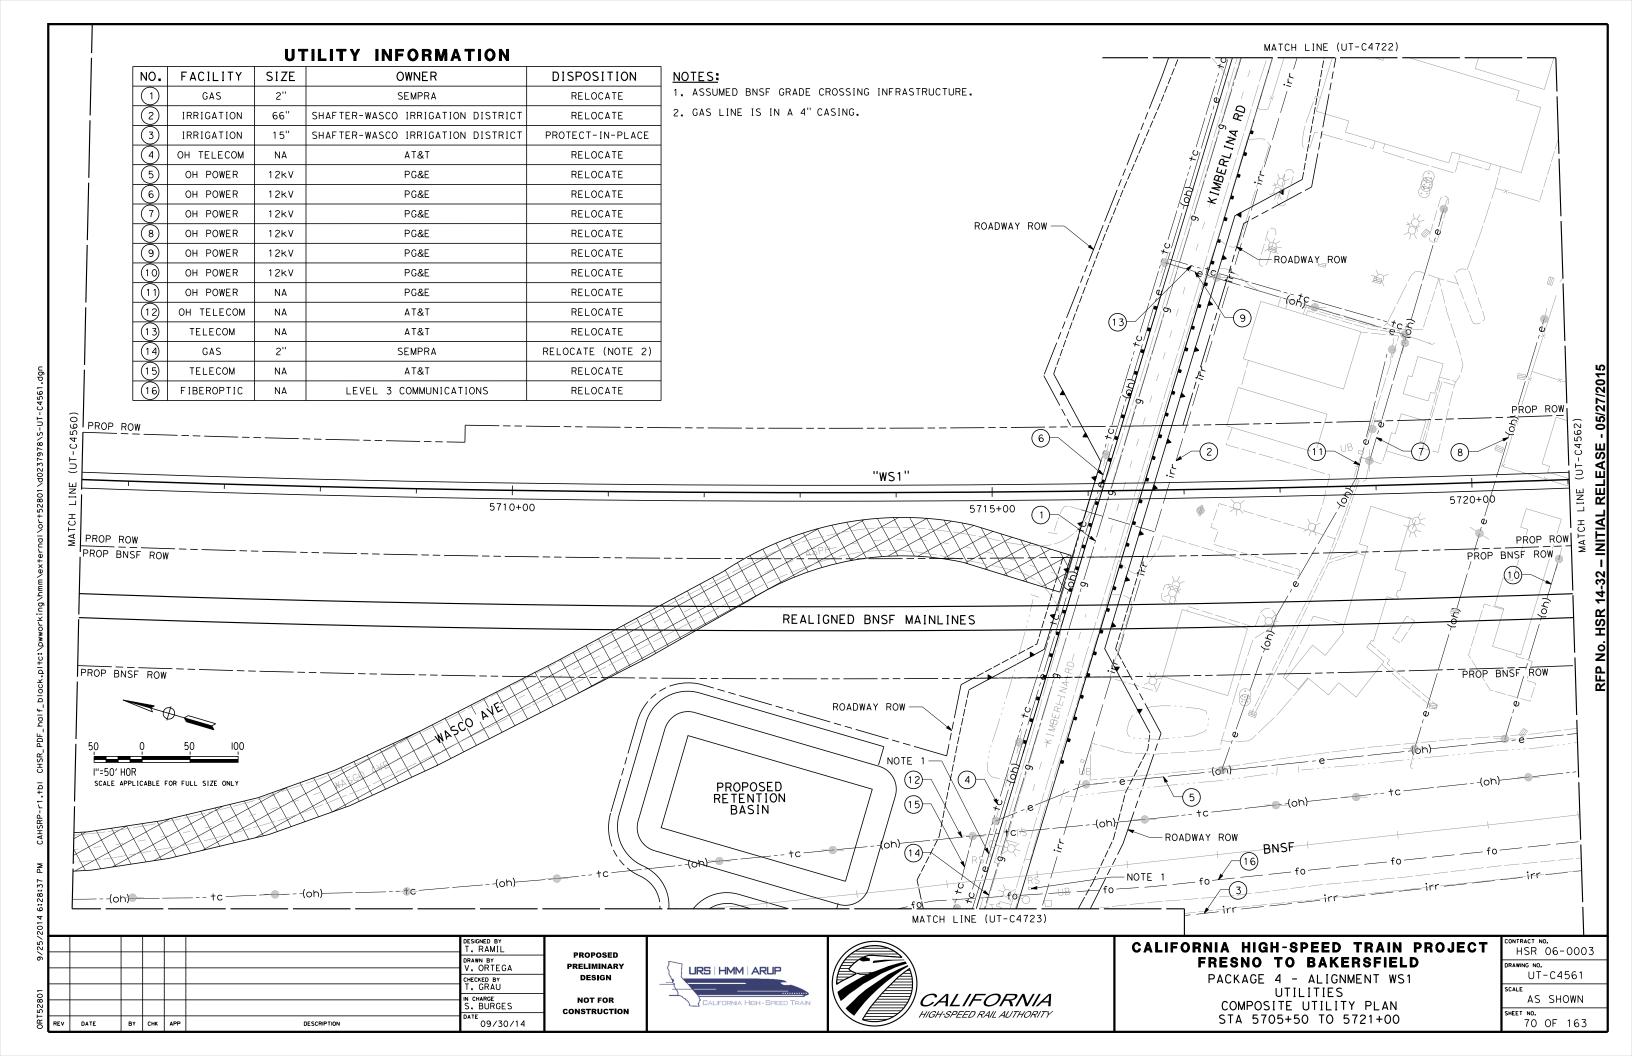


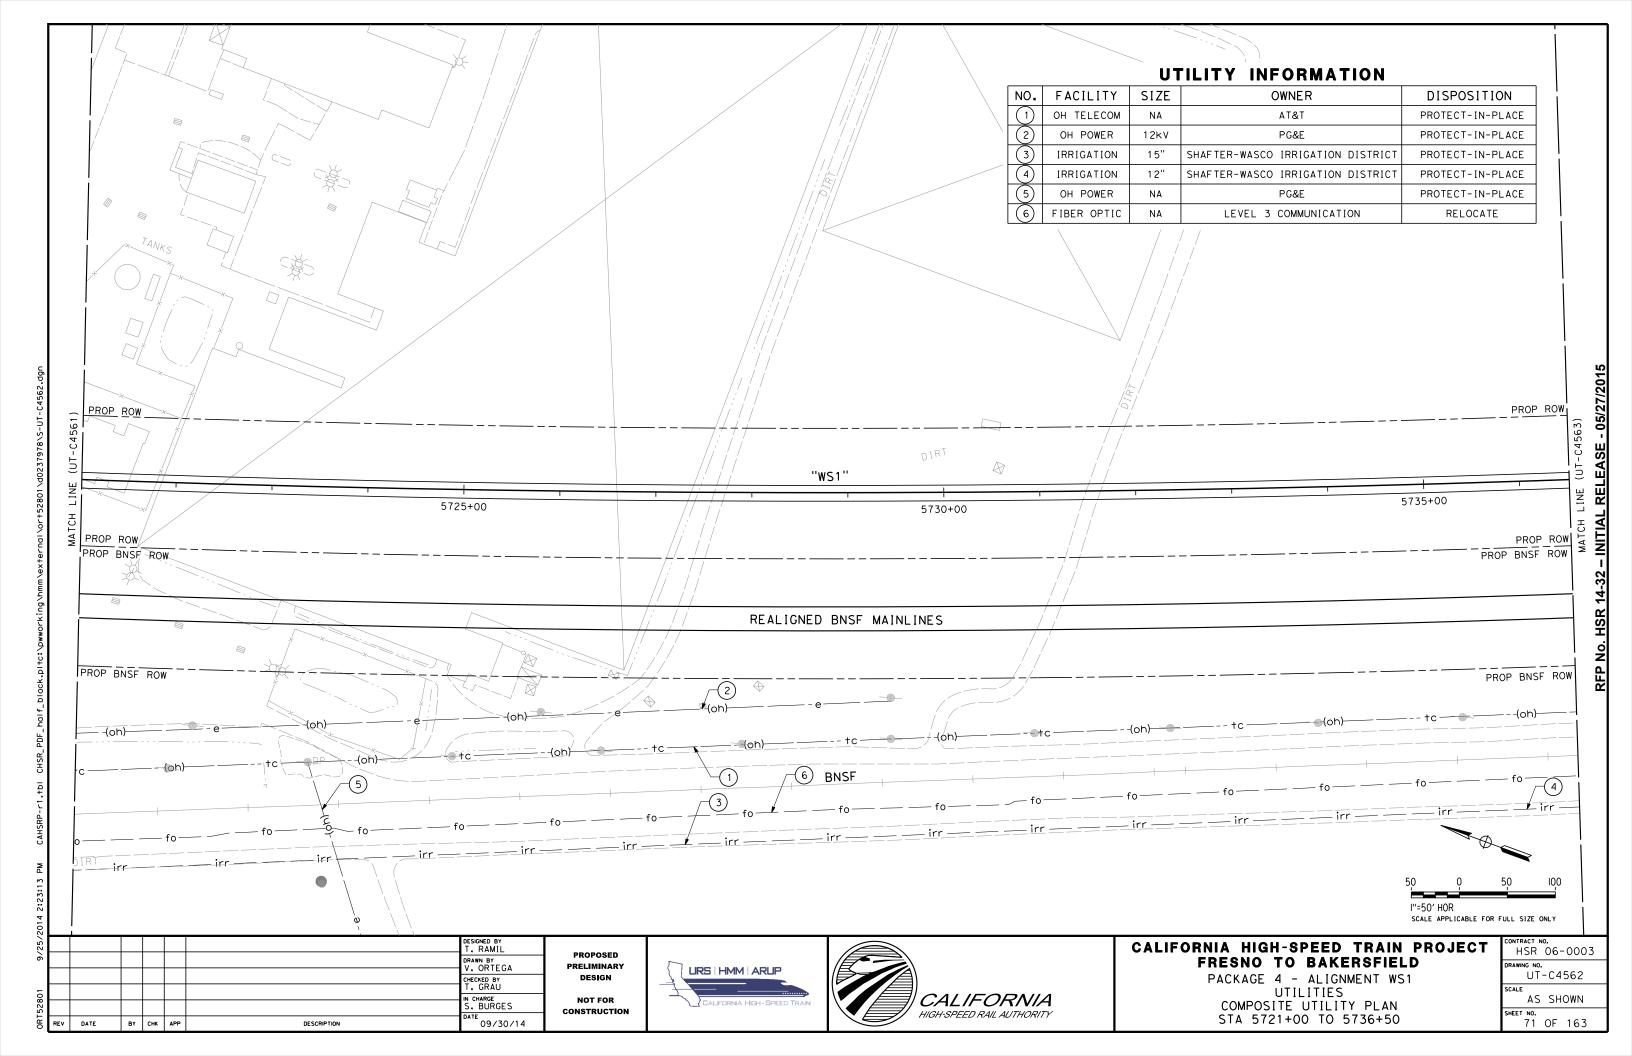


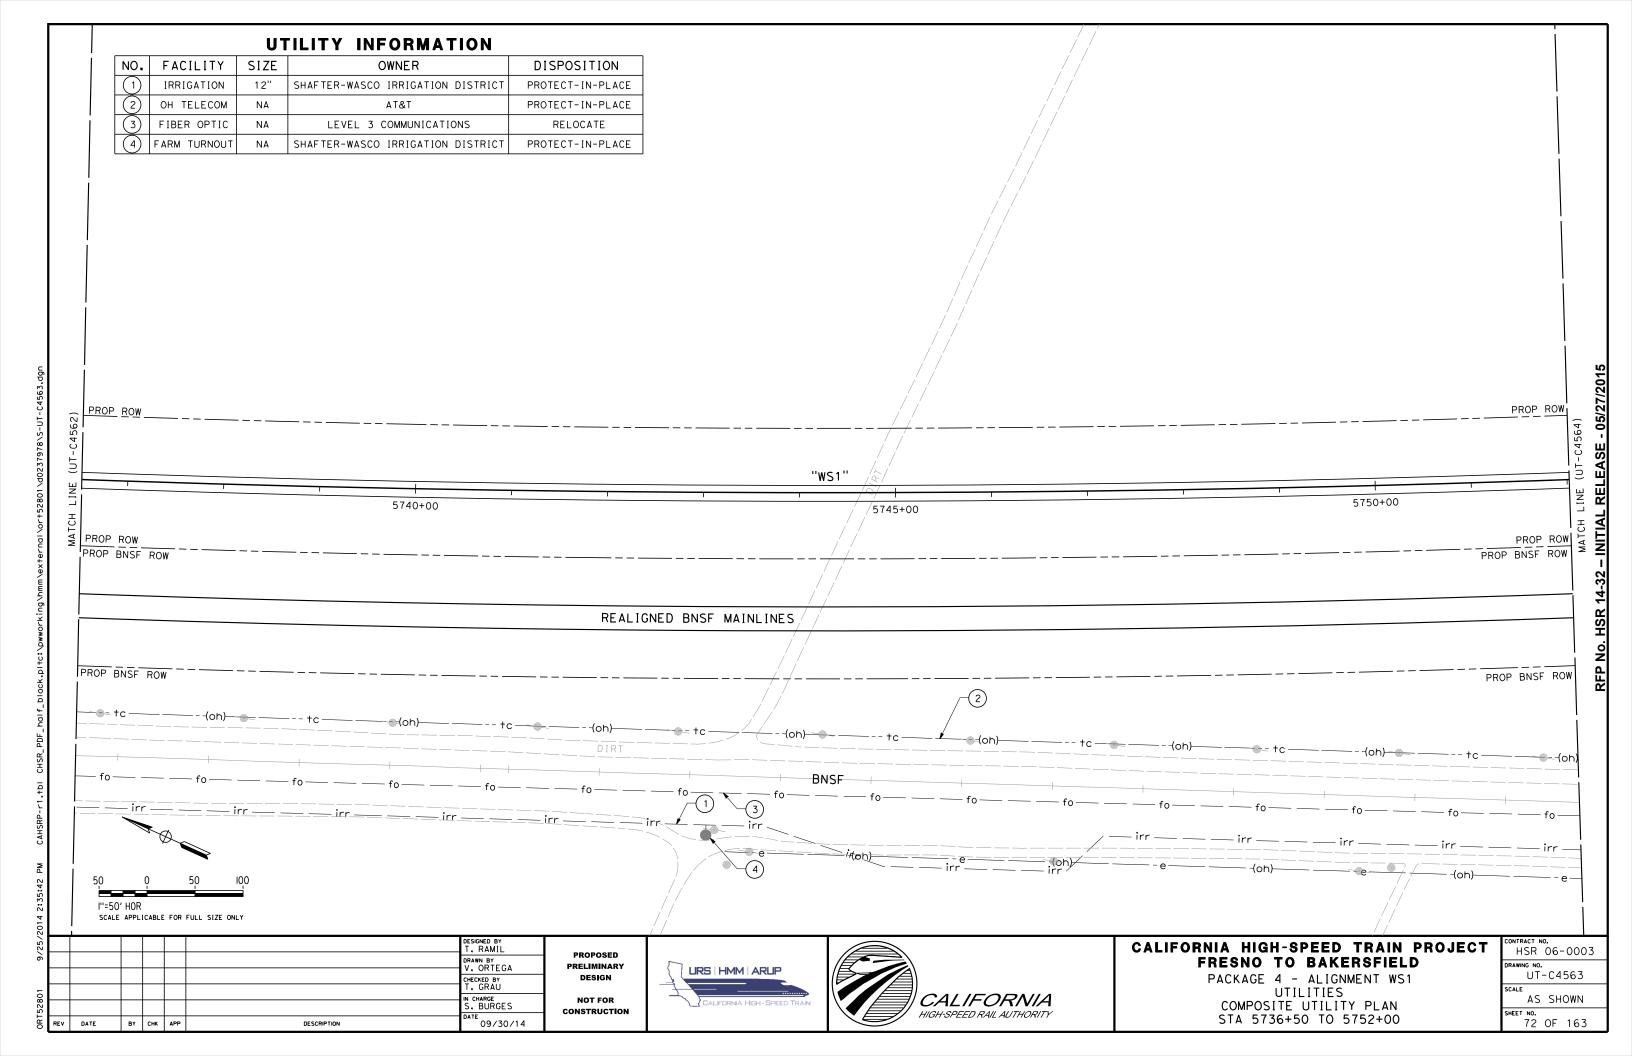


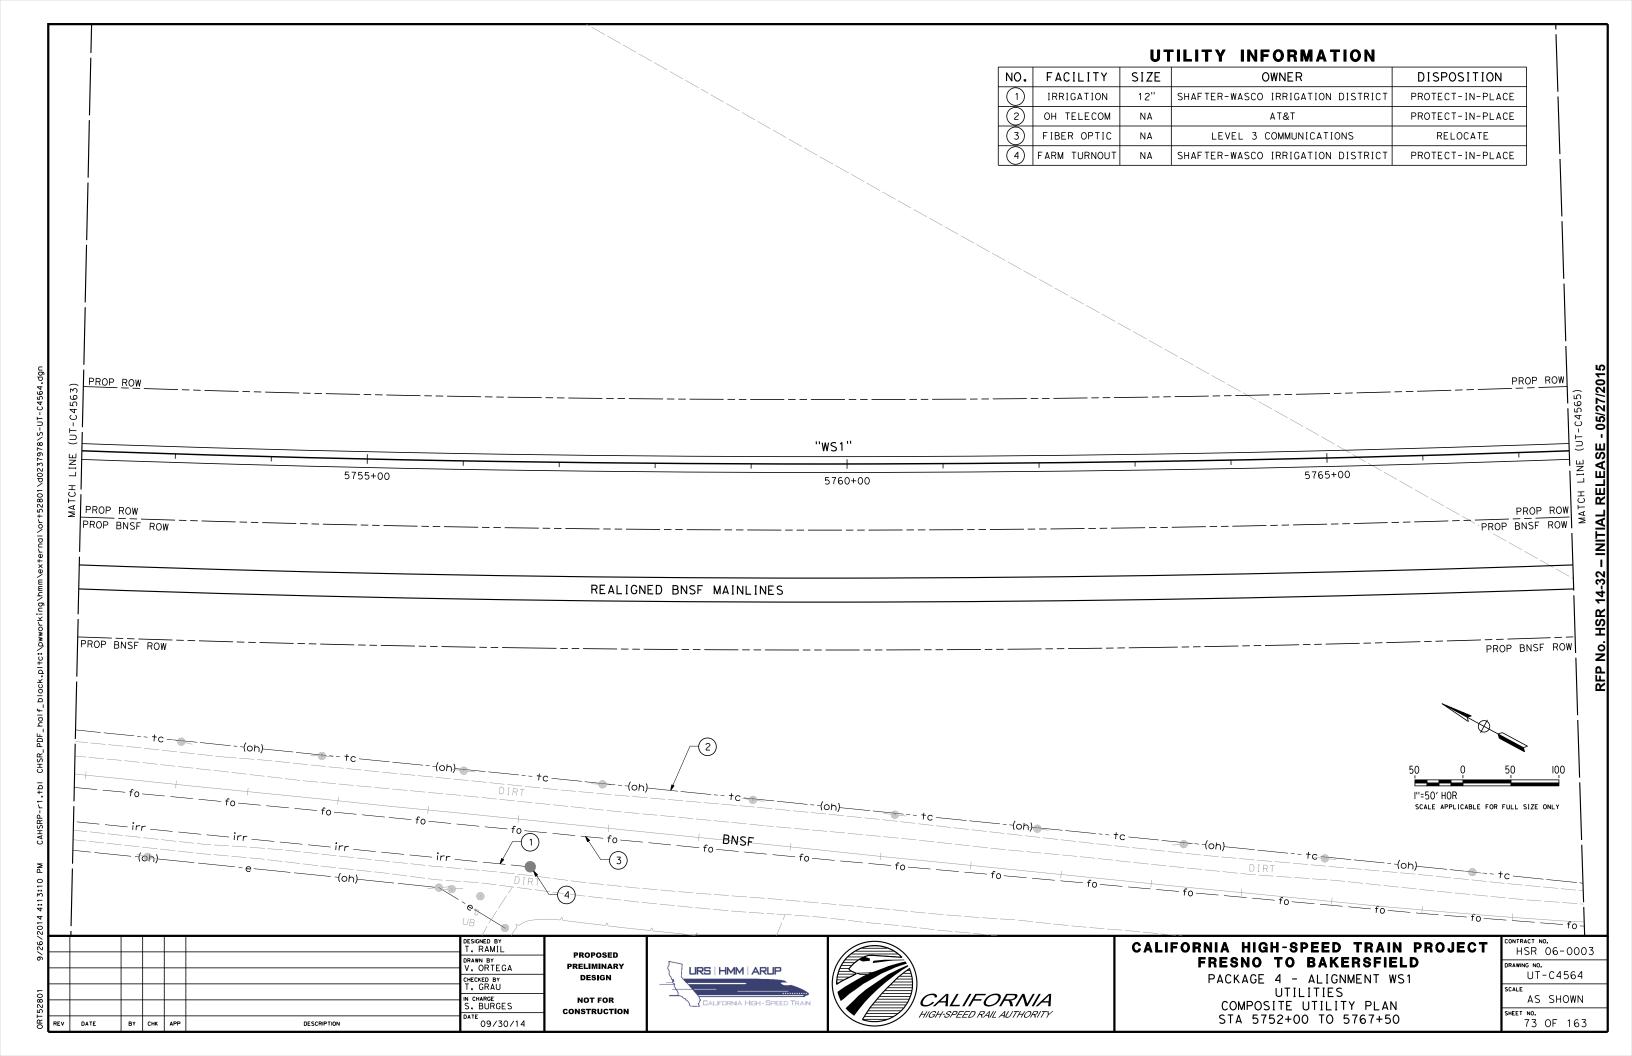


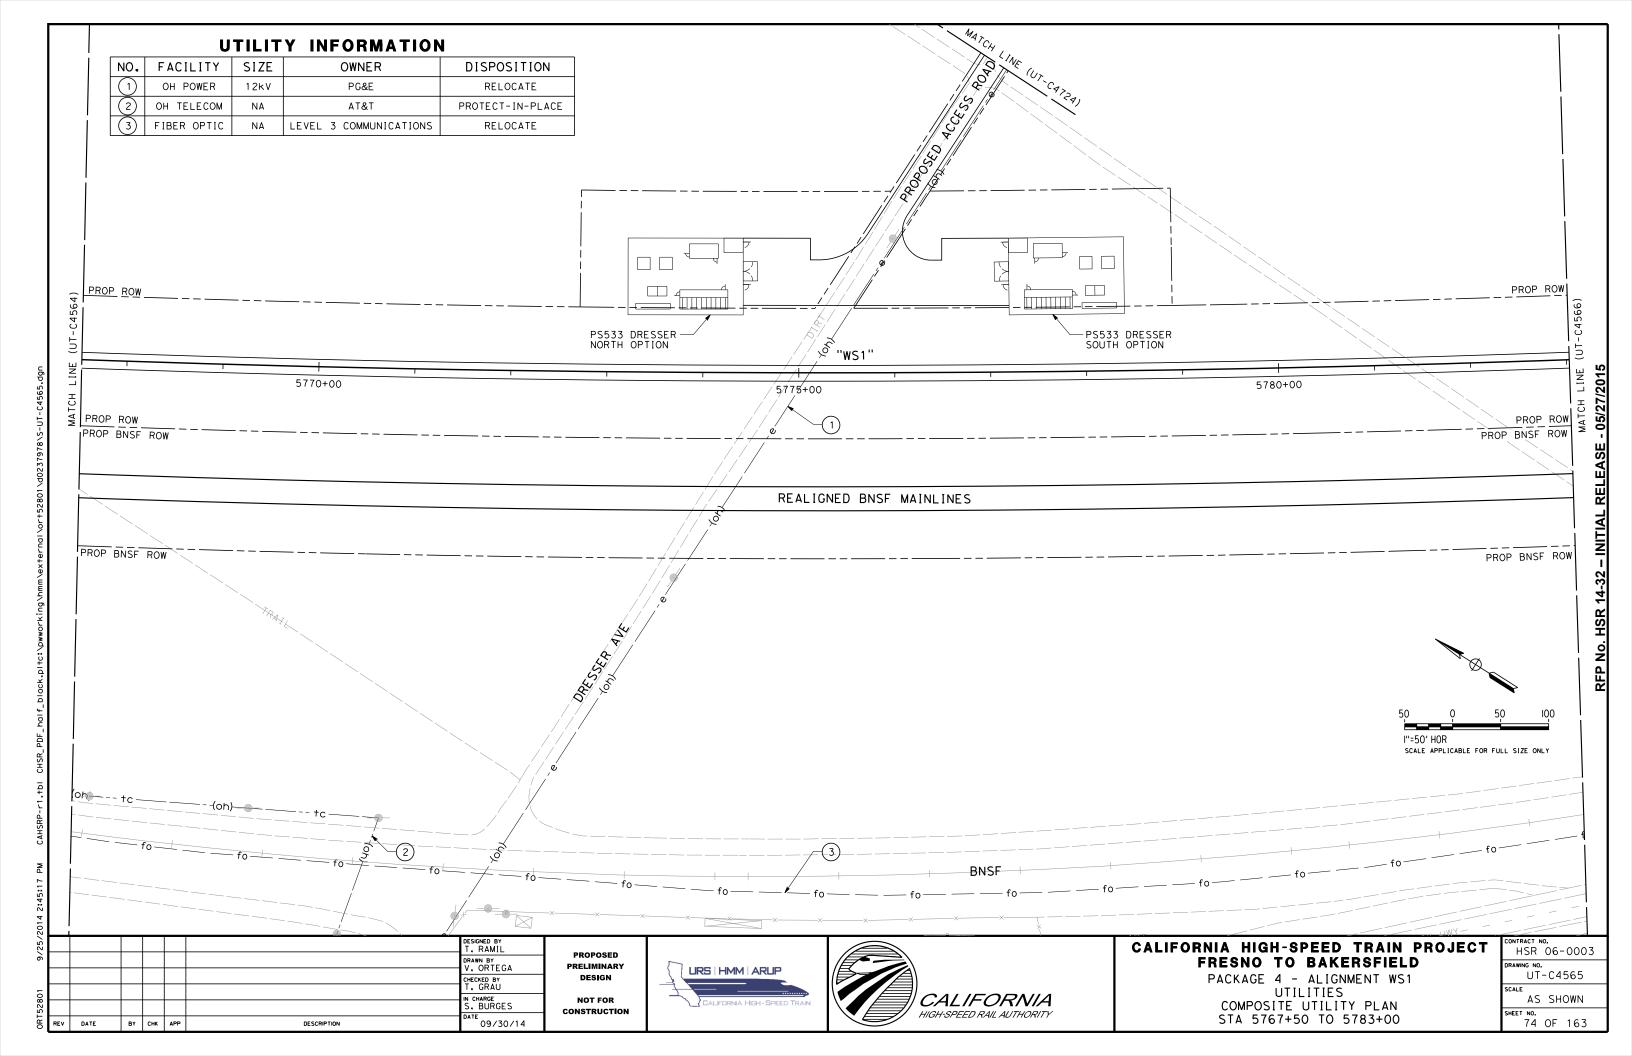


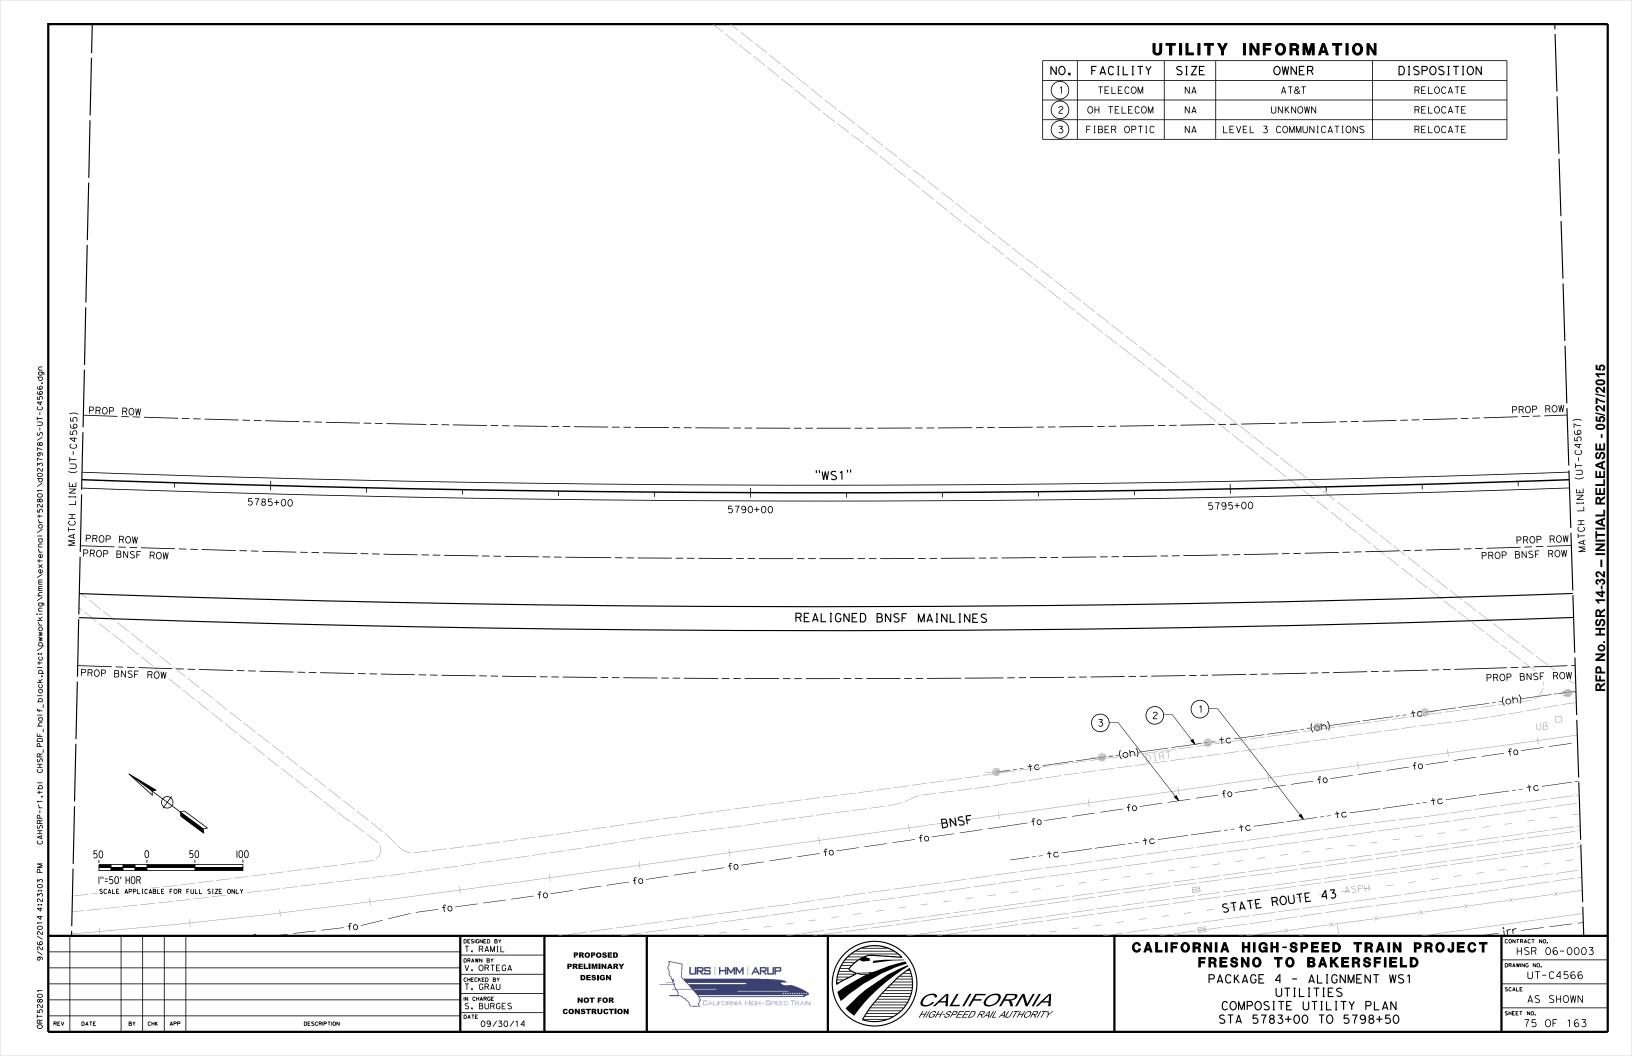


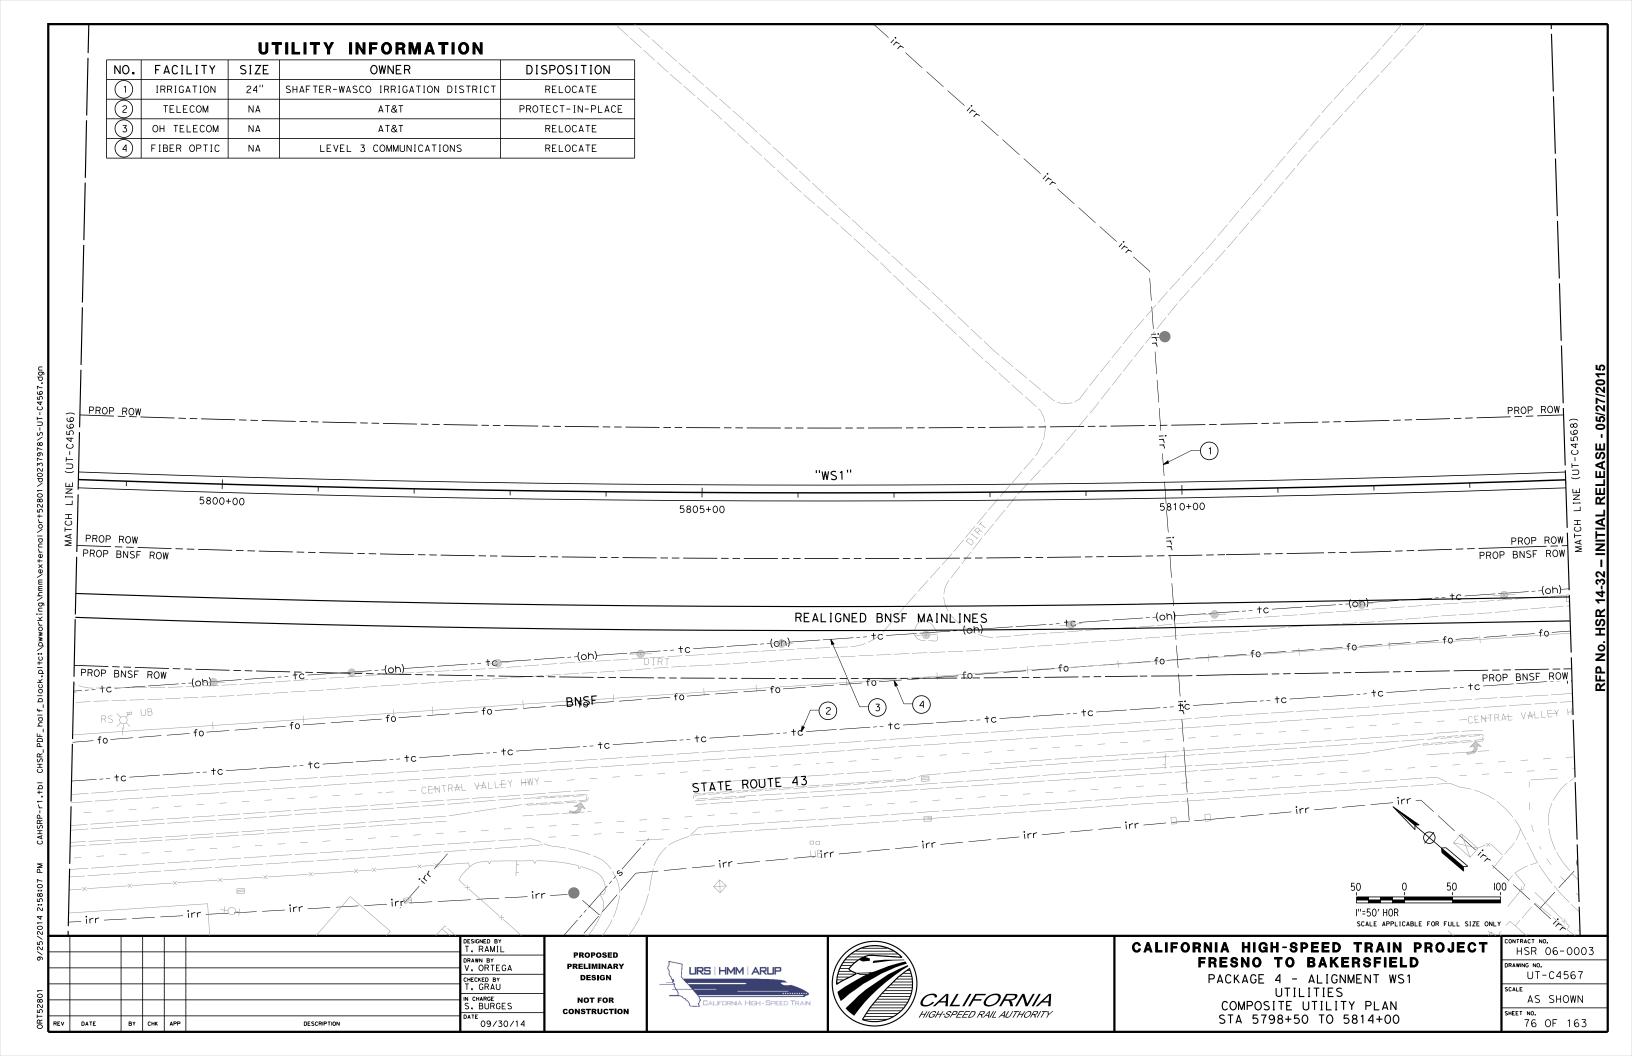


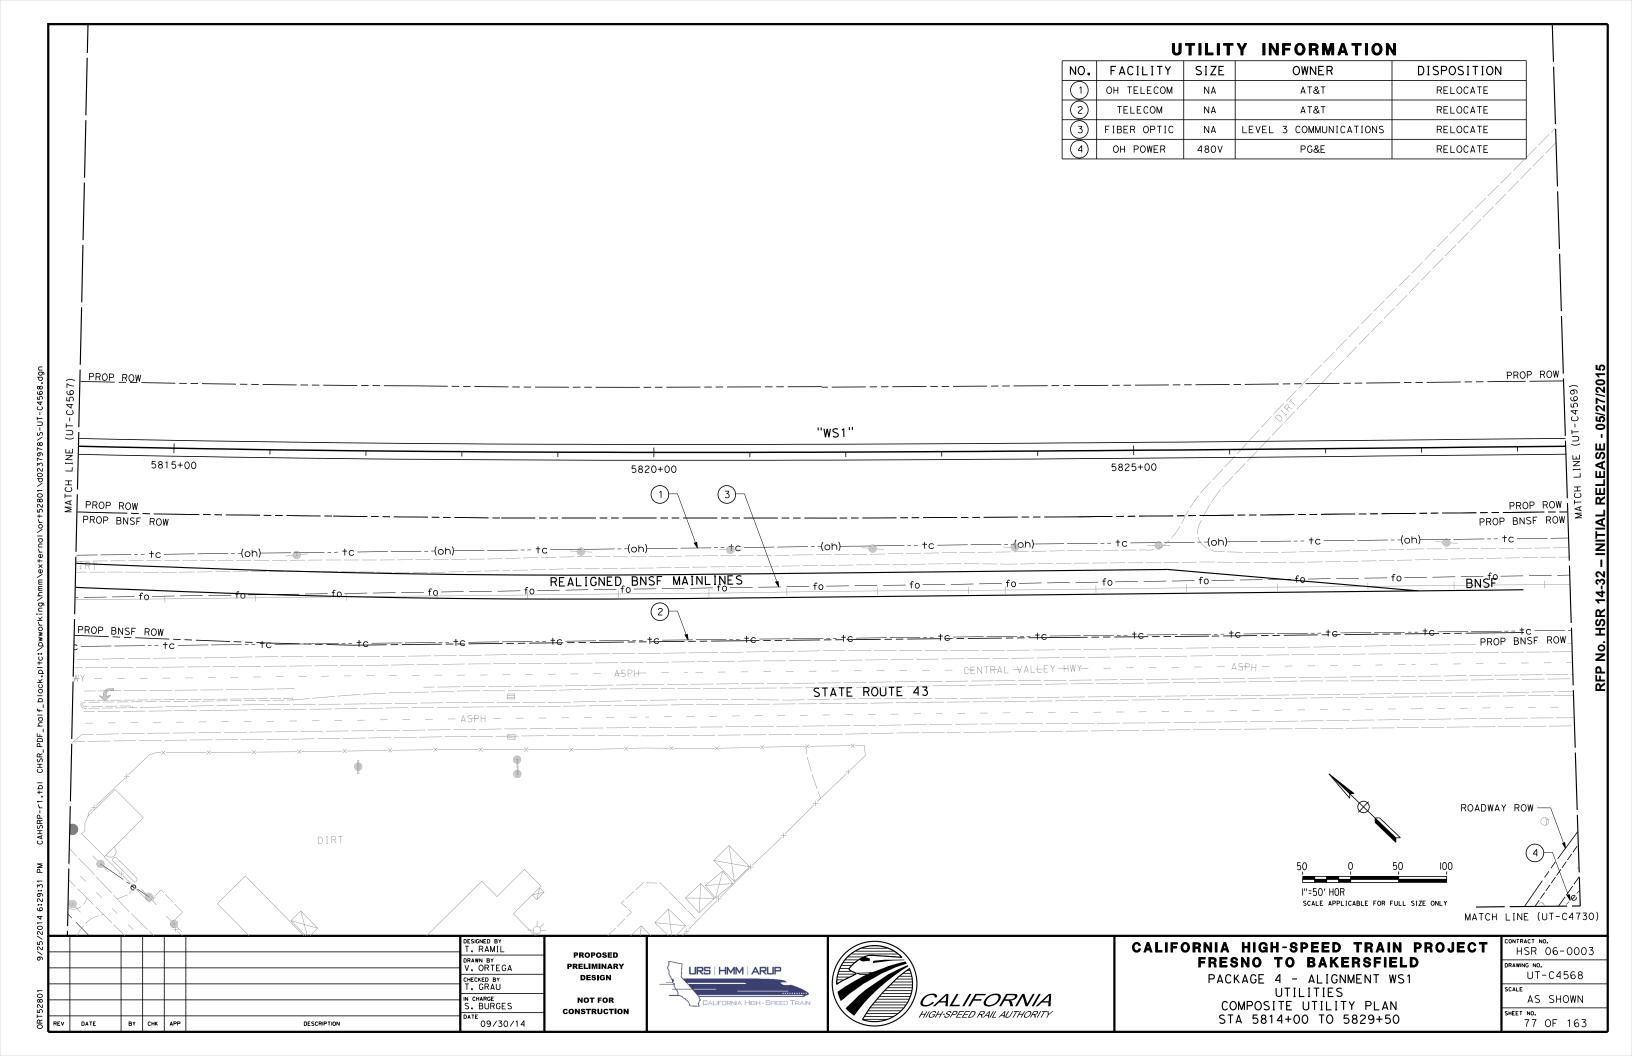


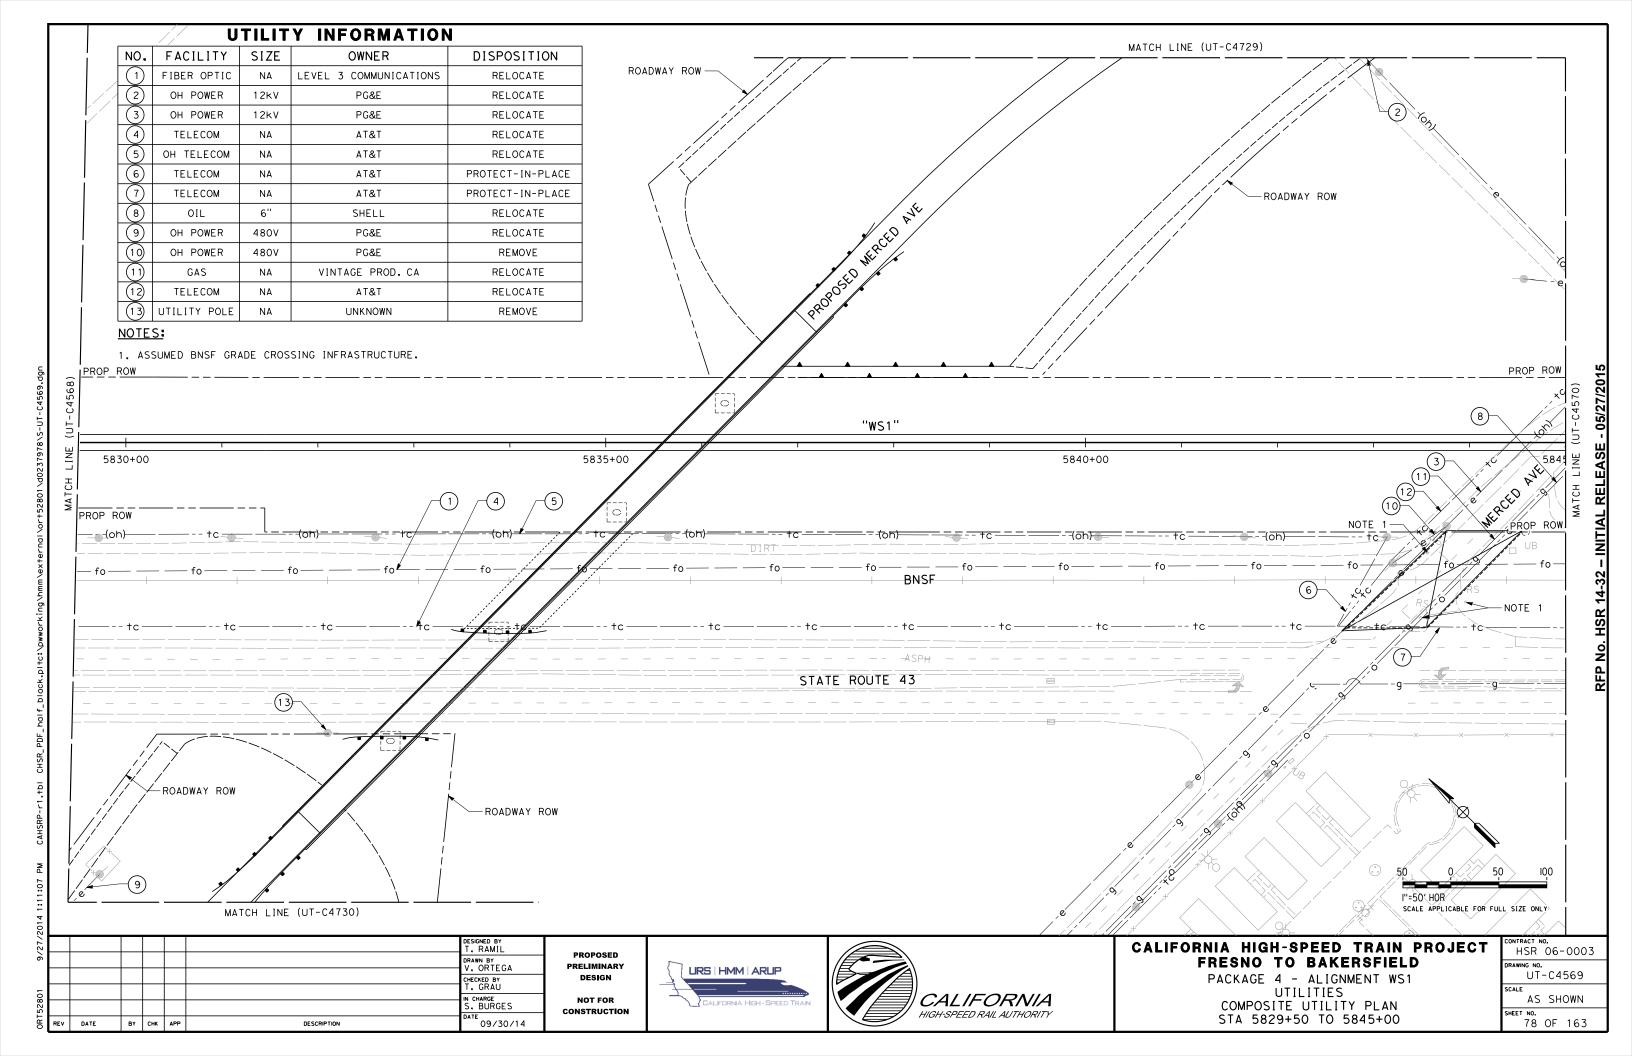


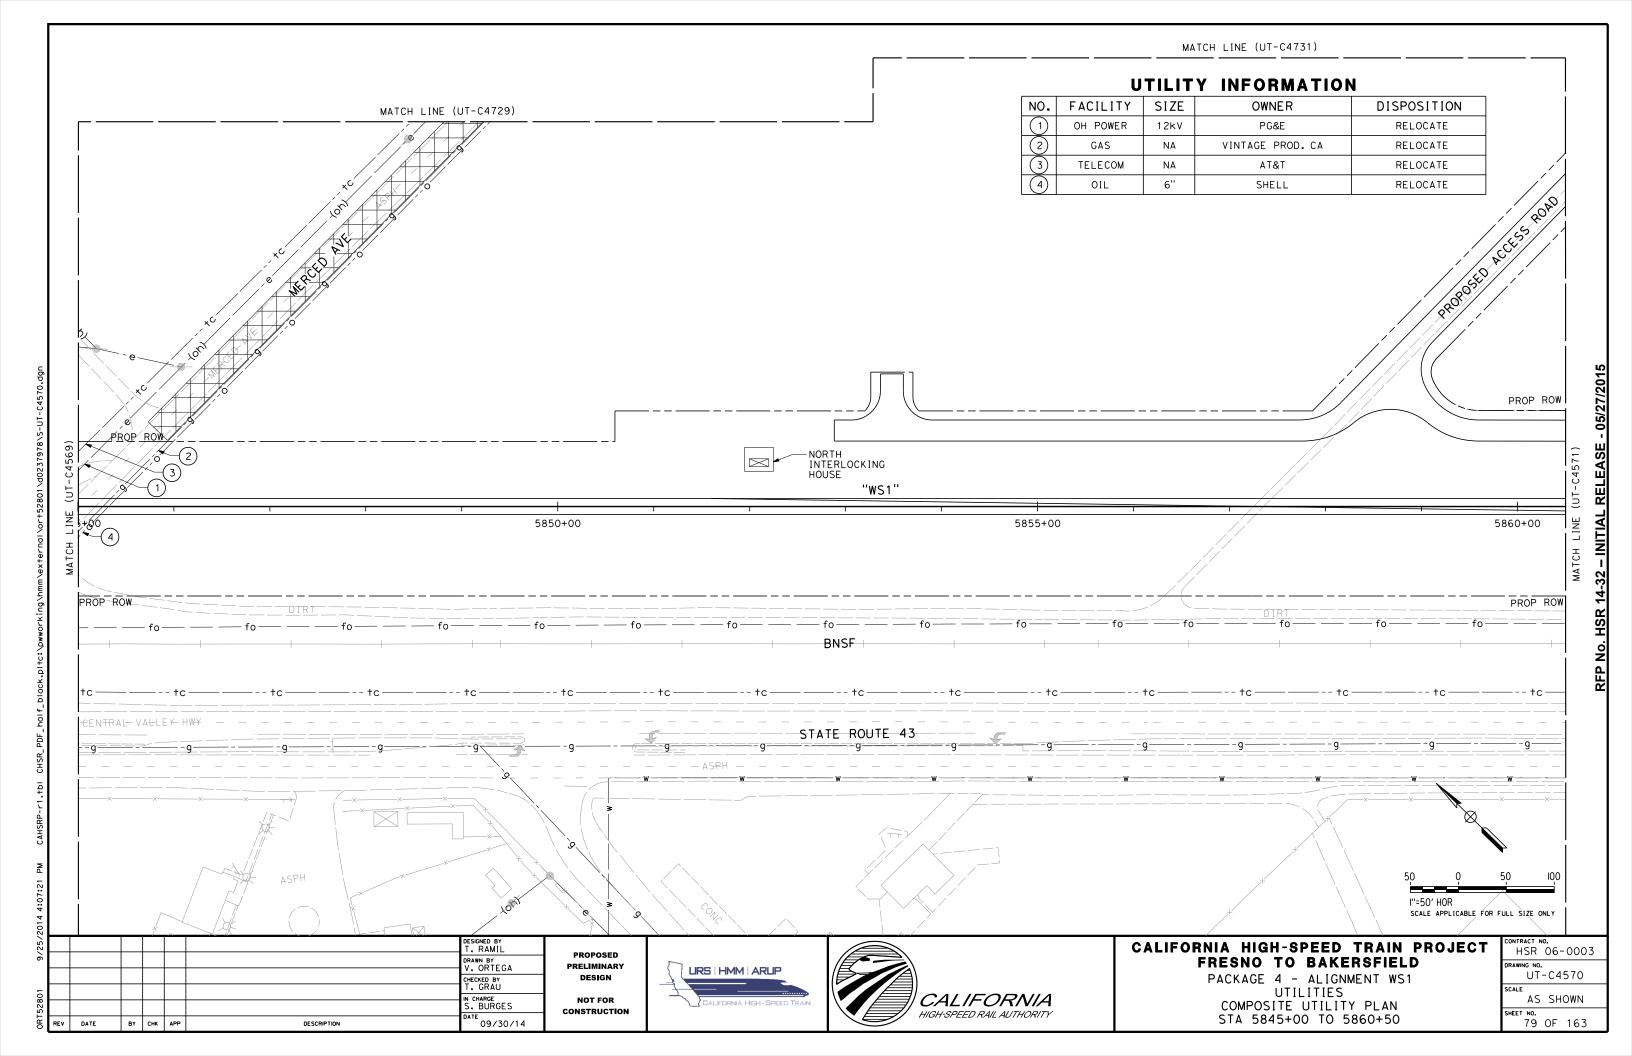


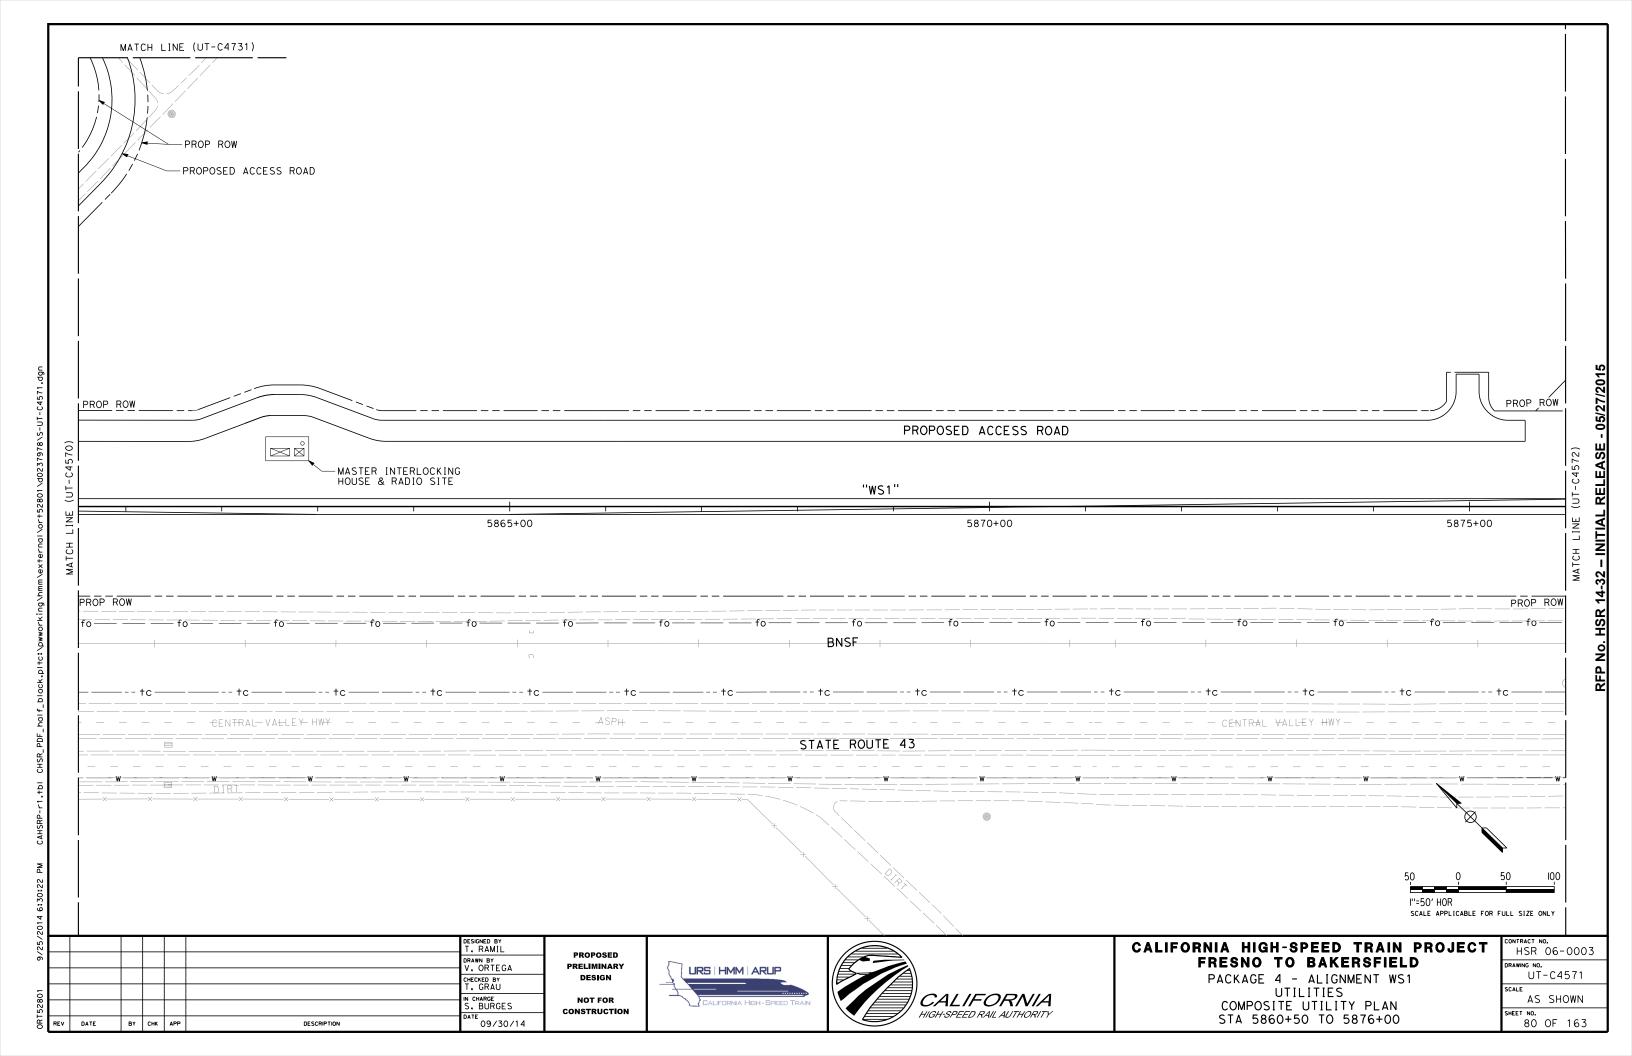


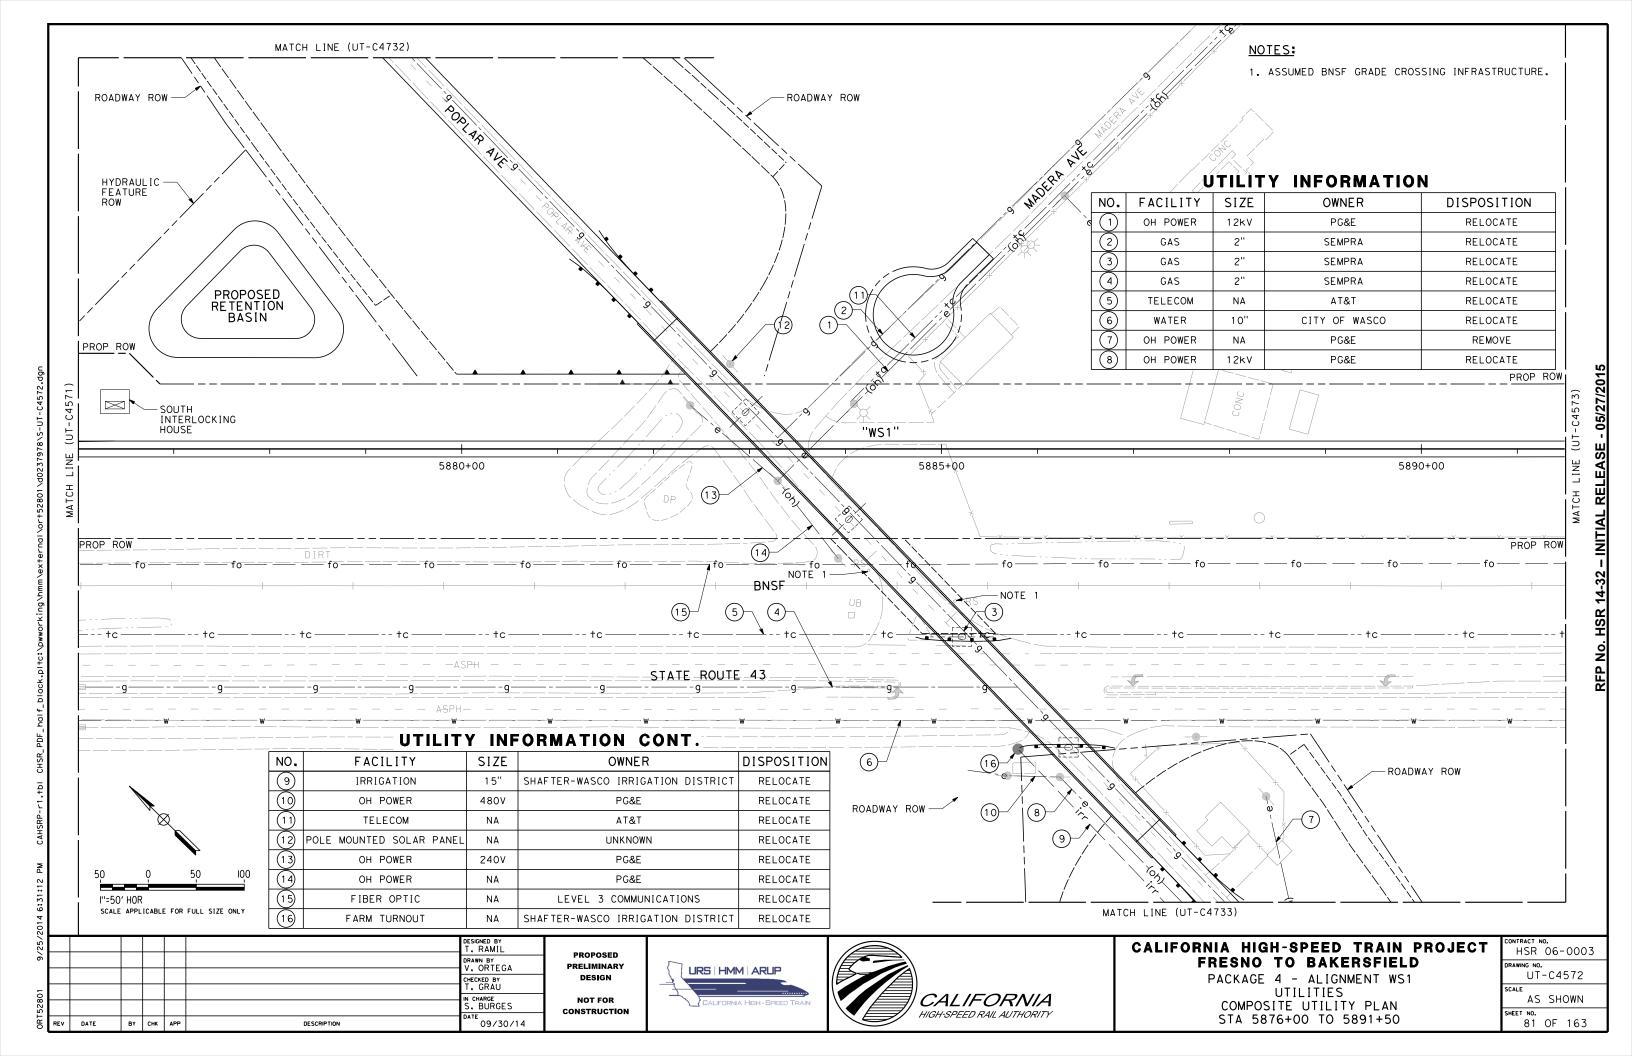


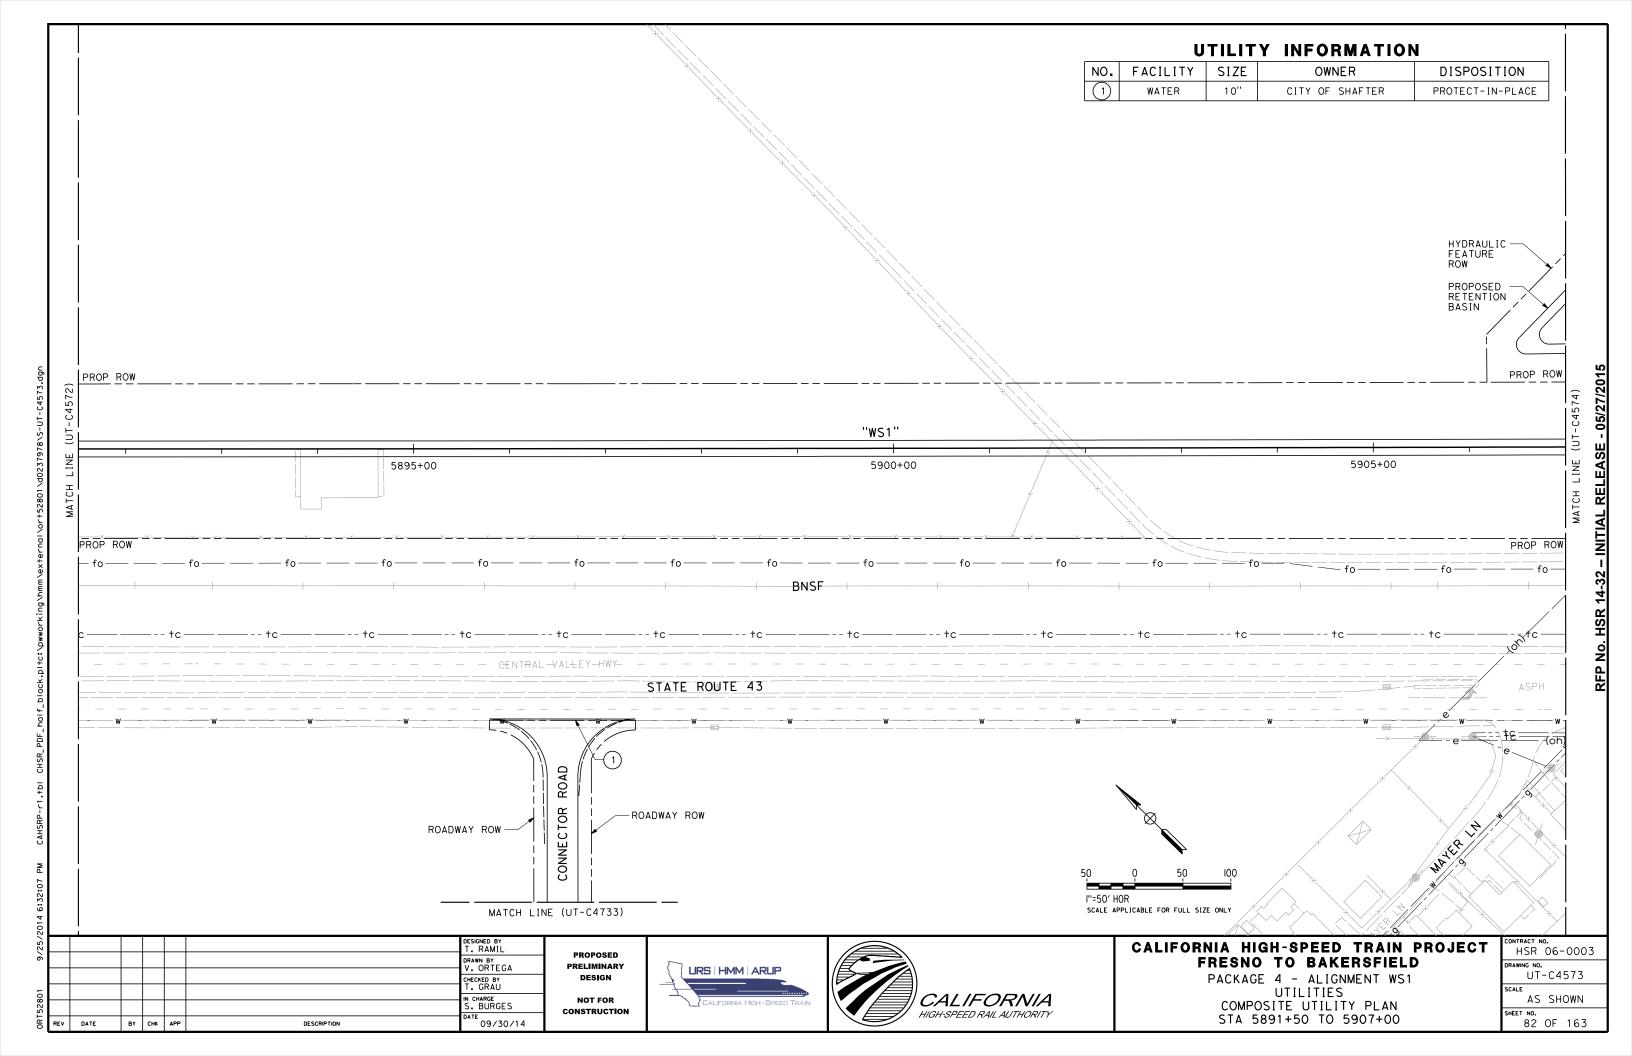


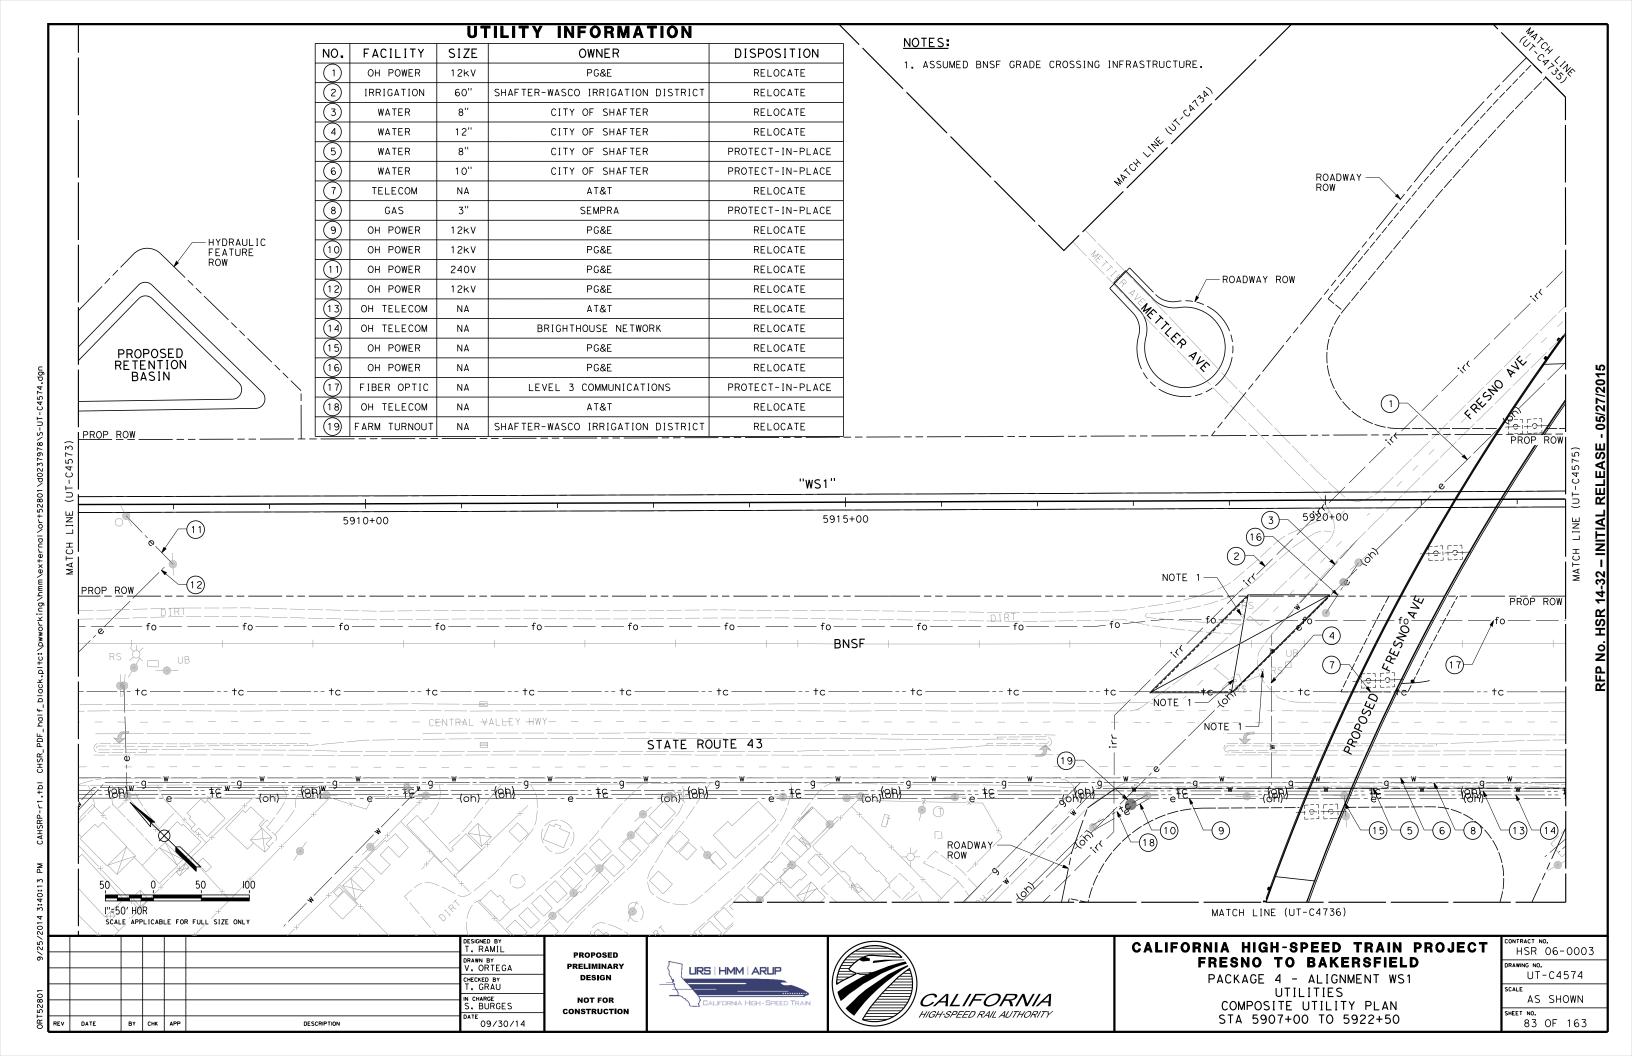


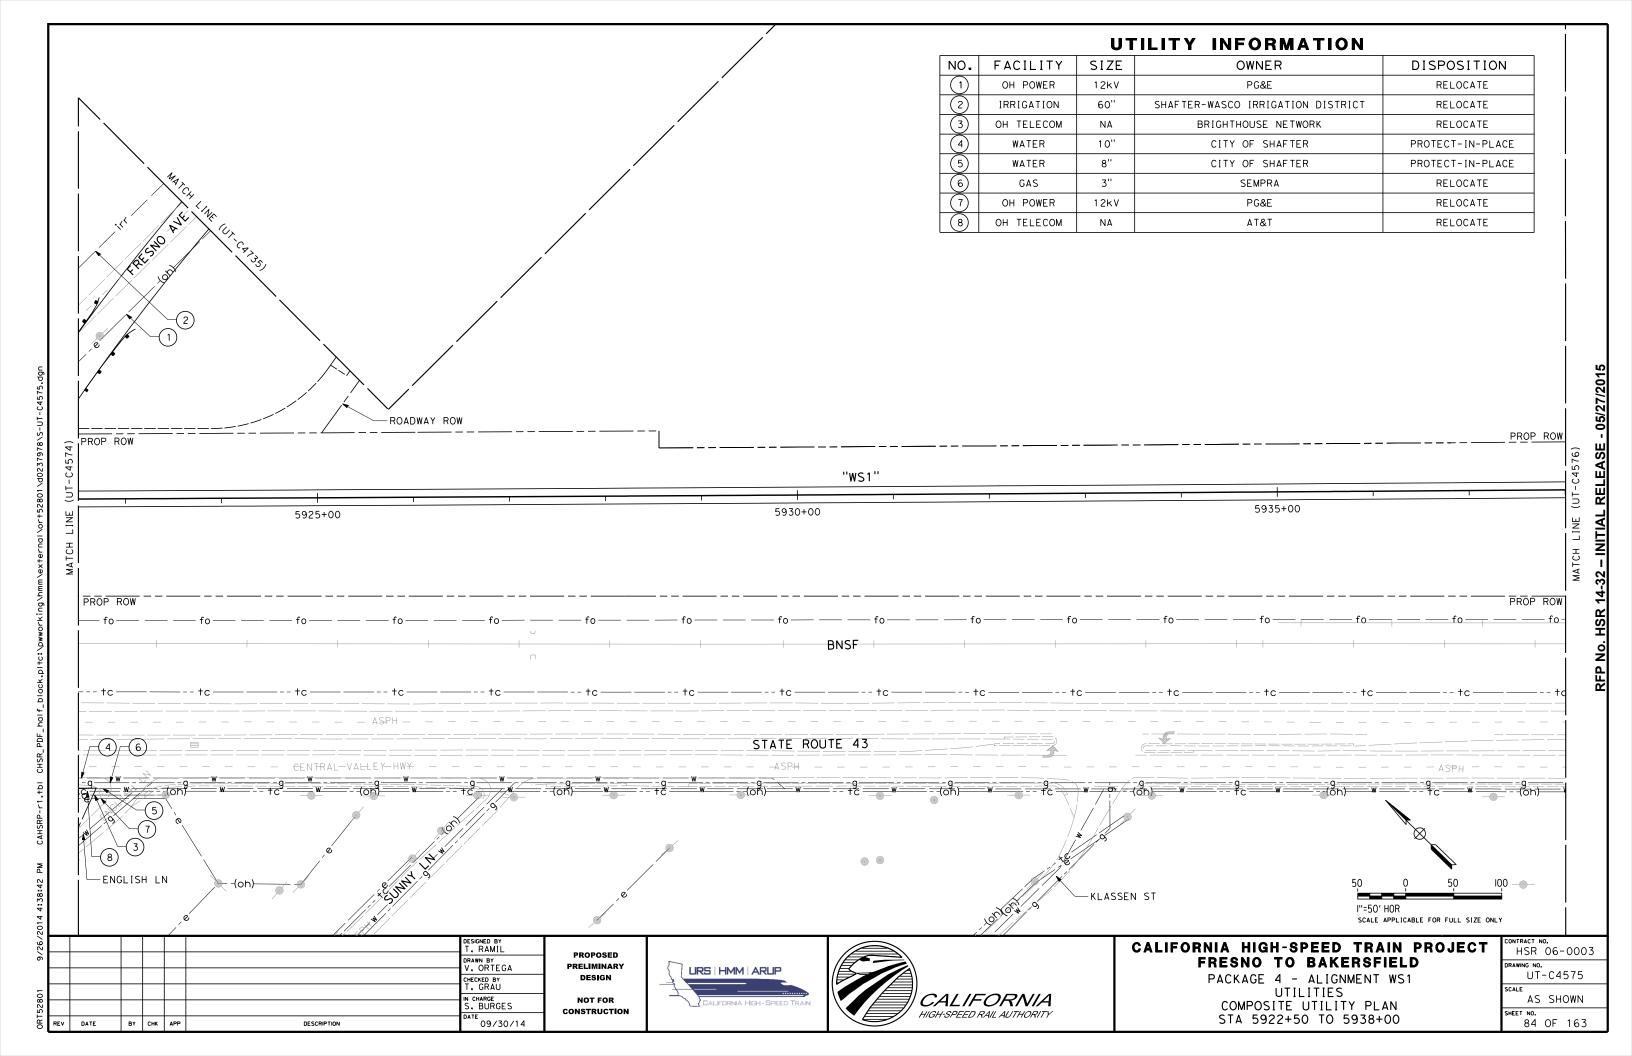


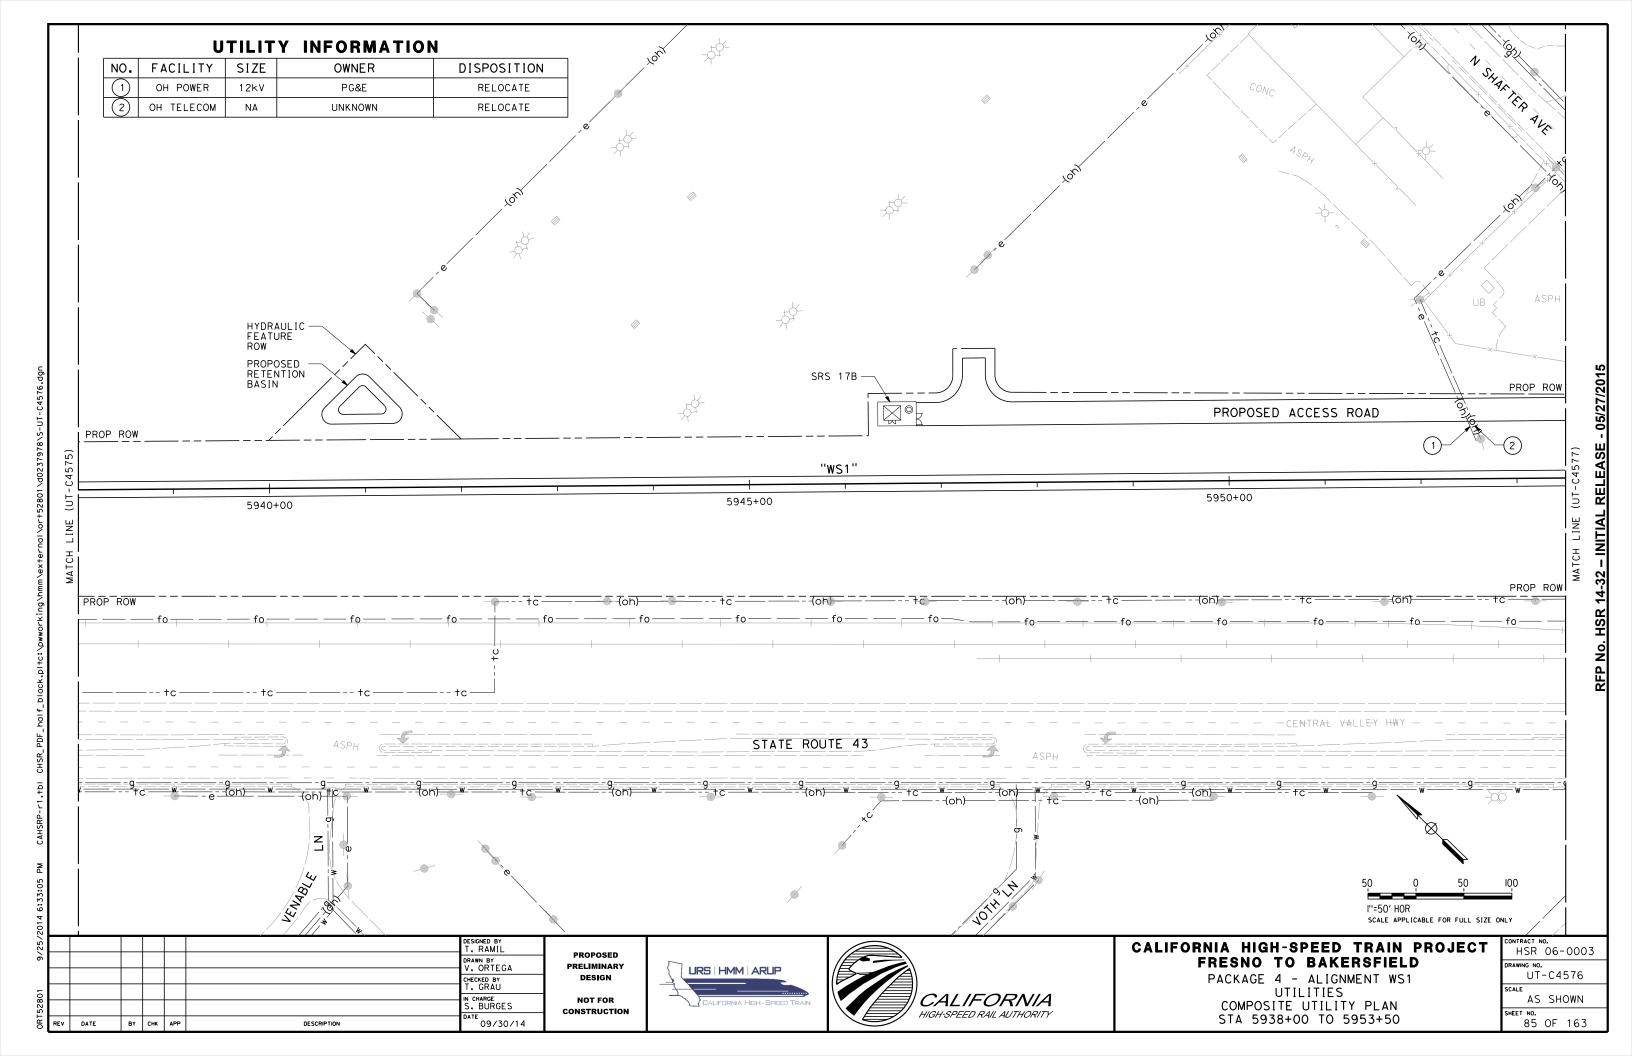


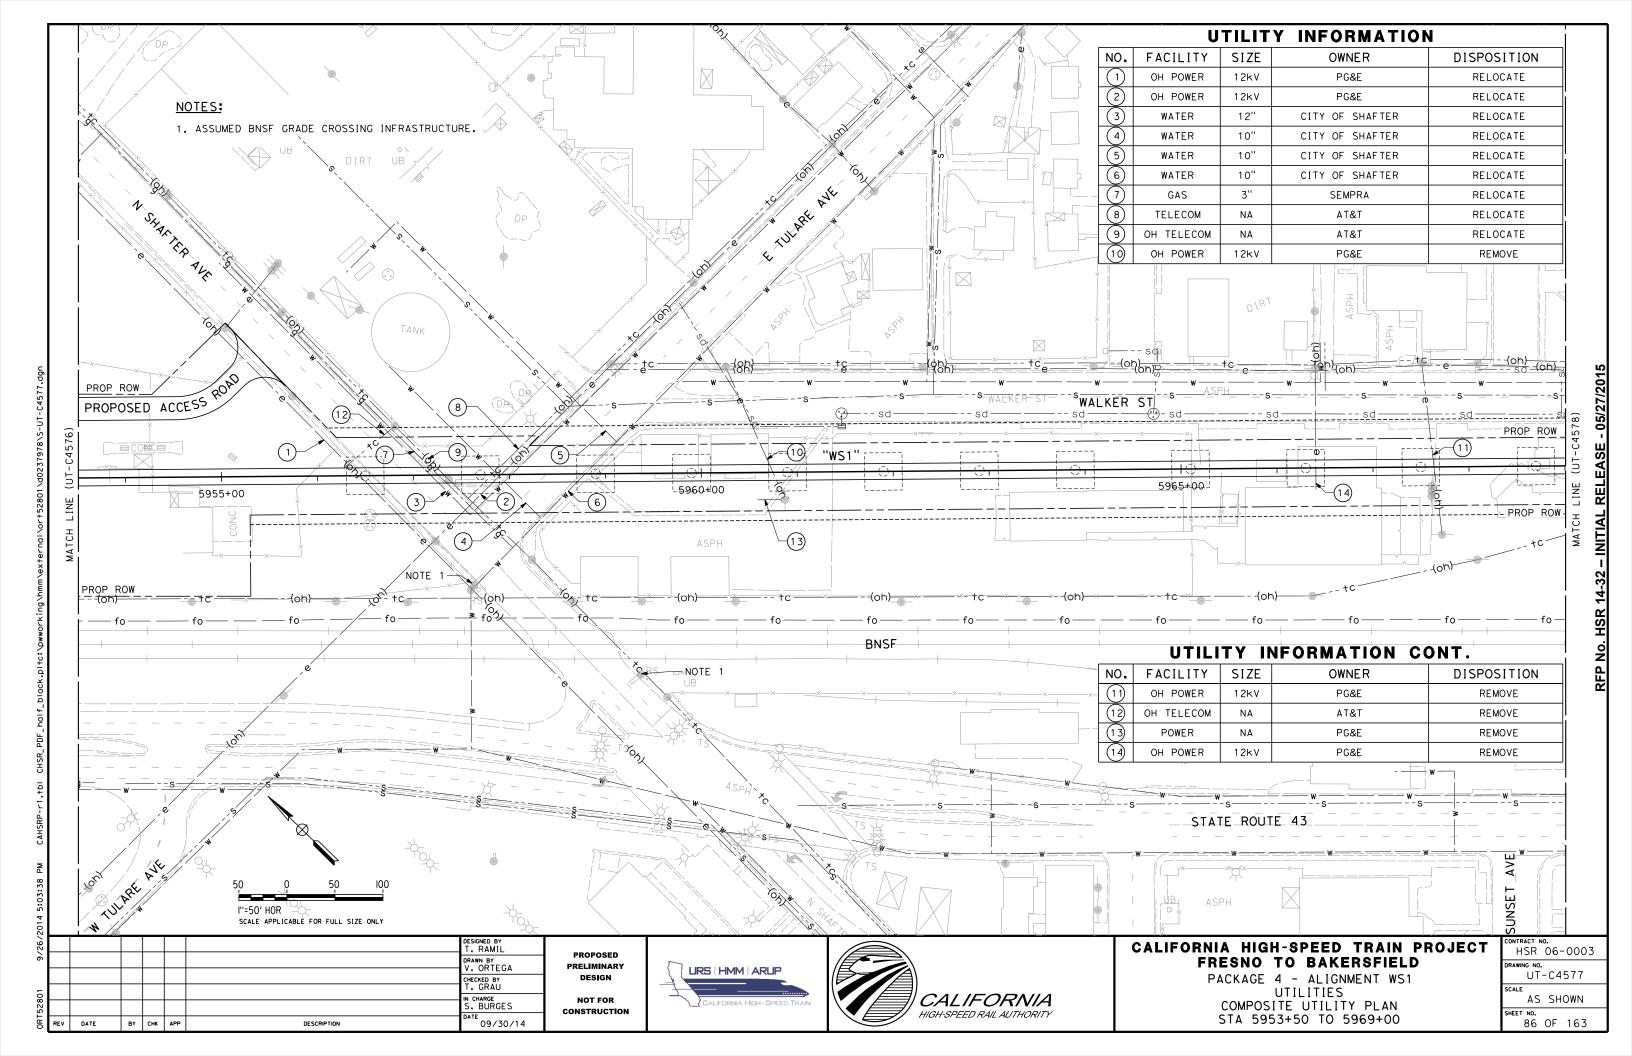


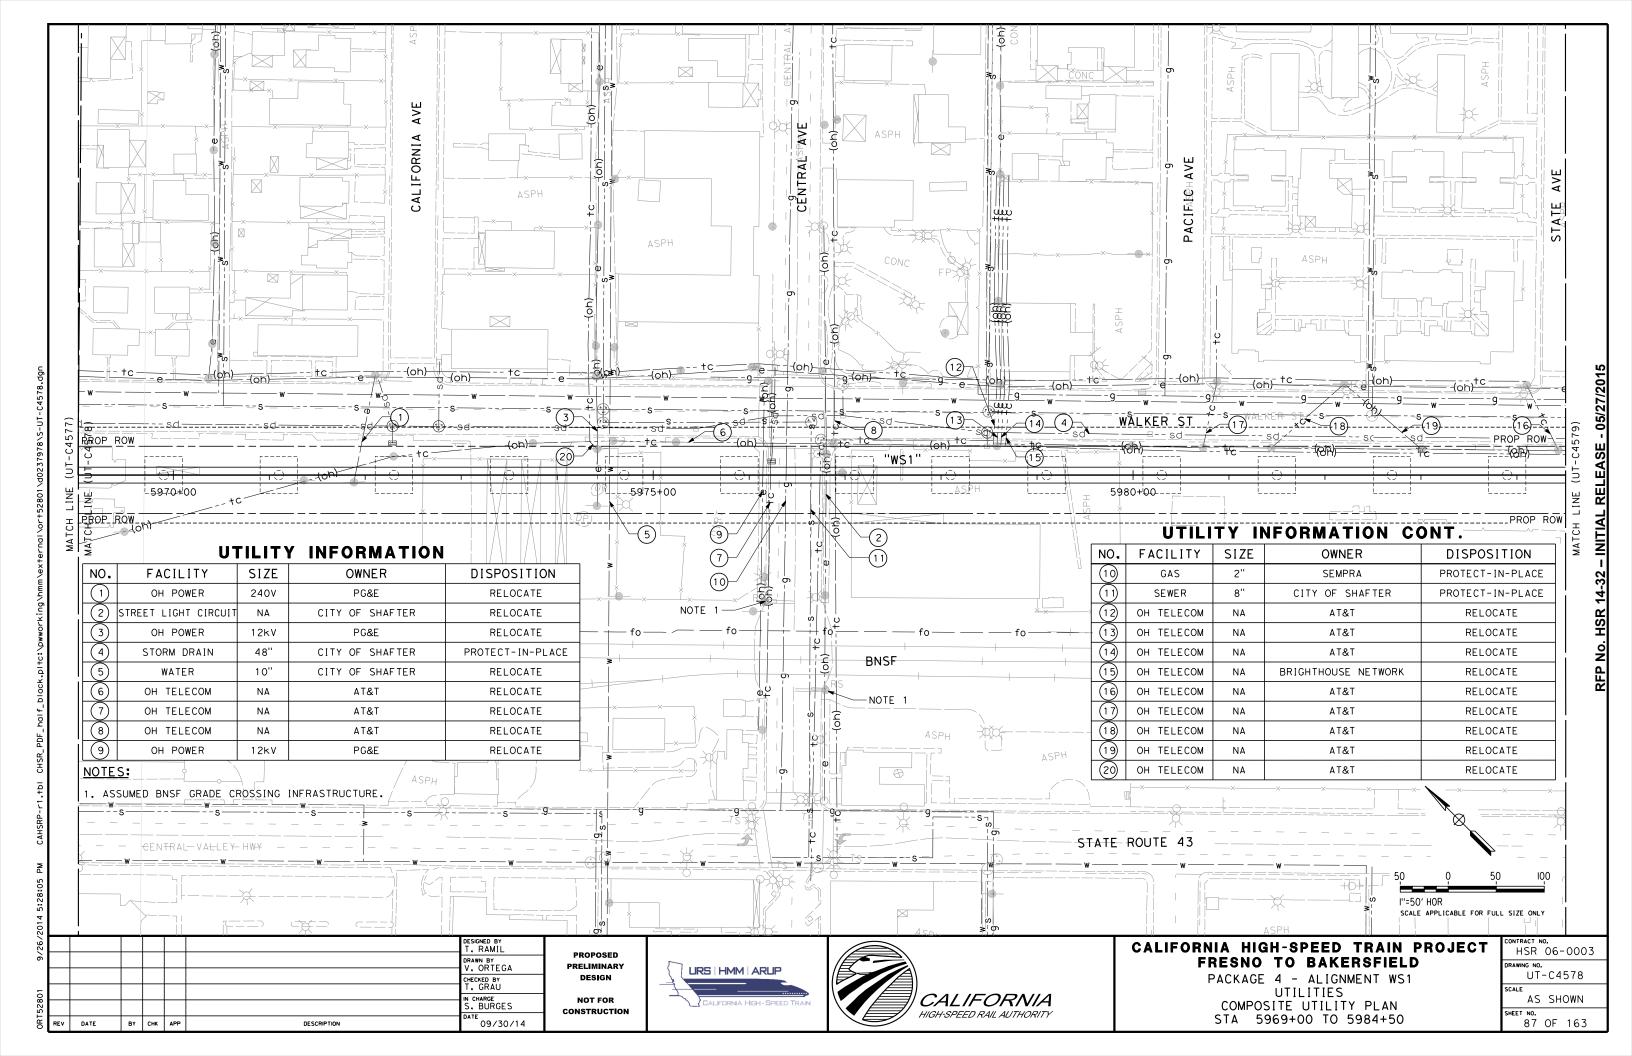


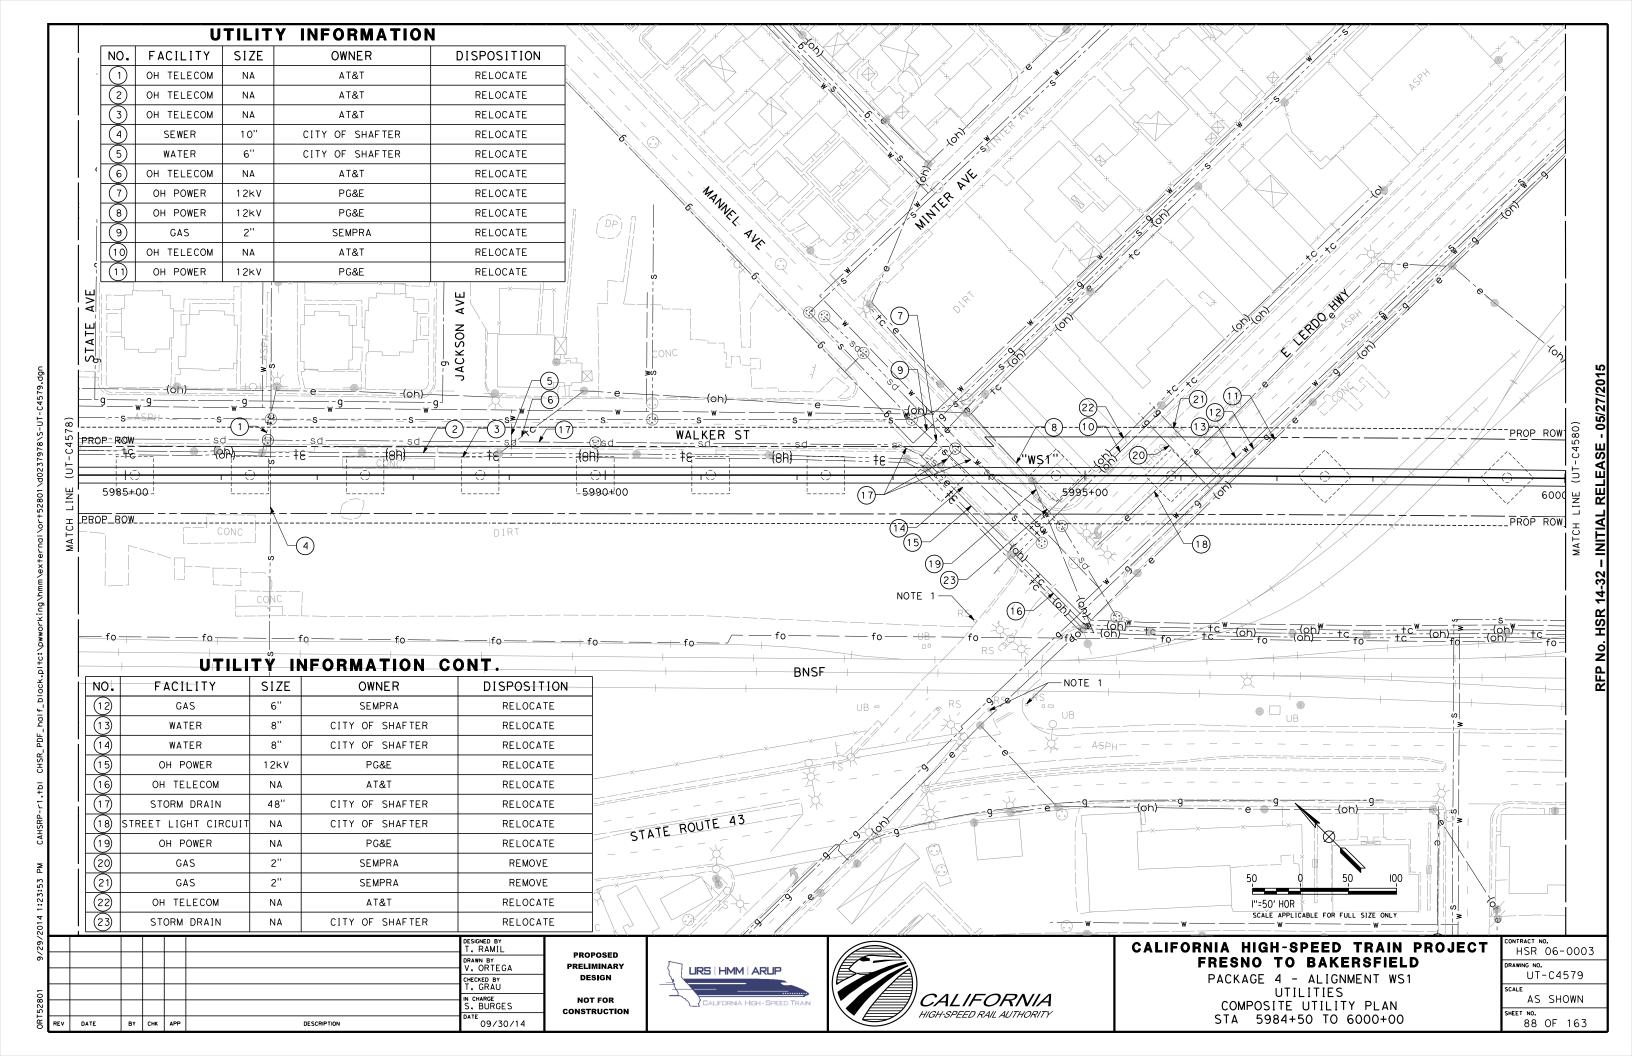


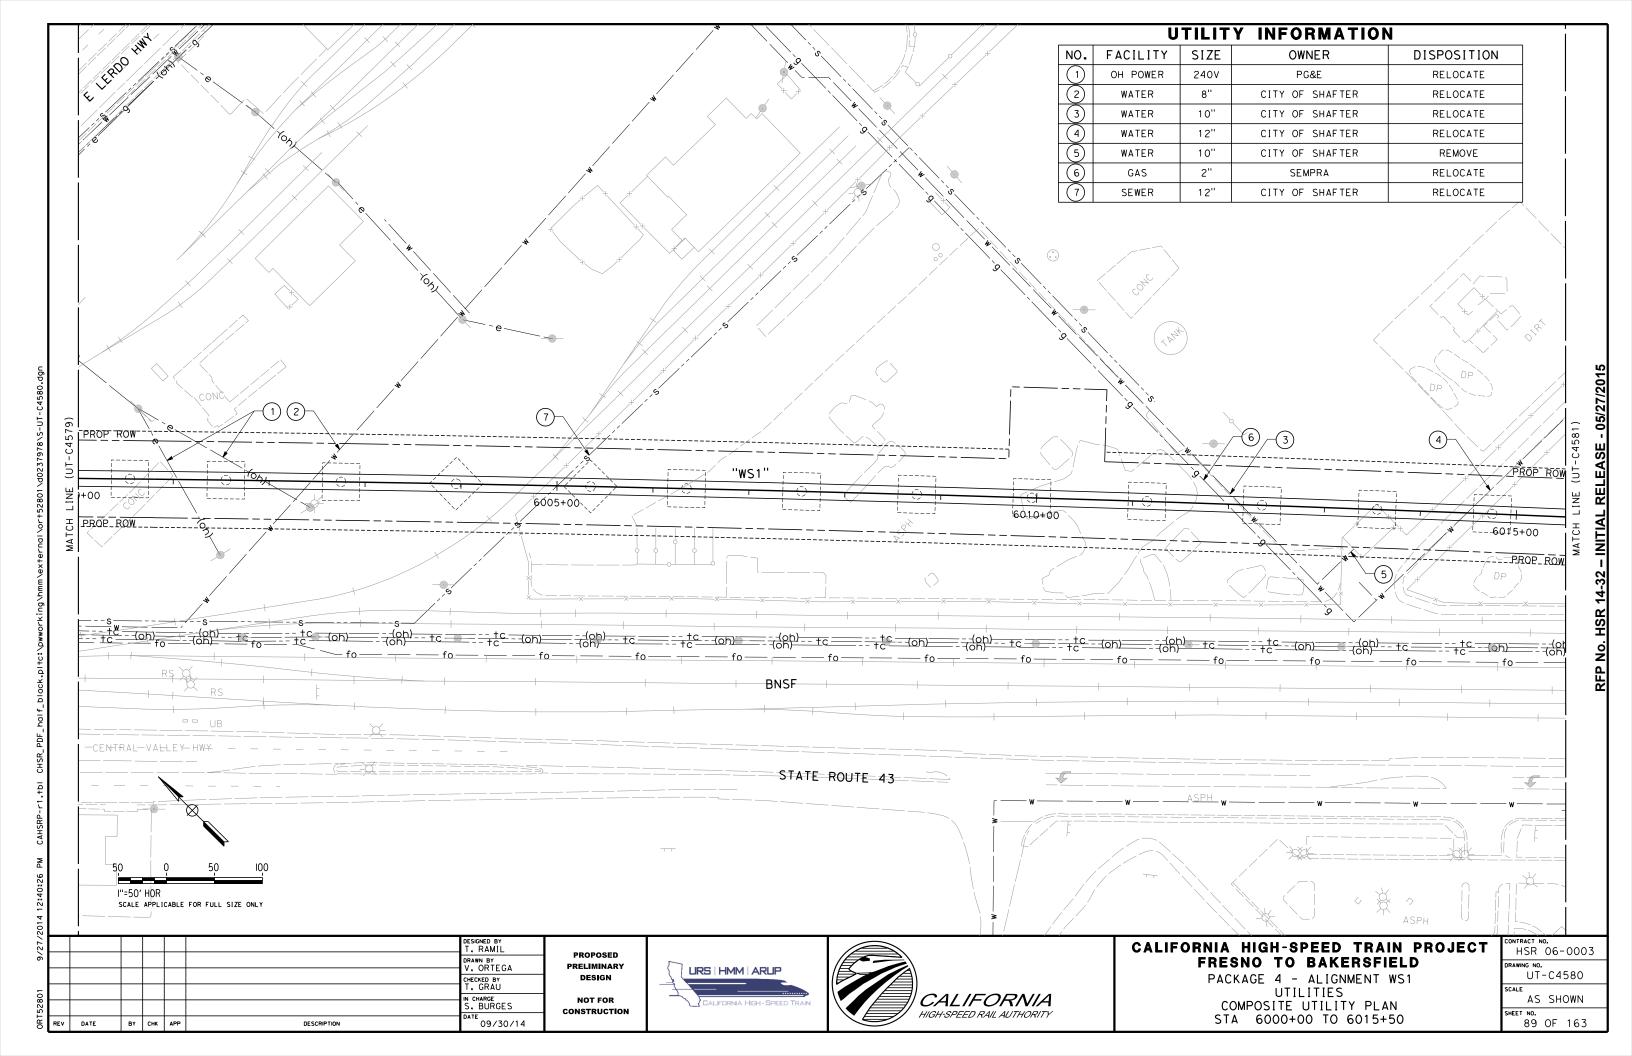


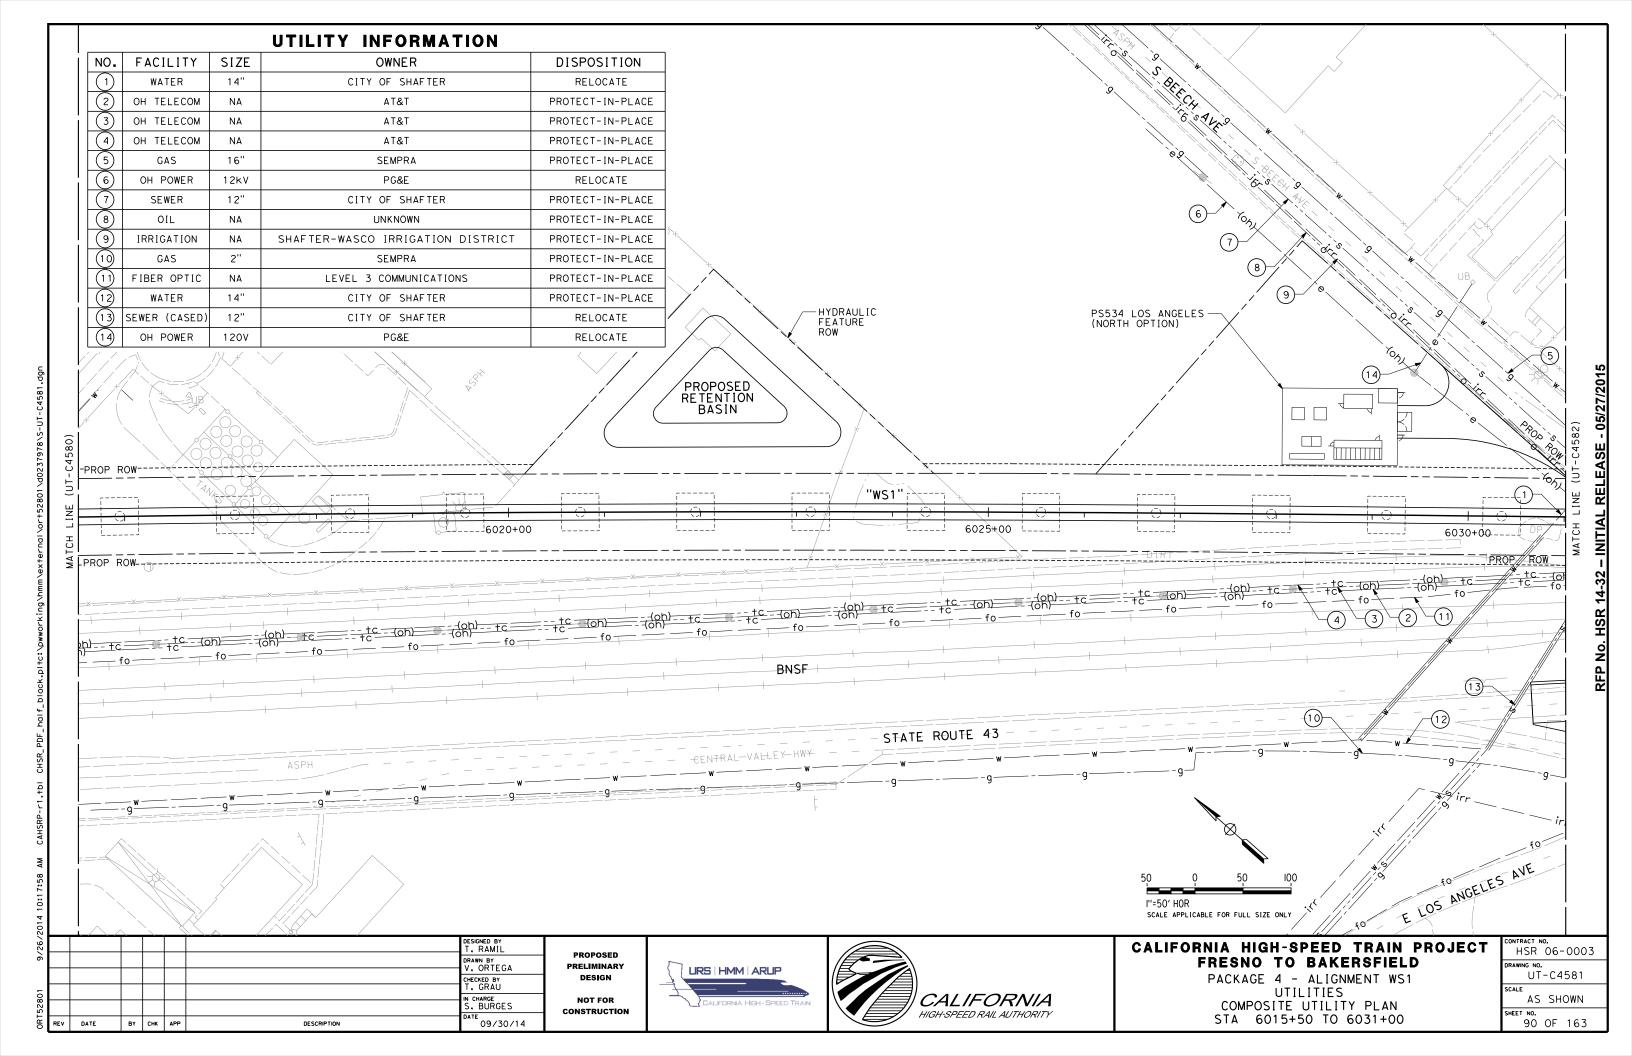


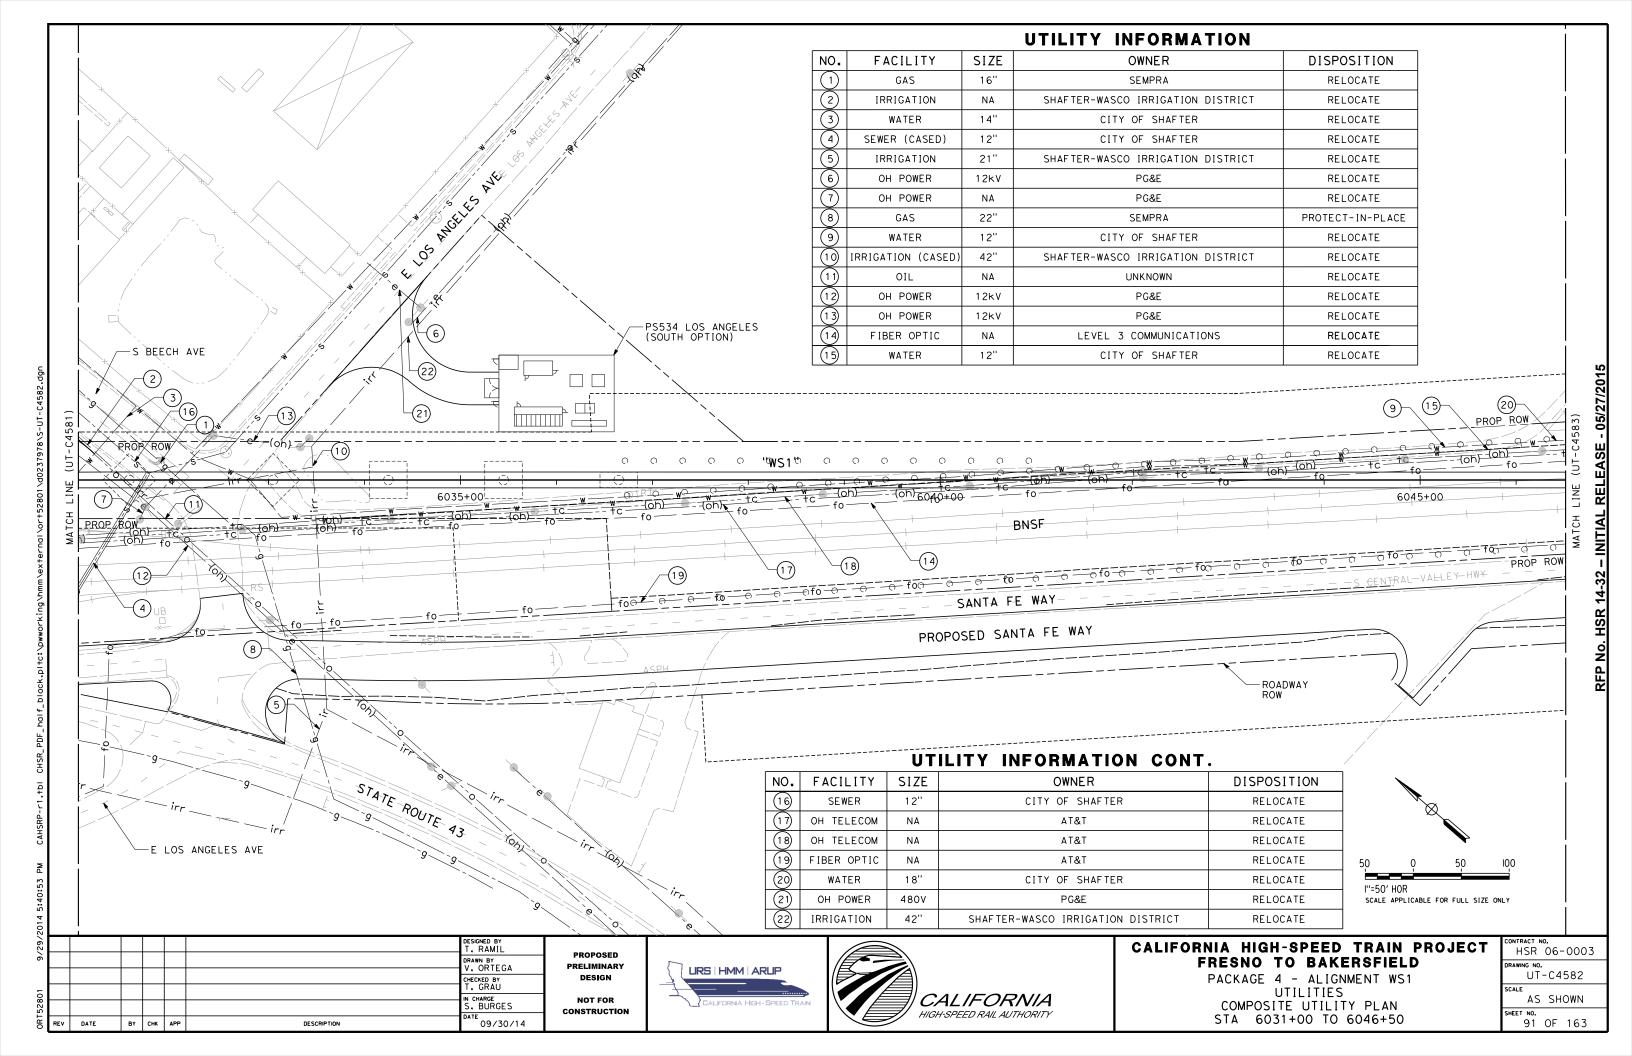


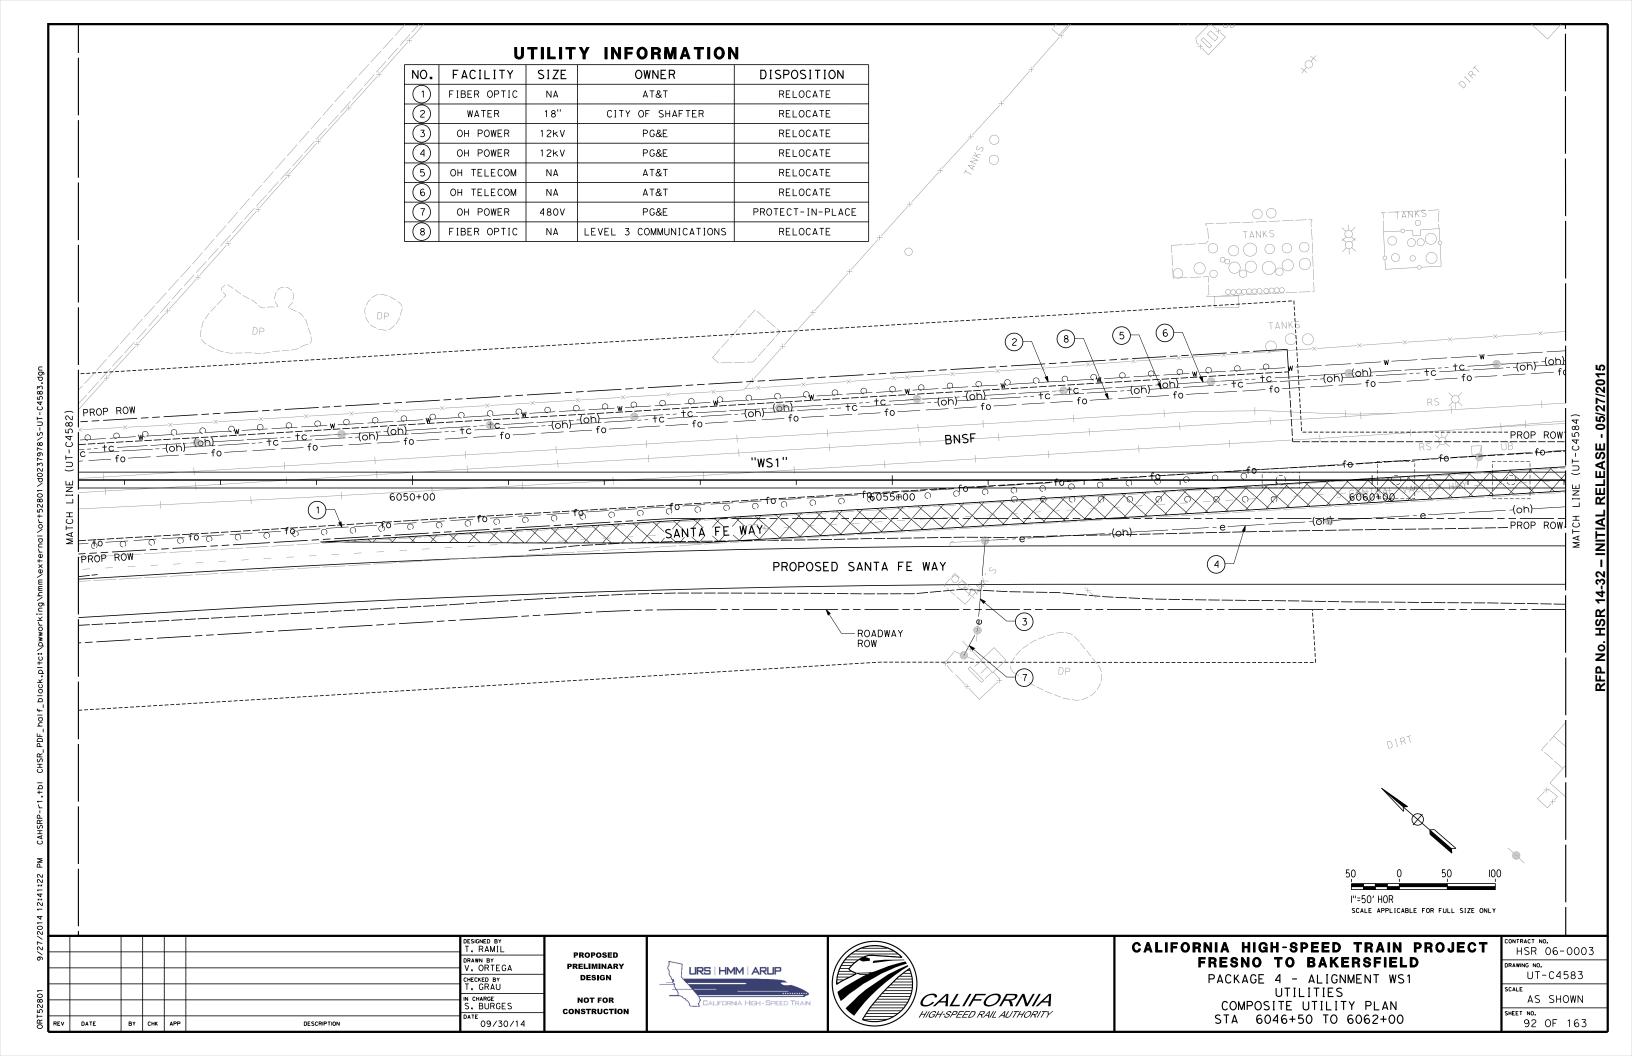


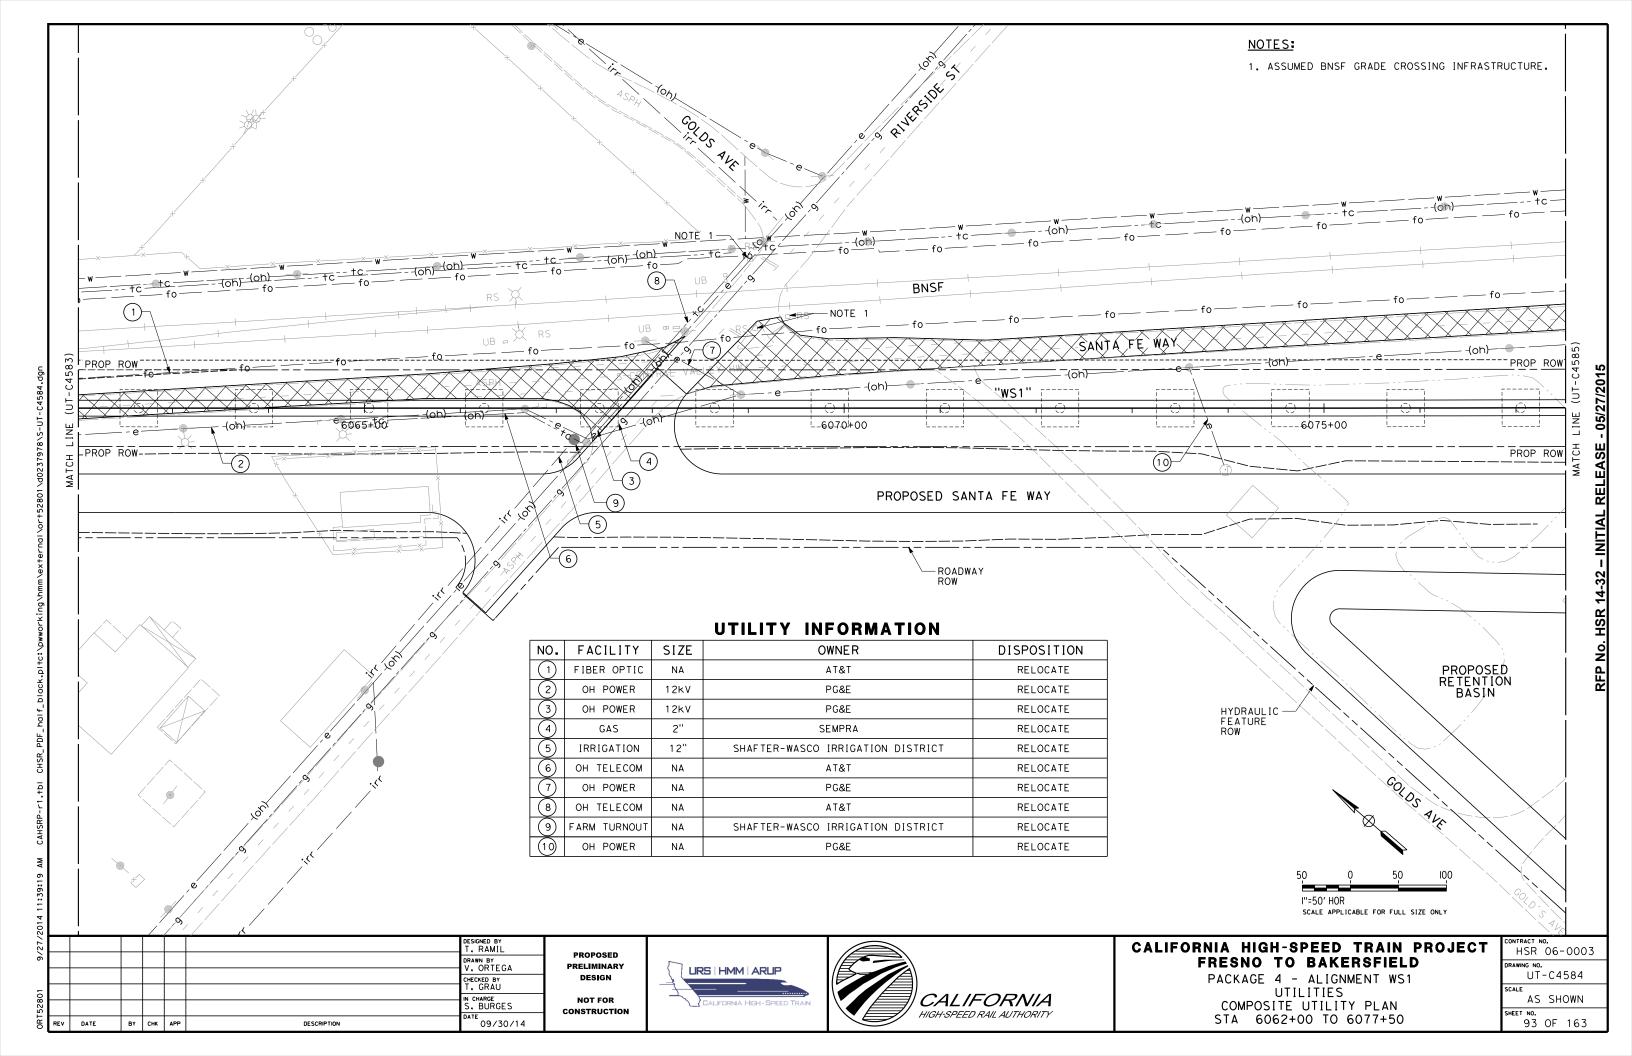


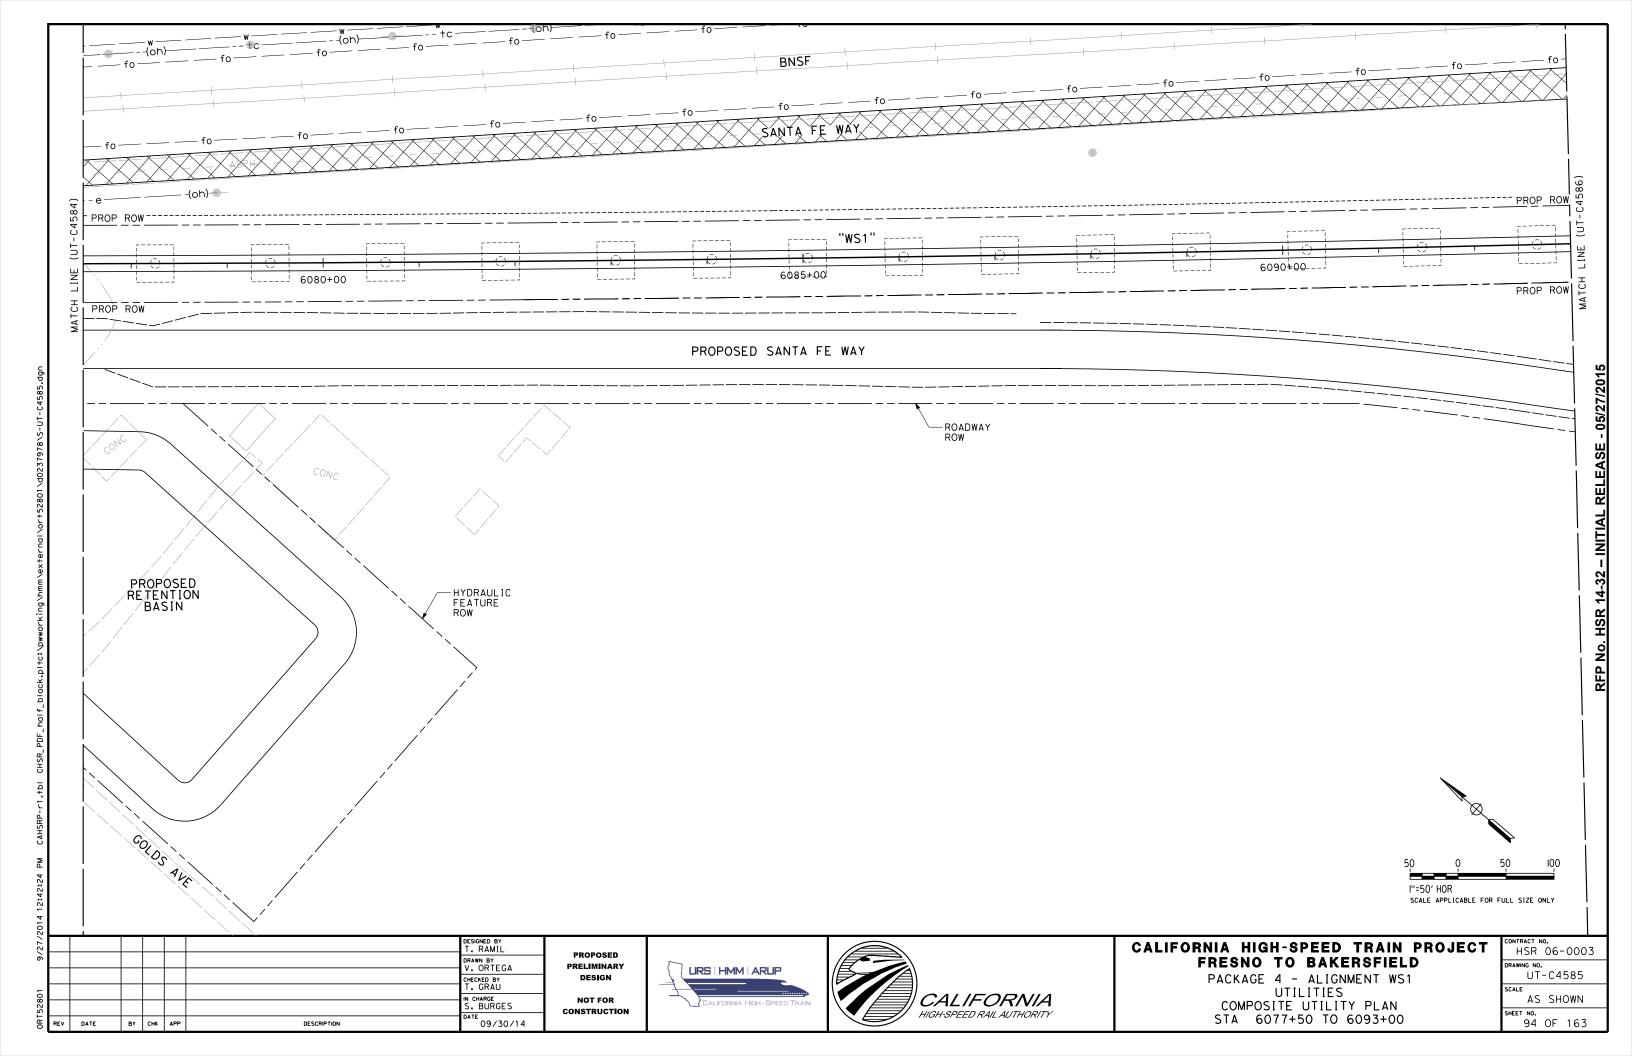


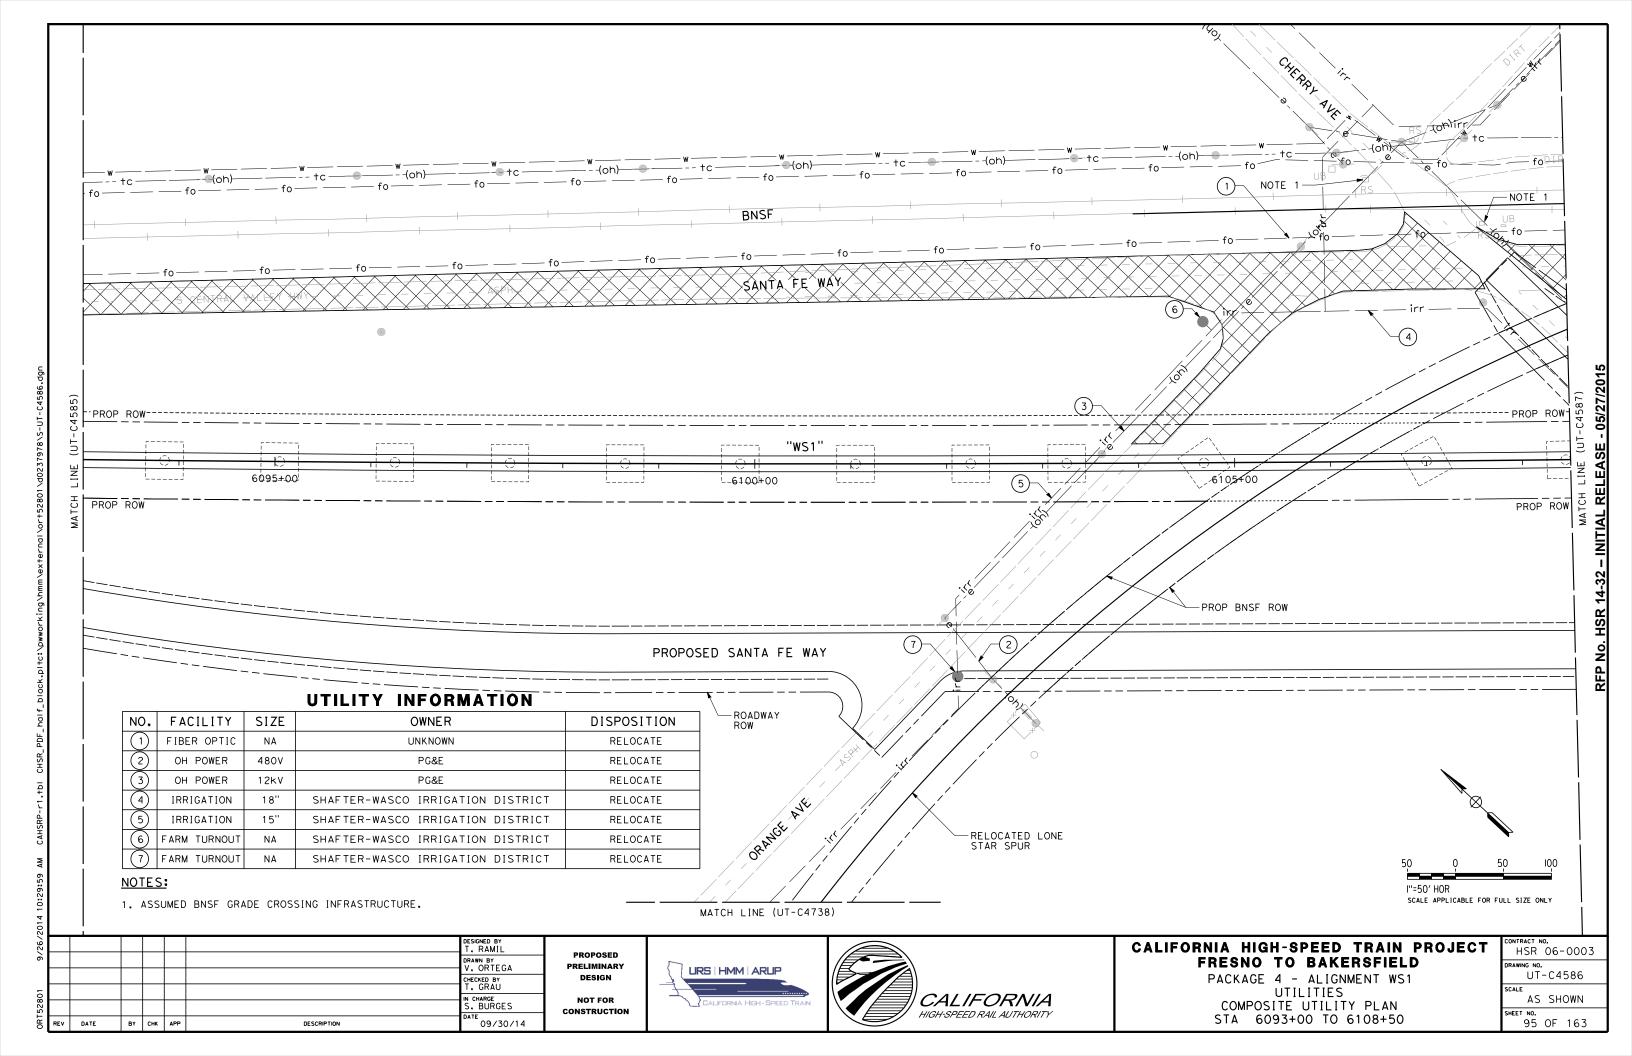


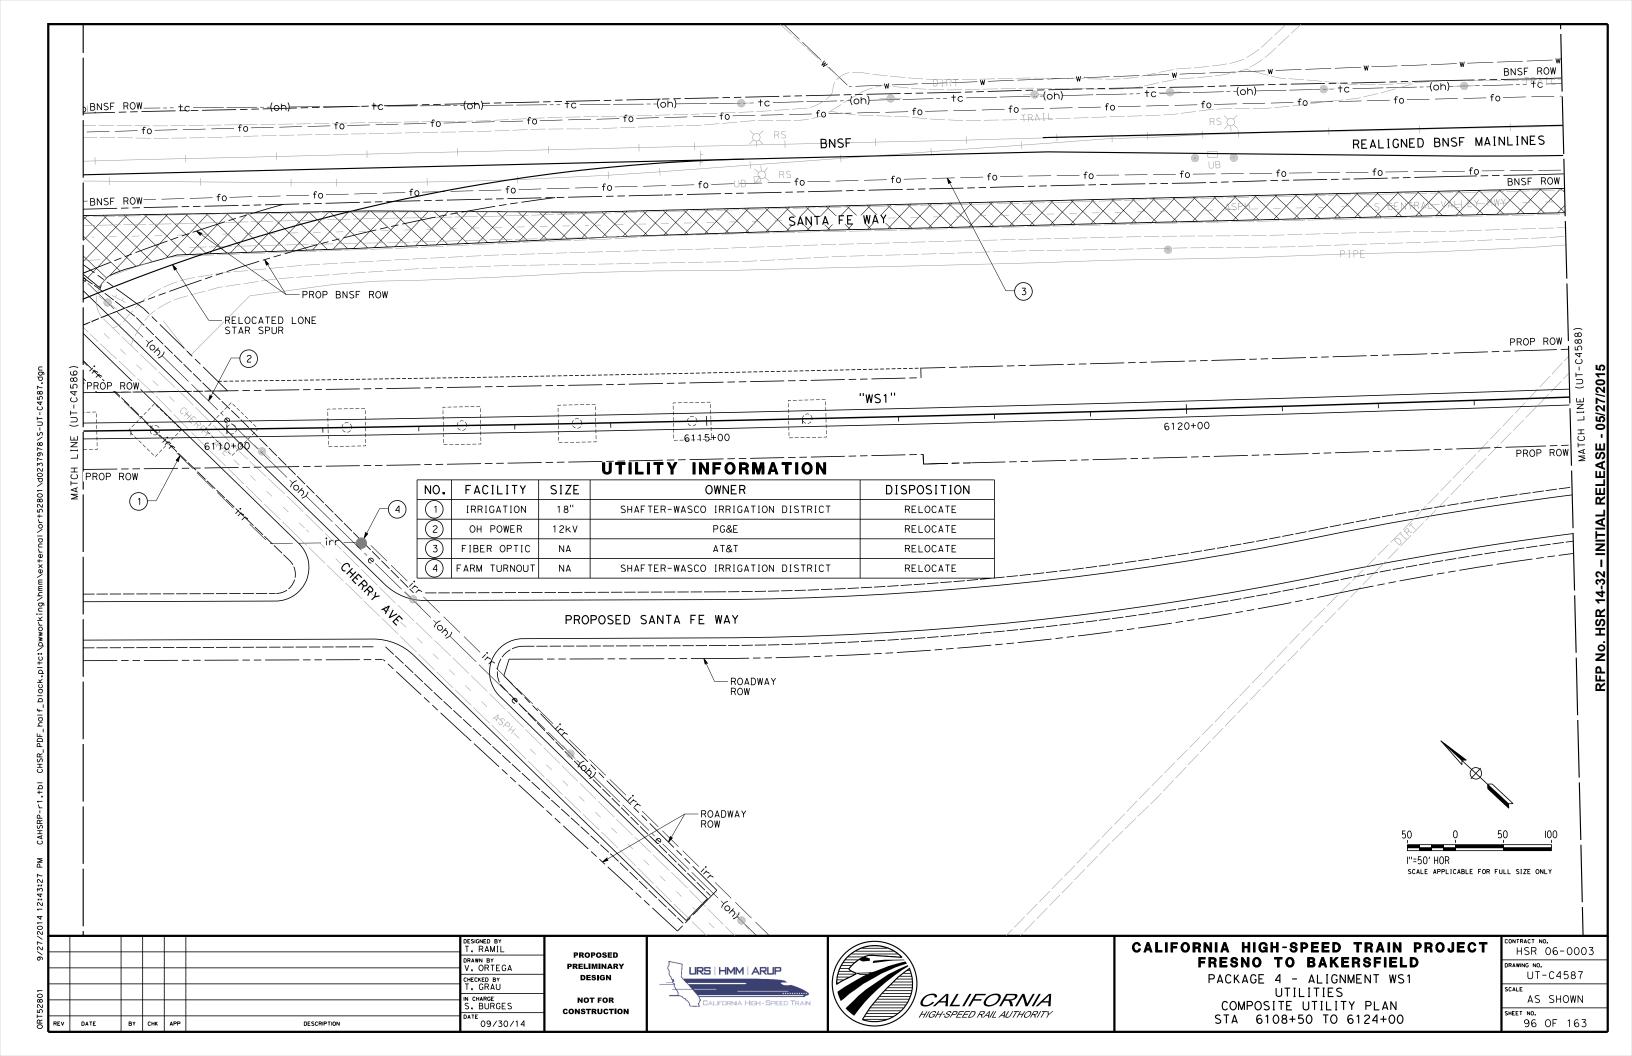


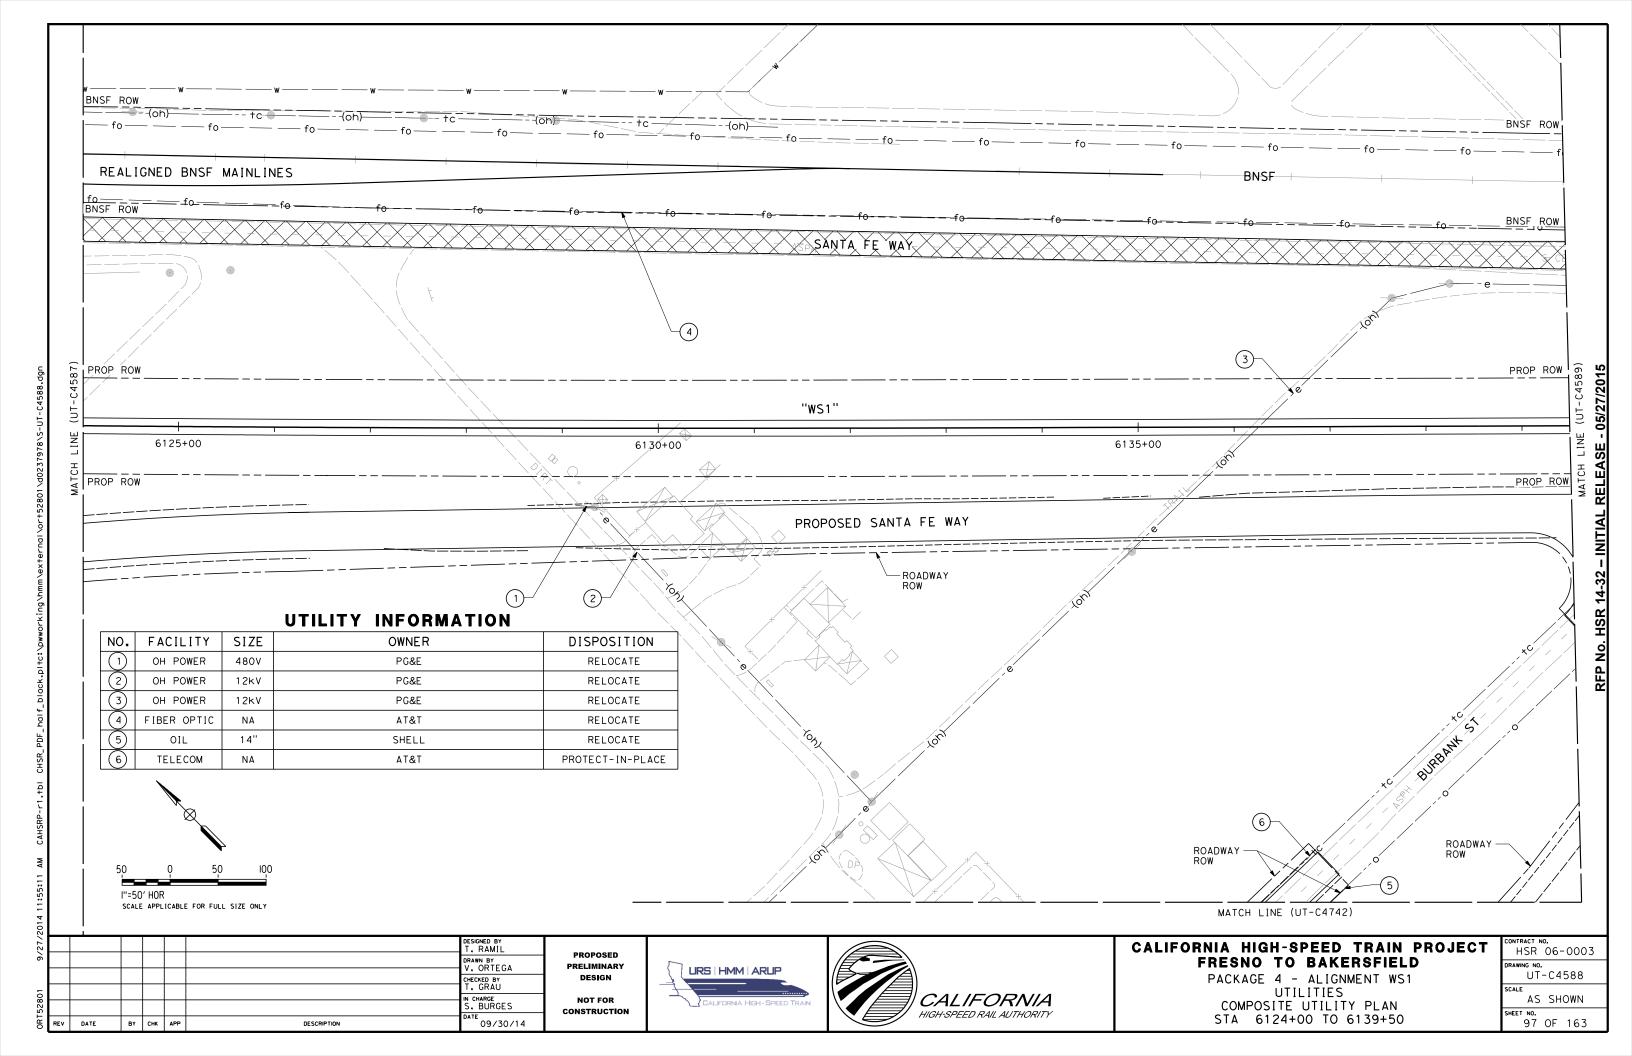


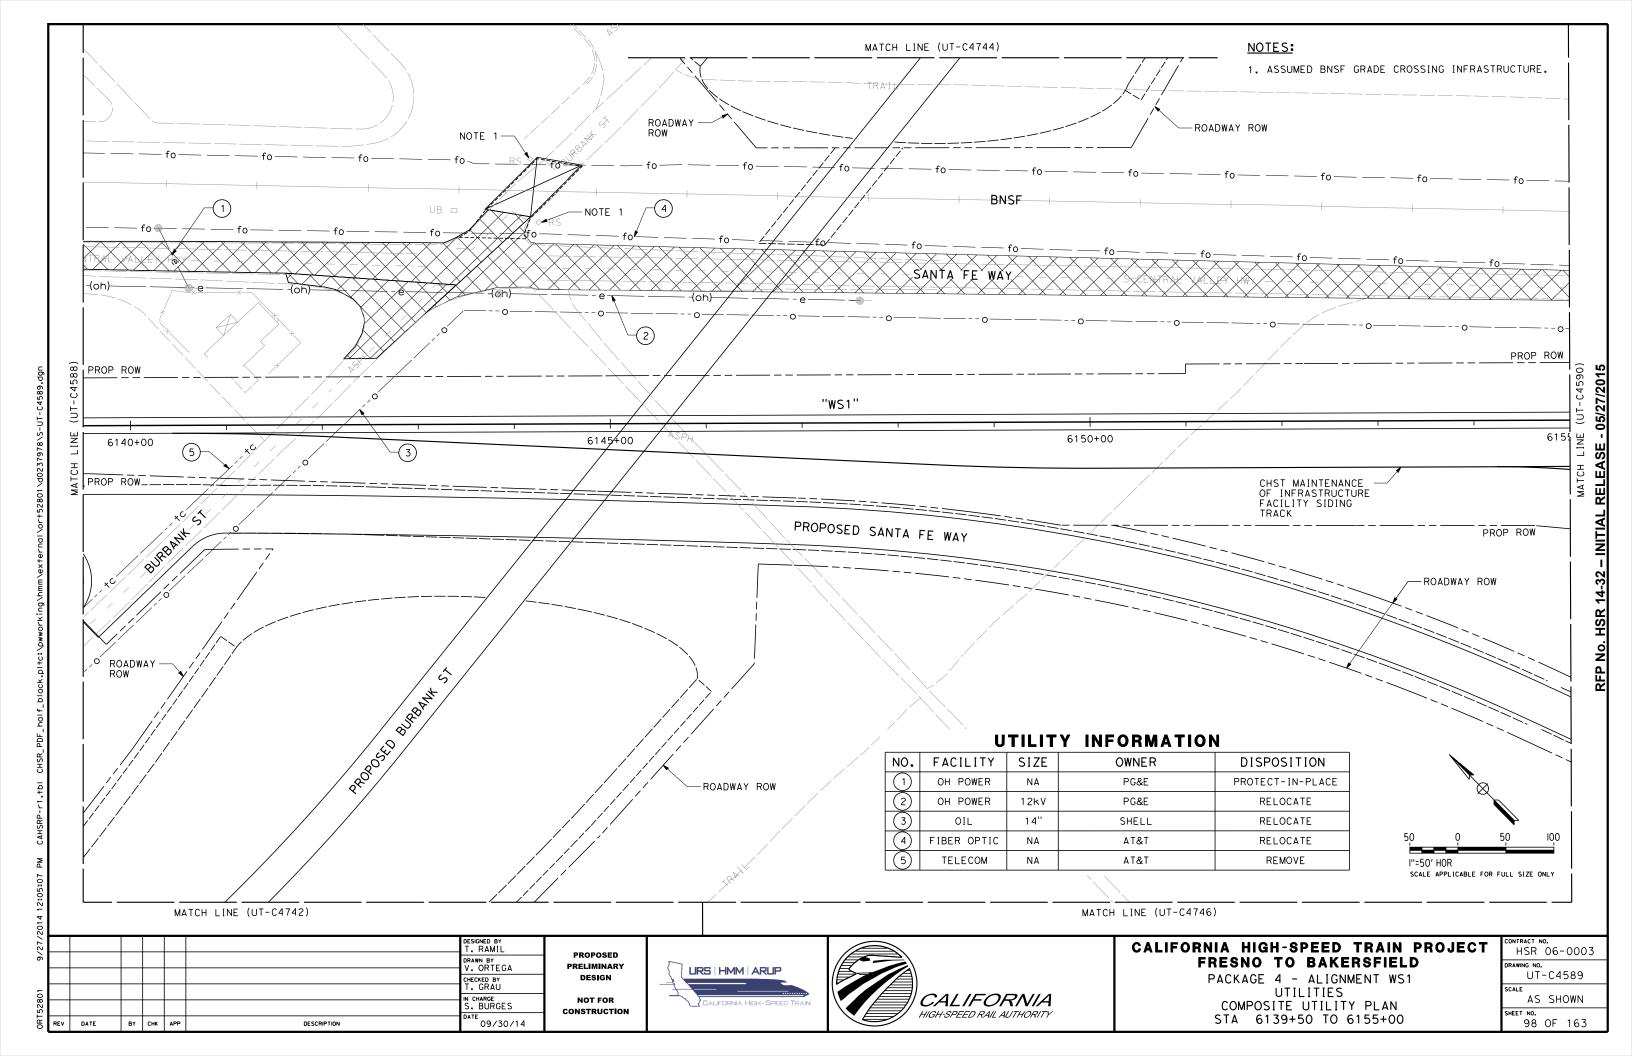


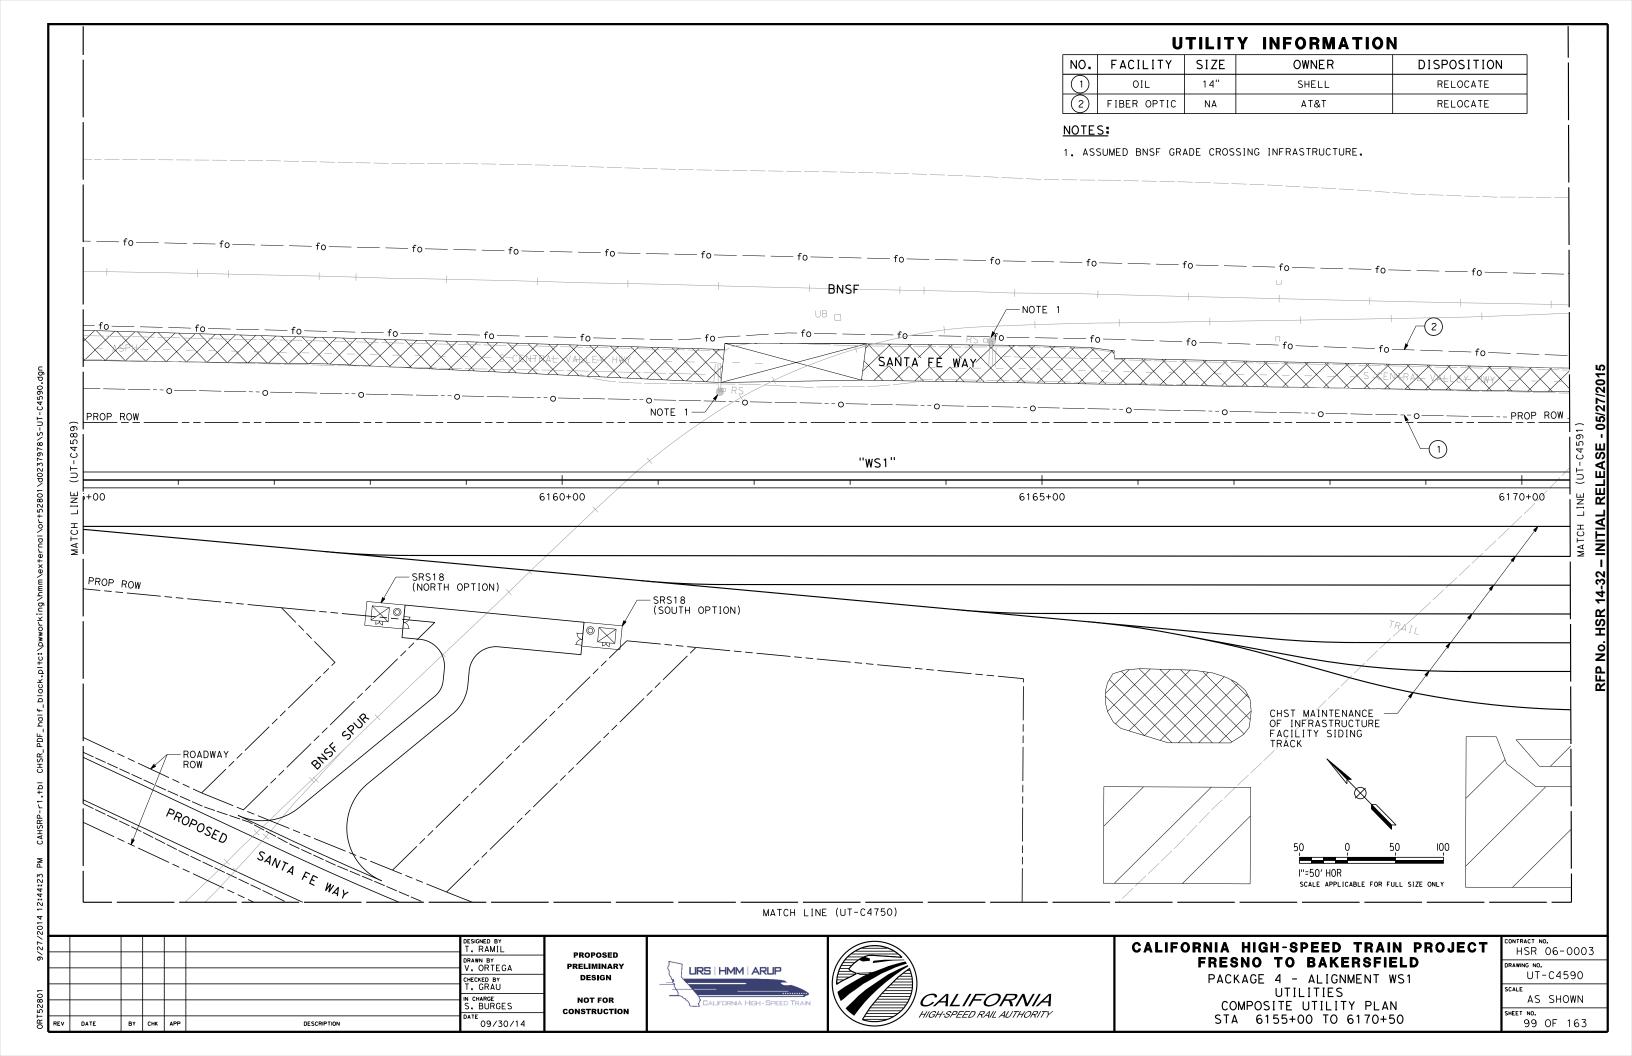


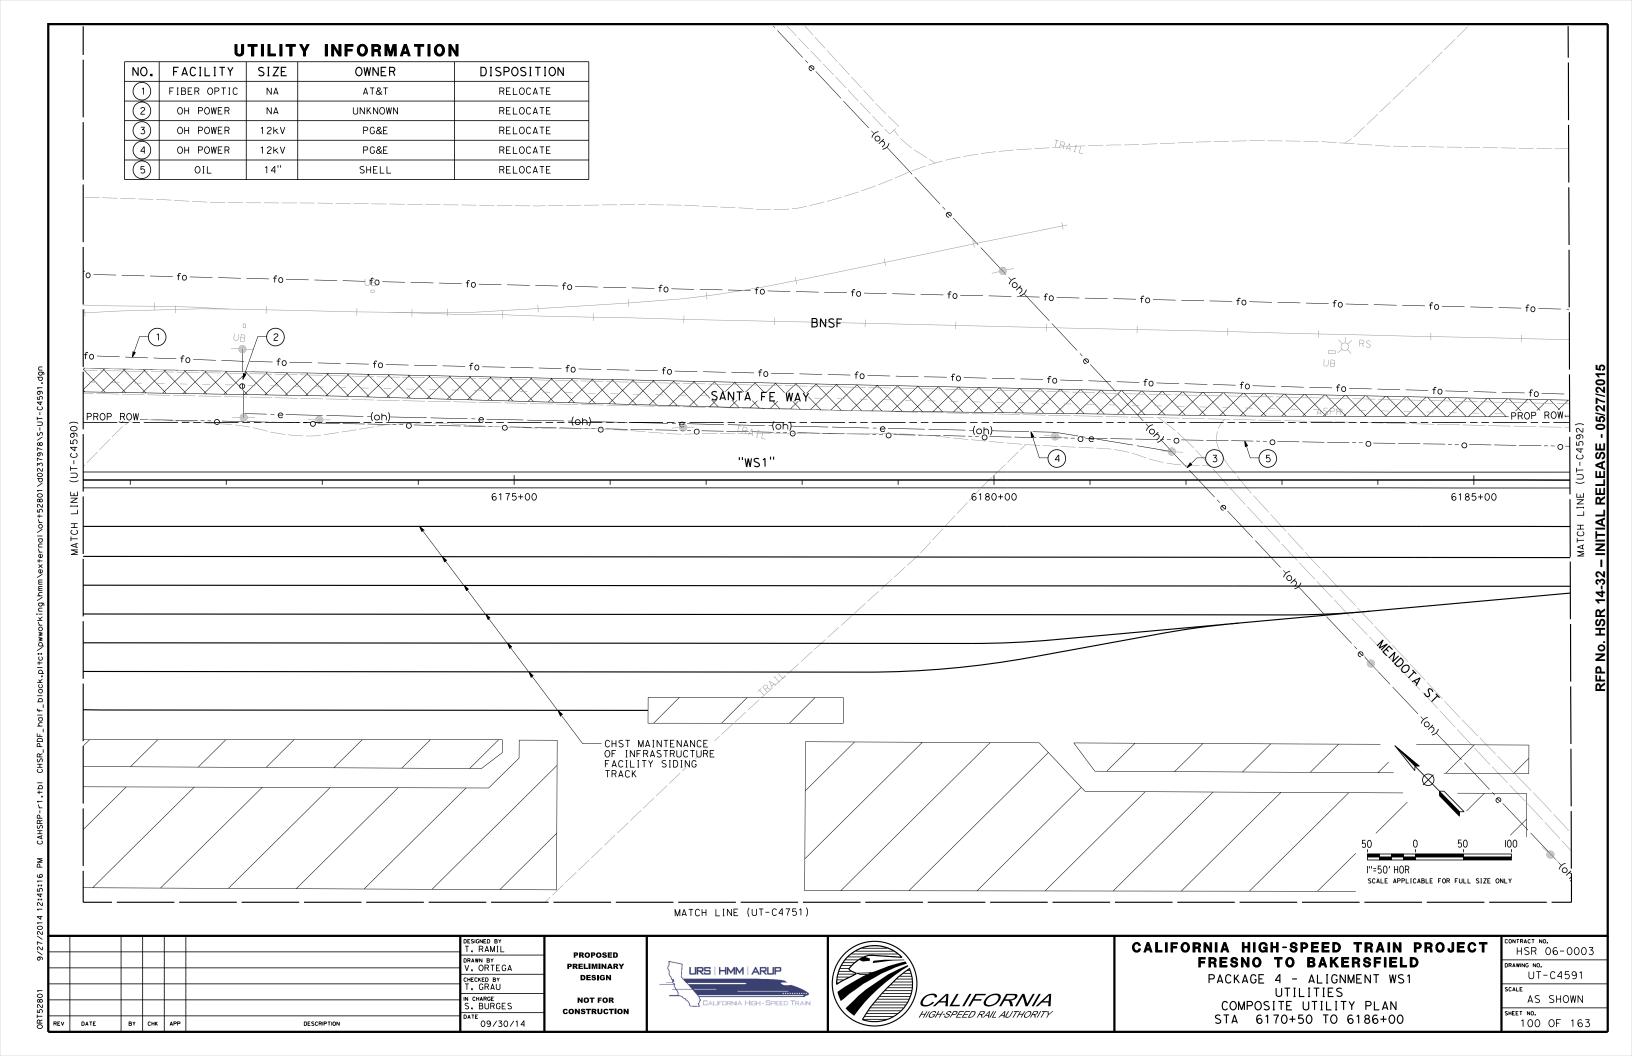


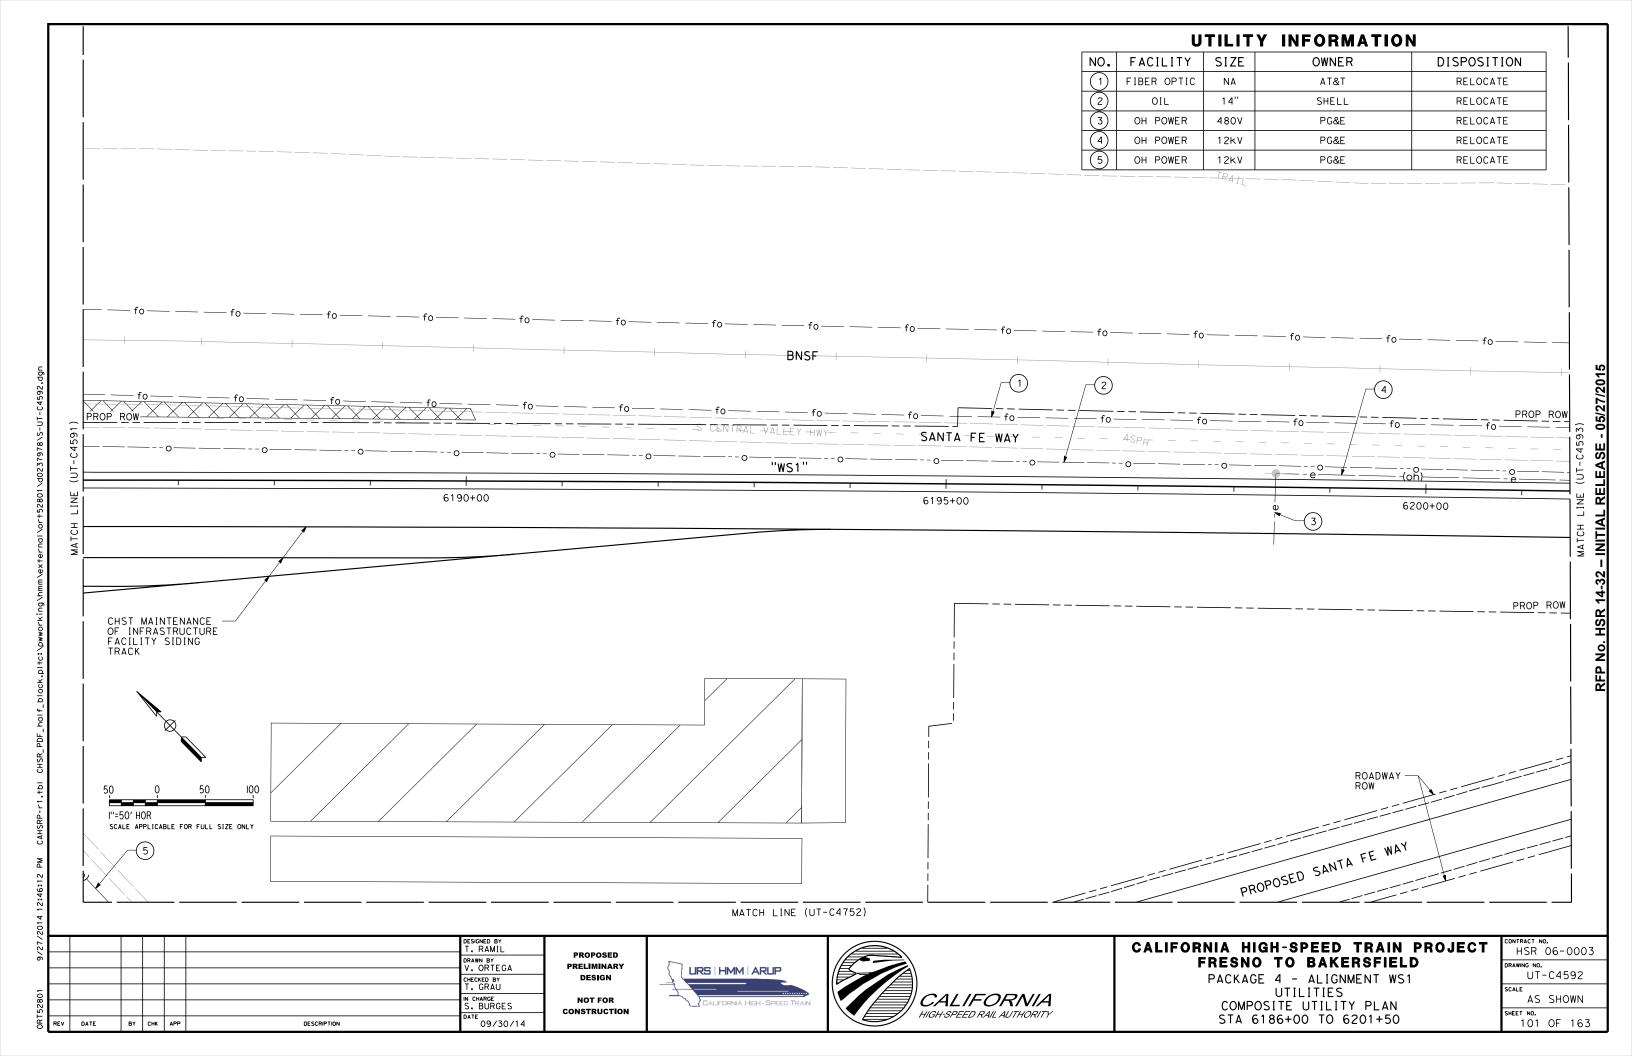


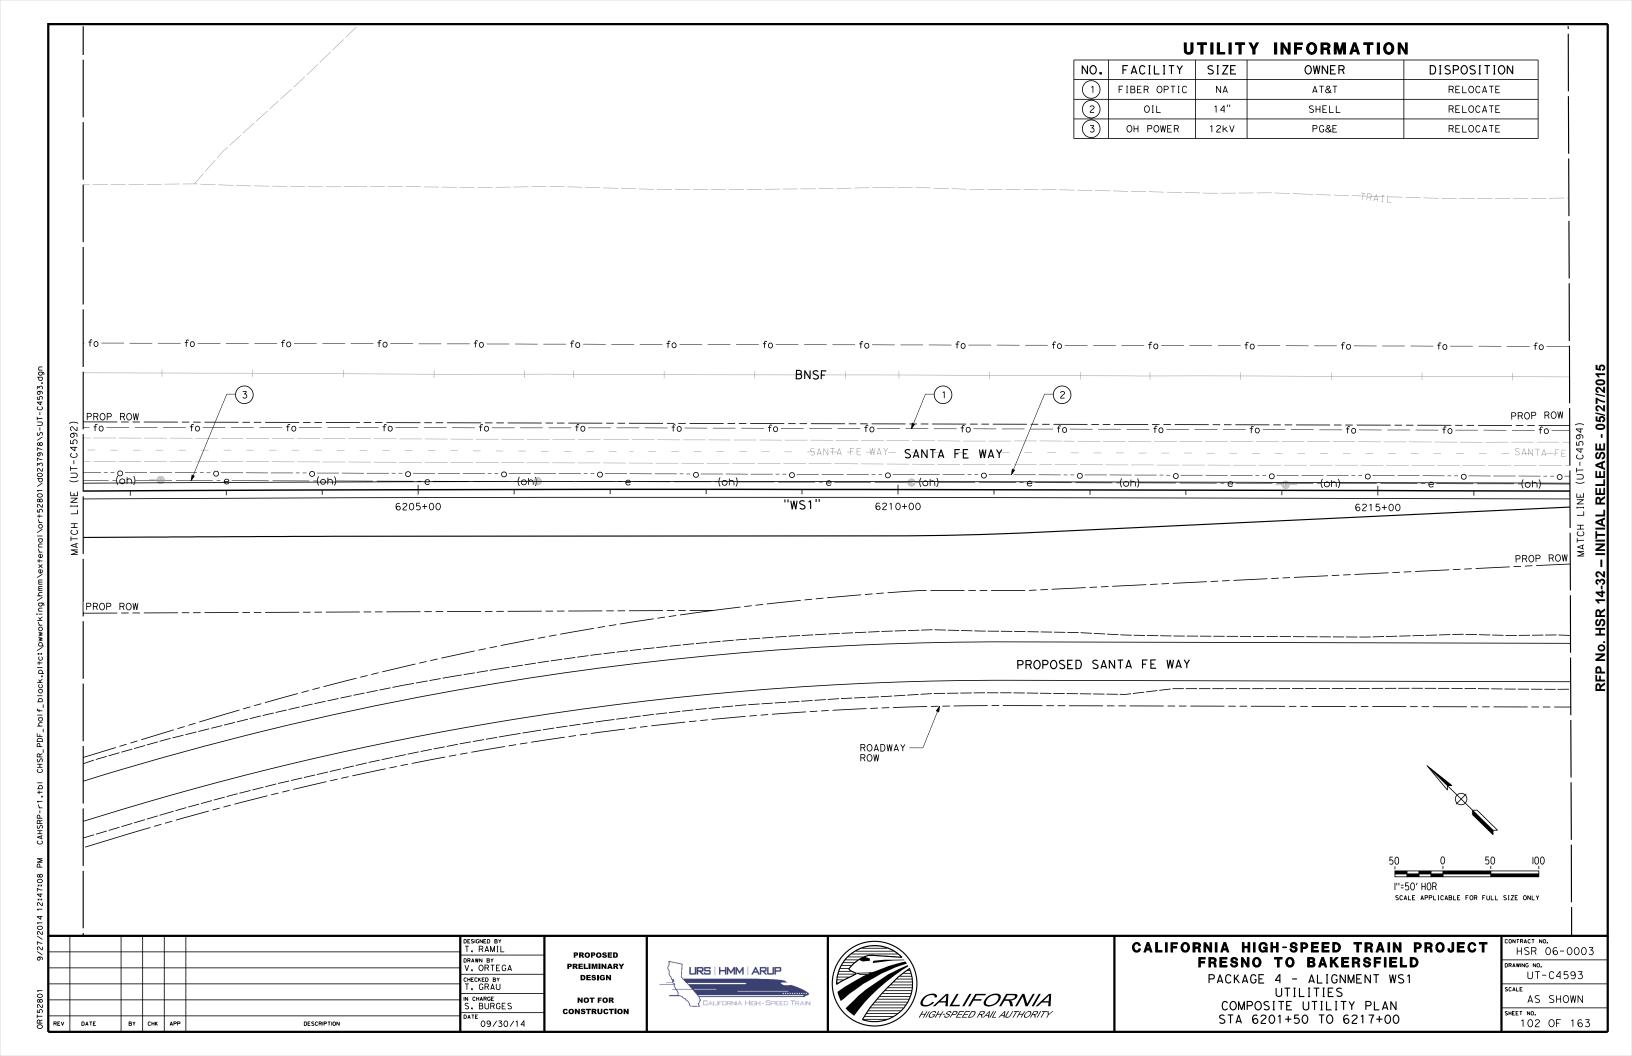


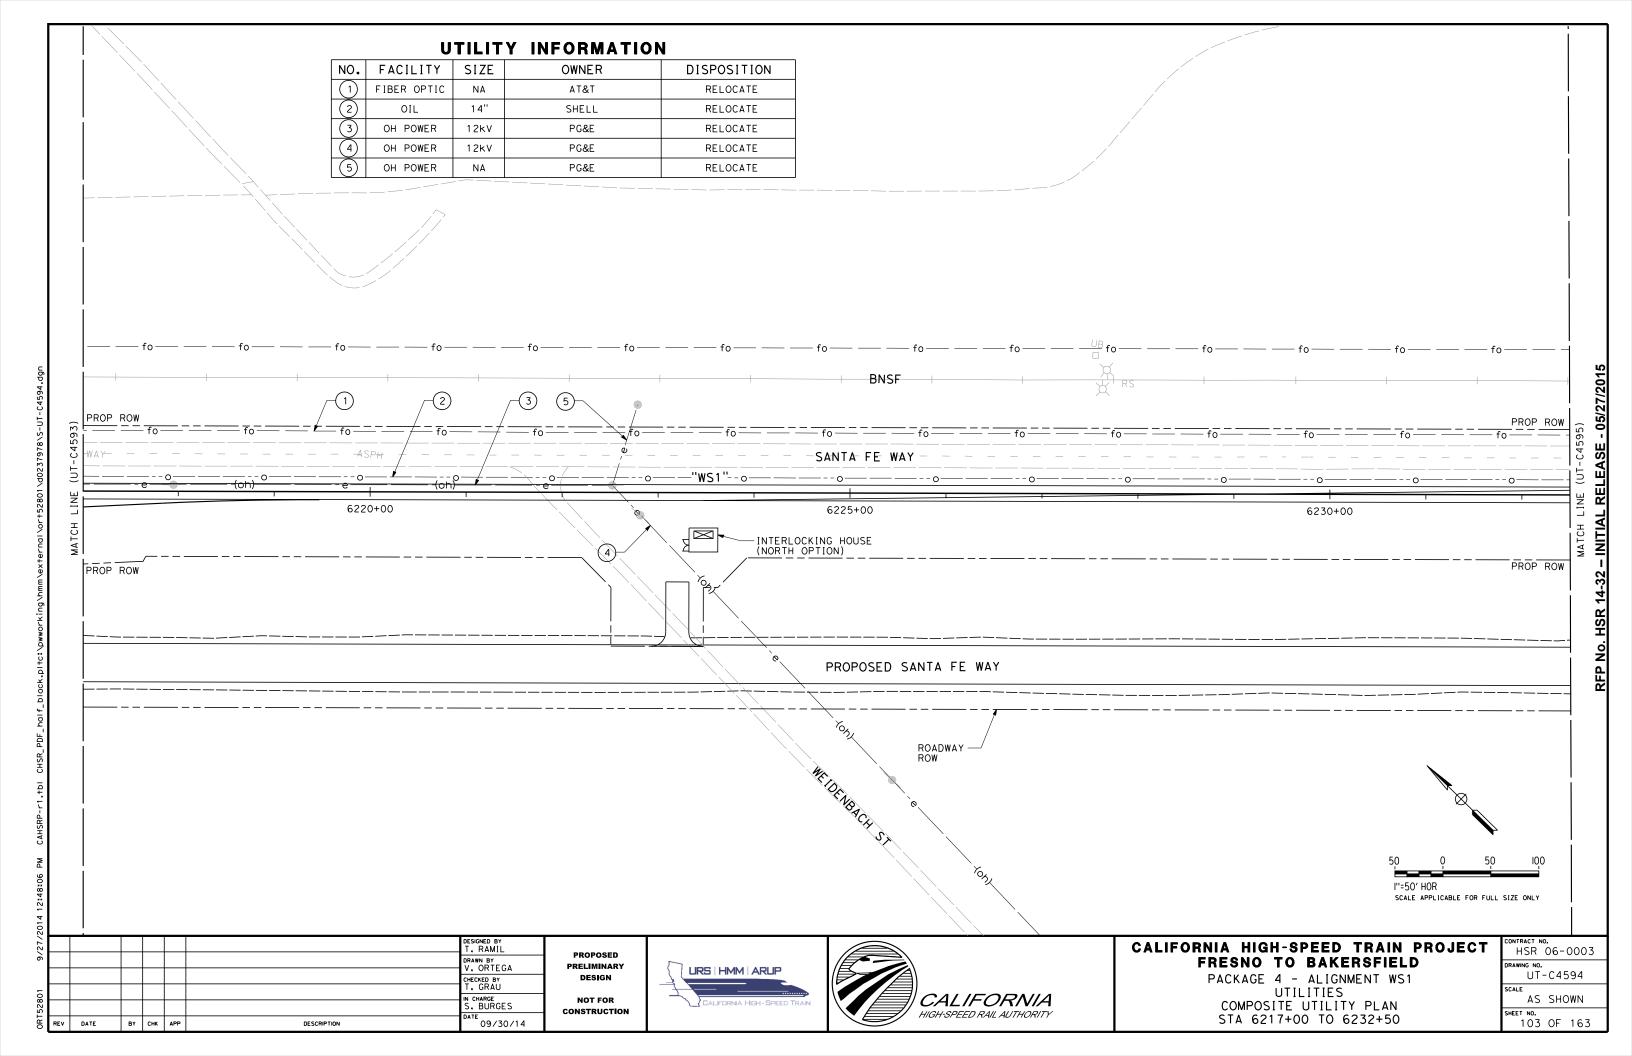


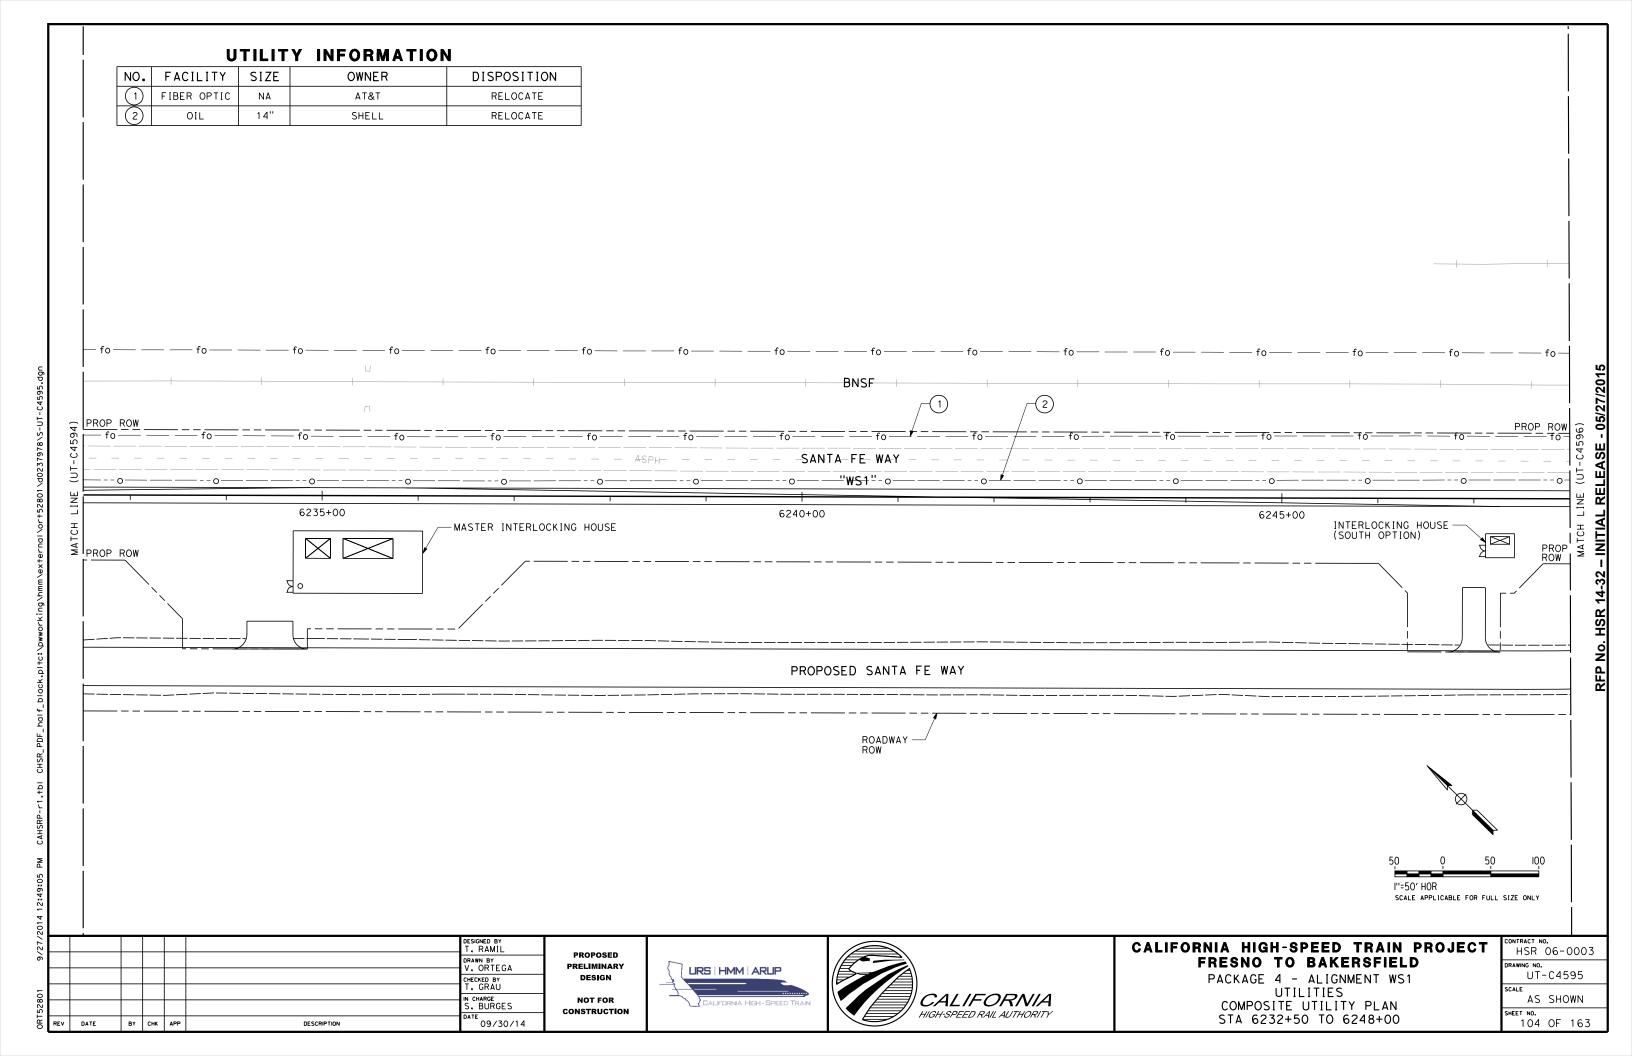

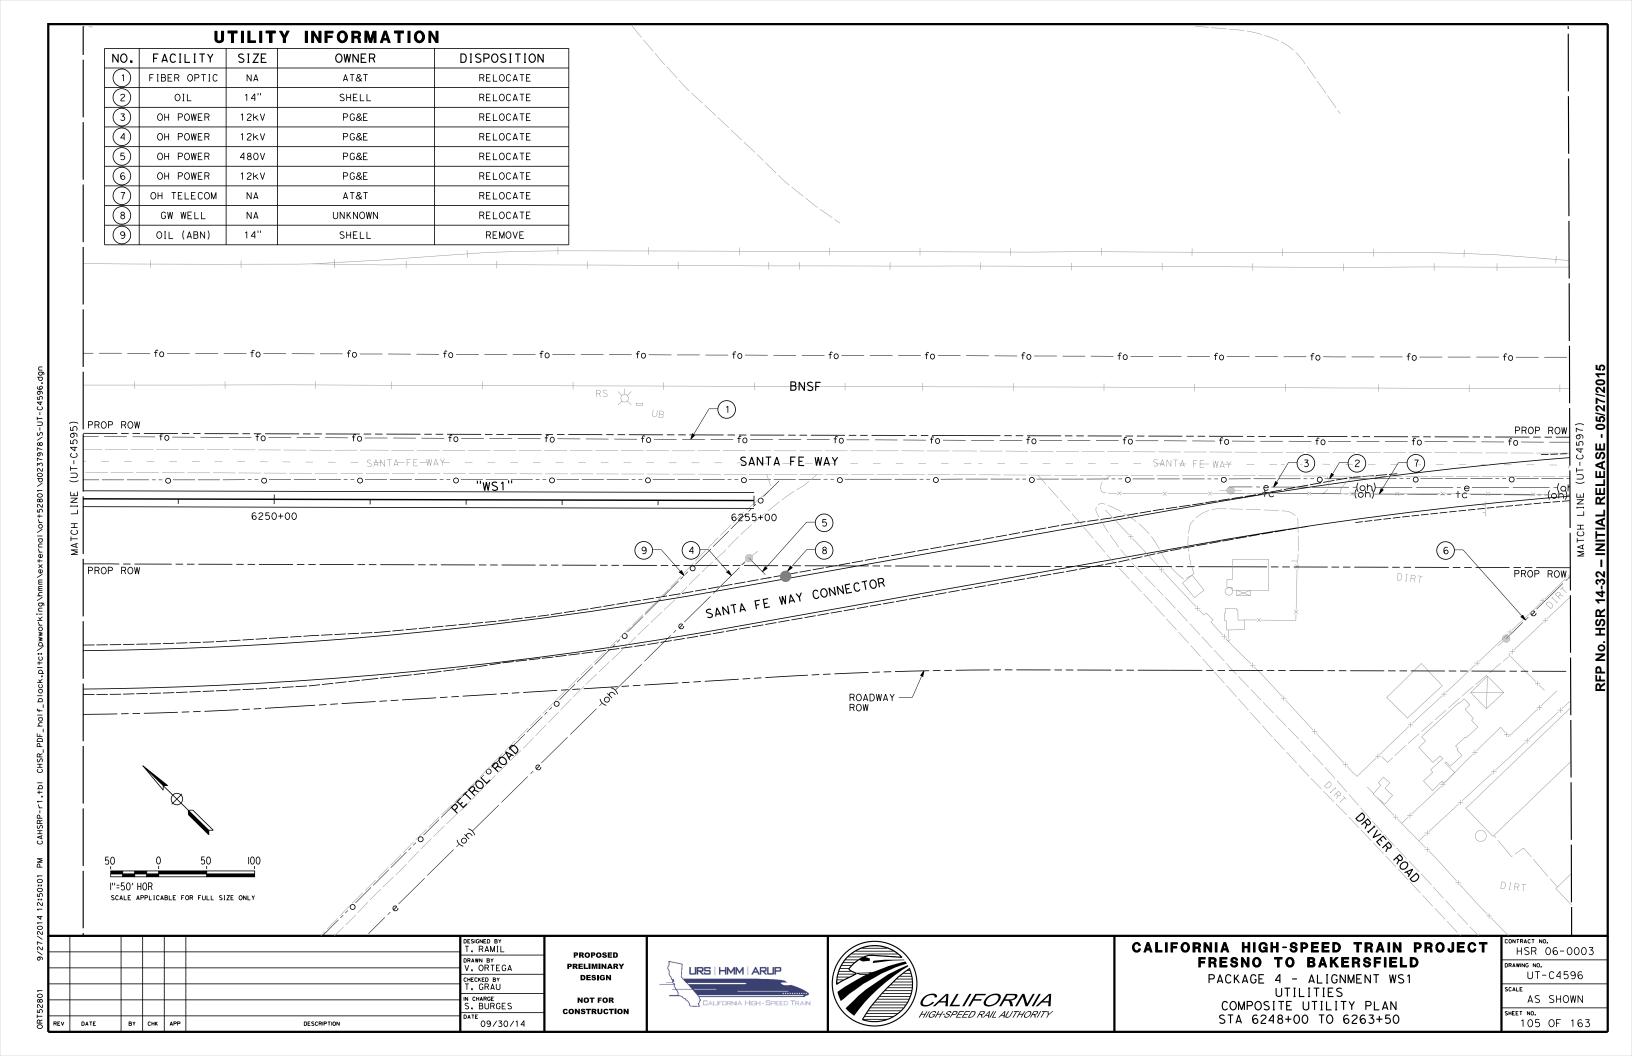


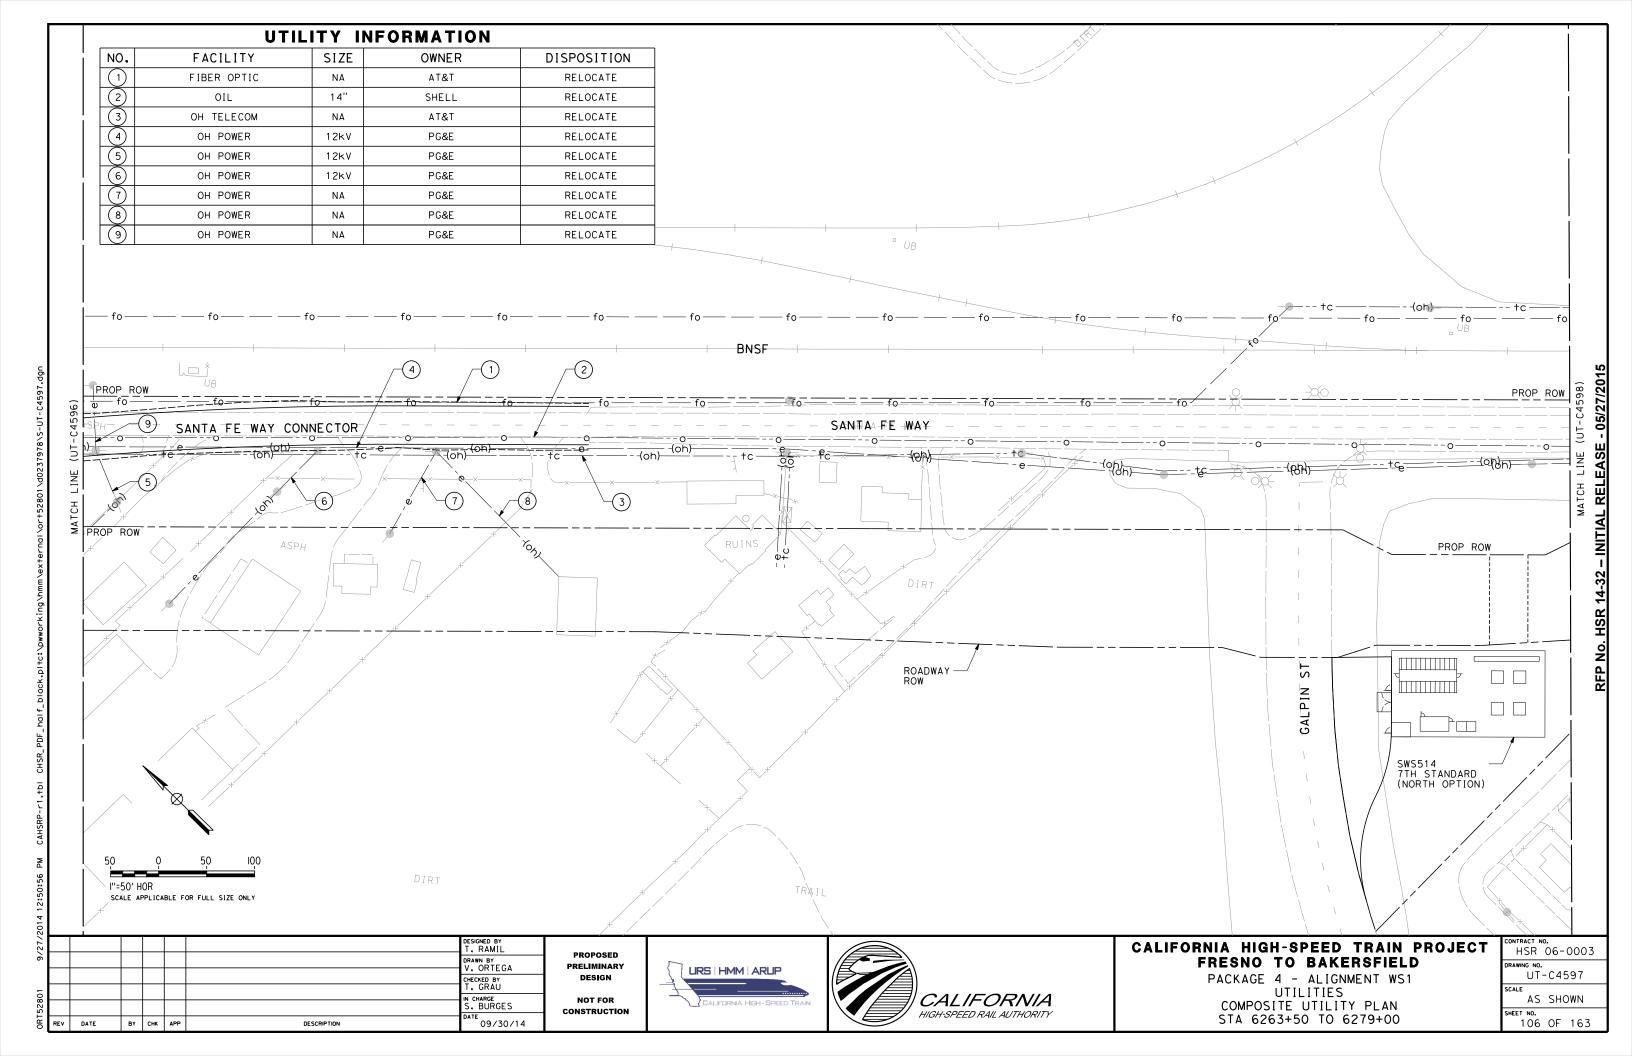

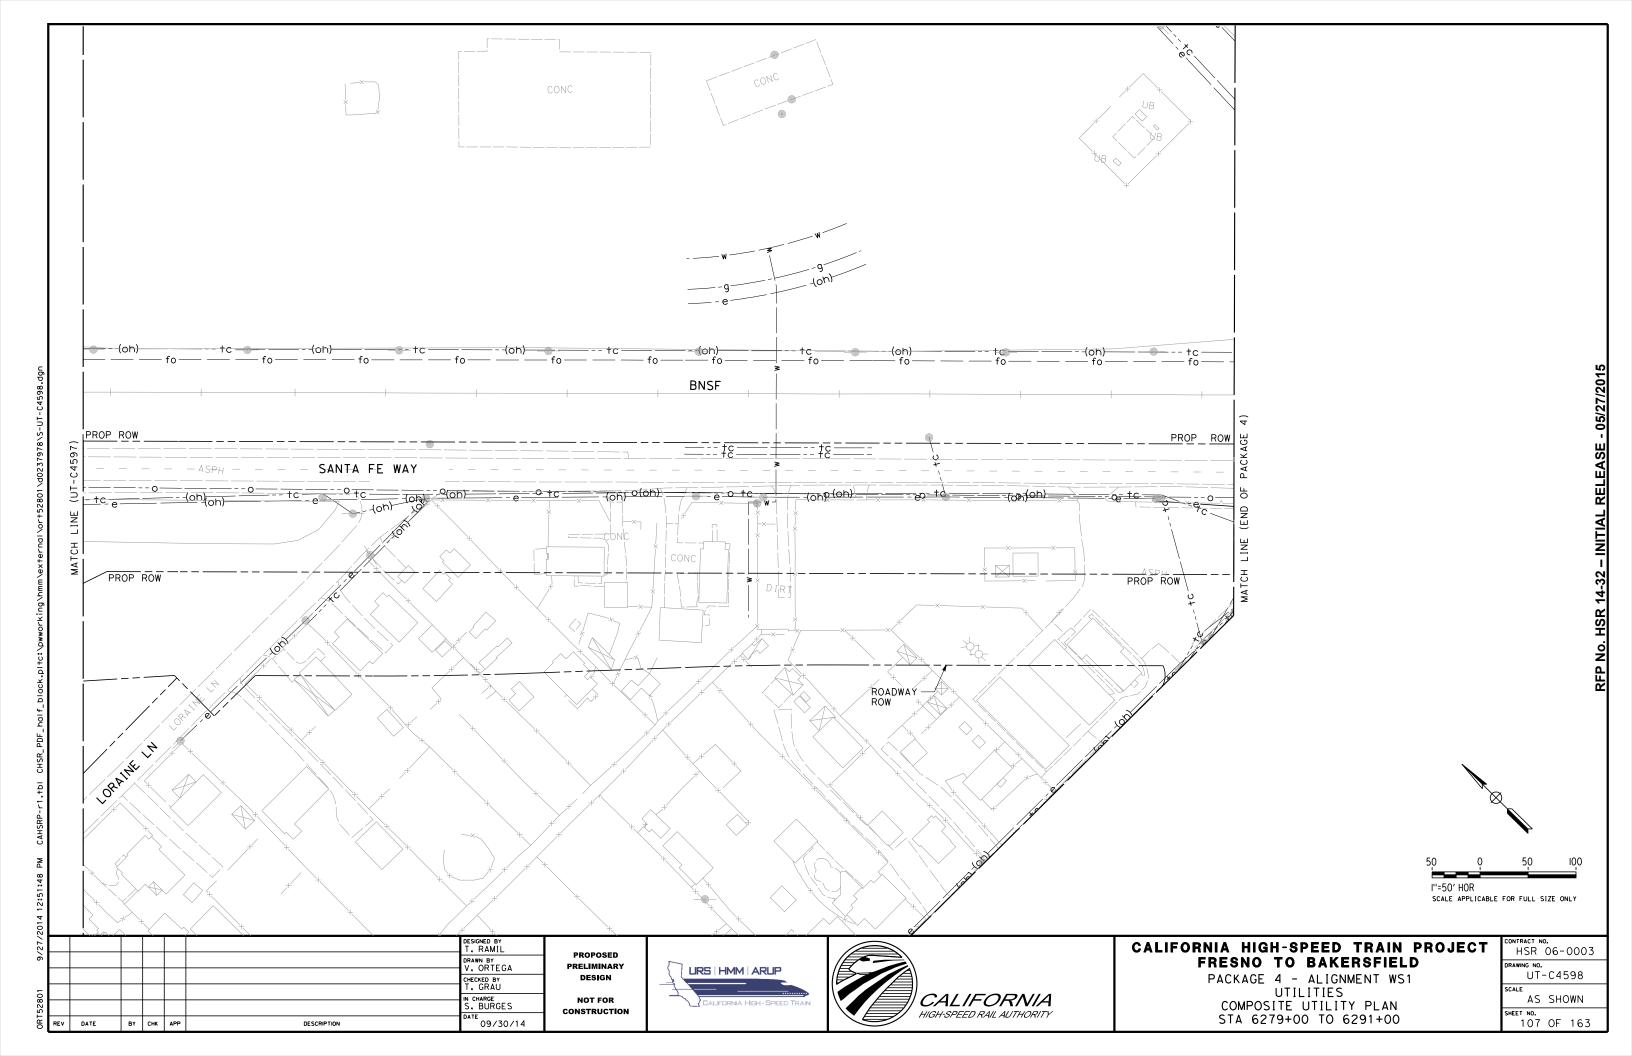

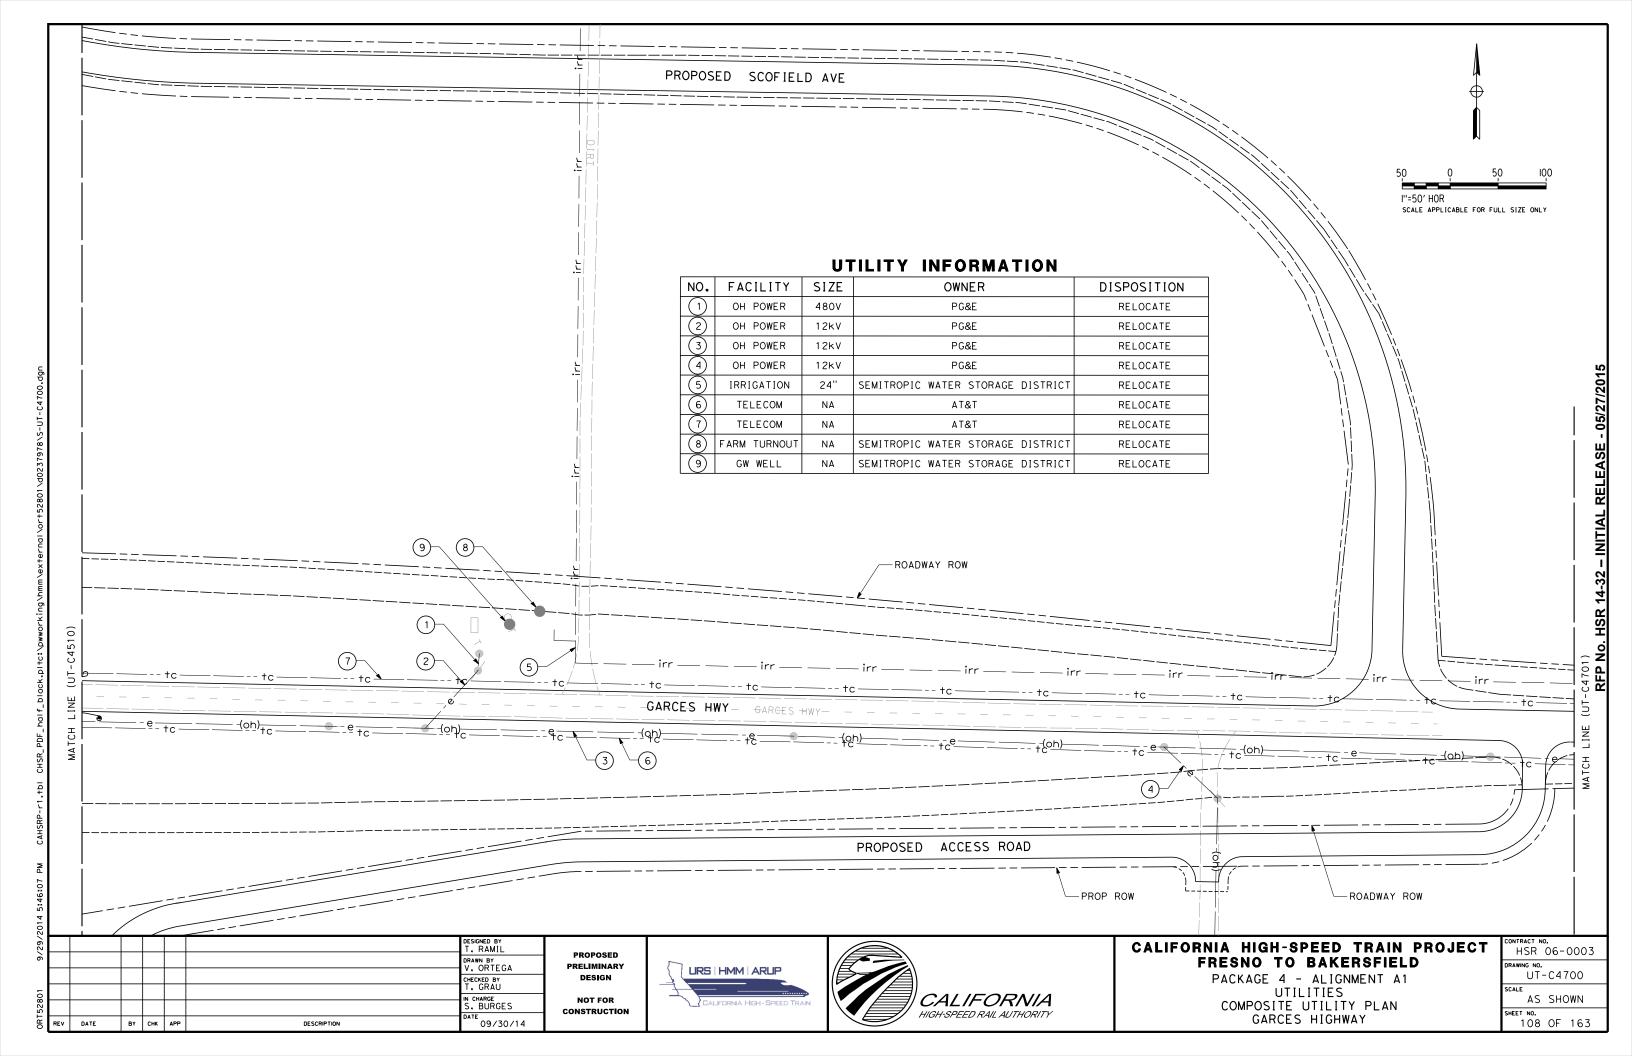

NO.	FACILITY SIZE		OWNER	DISPOSITION	
	OH POWER	12kV	PG&E	RELOCATE	
2	IRRIGATION	24''	SEMITROPIC WATER STORAGE DISTRICT	RELOCATE	
3	TELECOM	NA	АТ&Т	RELOCATE	
4	TELECOM	NA	AT&T	RELOCATE	

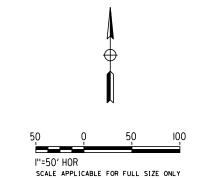

#### CALIFORNIA HIGH-SPEED TRAIN PROJECT FRESNO TO BAKERSFIELD

PACKAGE 4 - ALIGNMENT A1 UTILITIES COMPOSITE UTILITY PLAN GARCES HIGHWAY

-	CONTRACT NO.
	HSR 06-0003
	DRAWING NO.
	UT-C4701
	SCALE
	AS SHOWN
	SHEET NO.
	109 OF 163

CALIFORNIA






CONSTRUCTION


09/30/14

BY CHK APP

DESCRIPTION

				<u> </u>
NO.	FACILITY	SIZE	OWNER	DISPOSITION
(-)	OH POWER	12kV	PG&E	RELOCATE
2	TELECOM	NA	AT&T	RELOCATE
(3)	TELECOM	NA	AT&T	RELOCATE

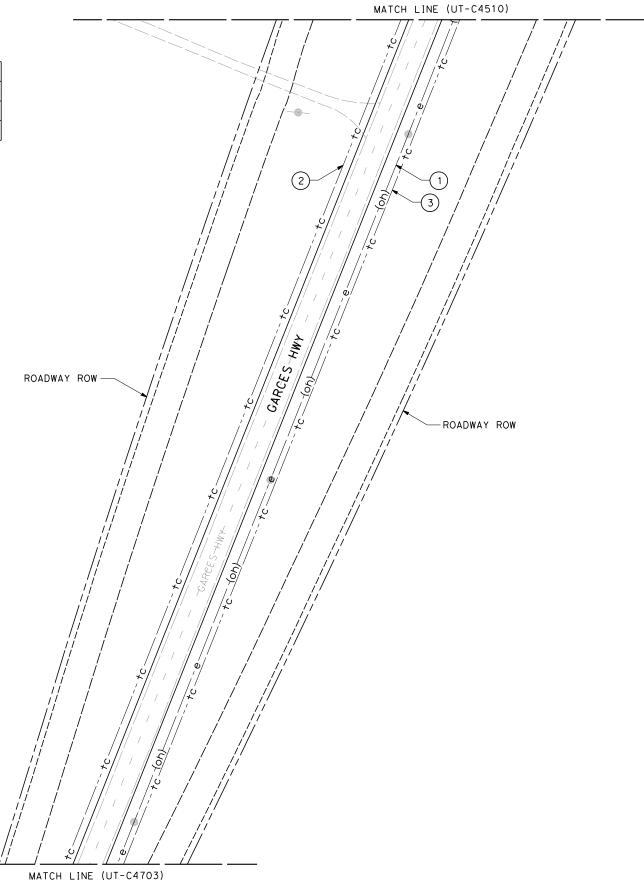

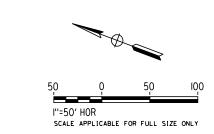

20								
/25/							DESIGNED BY T. RAMIL	
6							DRAWN BY V. ORTEGA	
_							CHECKED BY	
52801							IN CHARGE S. BURGES	
ORT	REV	DATE	ВΥ	СНК	APP	DESCRIPTION	DATE 09/30/14	

PROPOSED
PRELIMINARY
DESIGN
NOT FOR

CONSTRUCTION








# CALIFORNIA HIGH-SPEED TRAIN PROJECT FRESNO TO BAKERSFIELD


PACKAGE 4 - ALIGNMENT A1 UTILITIES COMPOSITE UTILITY PLAN GARCES HIGHWAY

CONTRACT HSR	NO. 06-1	0003
DRAWING NO		
U1	-C47	'02
SCALE		
AS	SHC	NWO
SHEET NO.		
110	OF	163

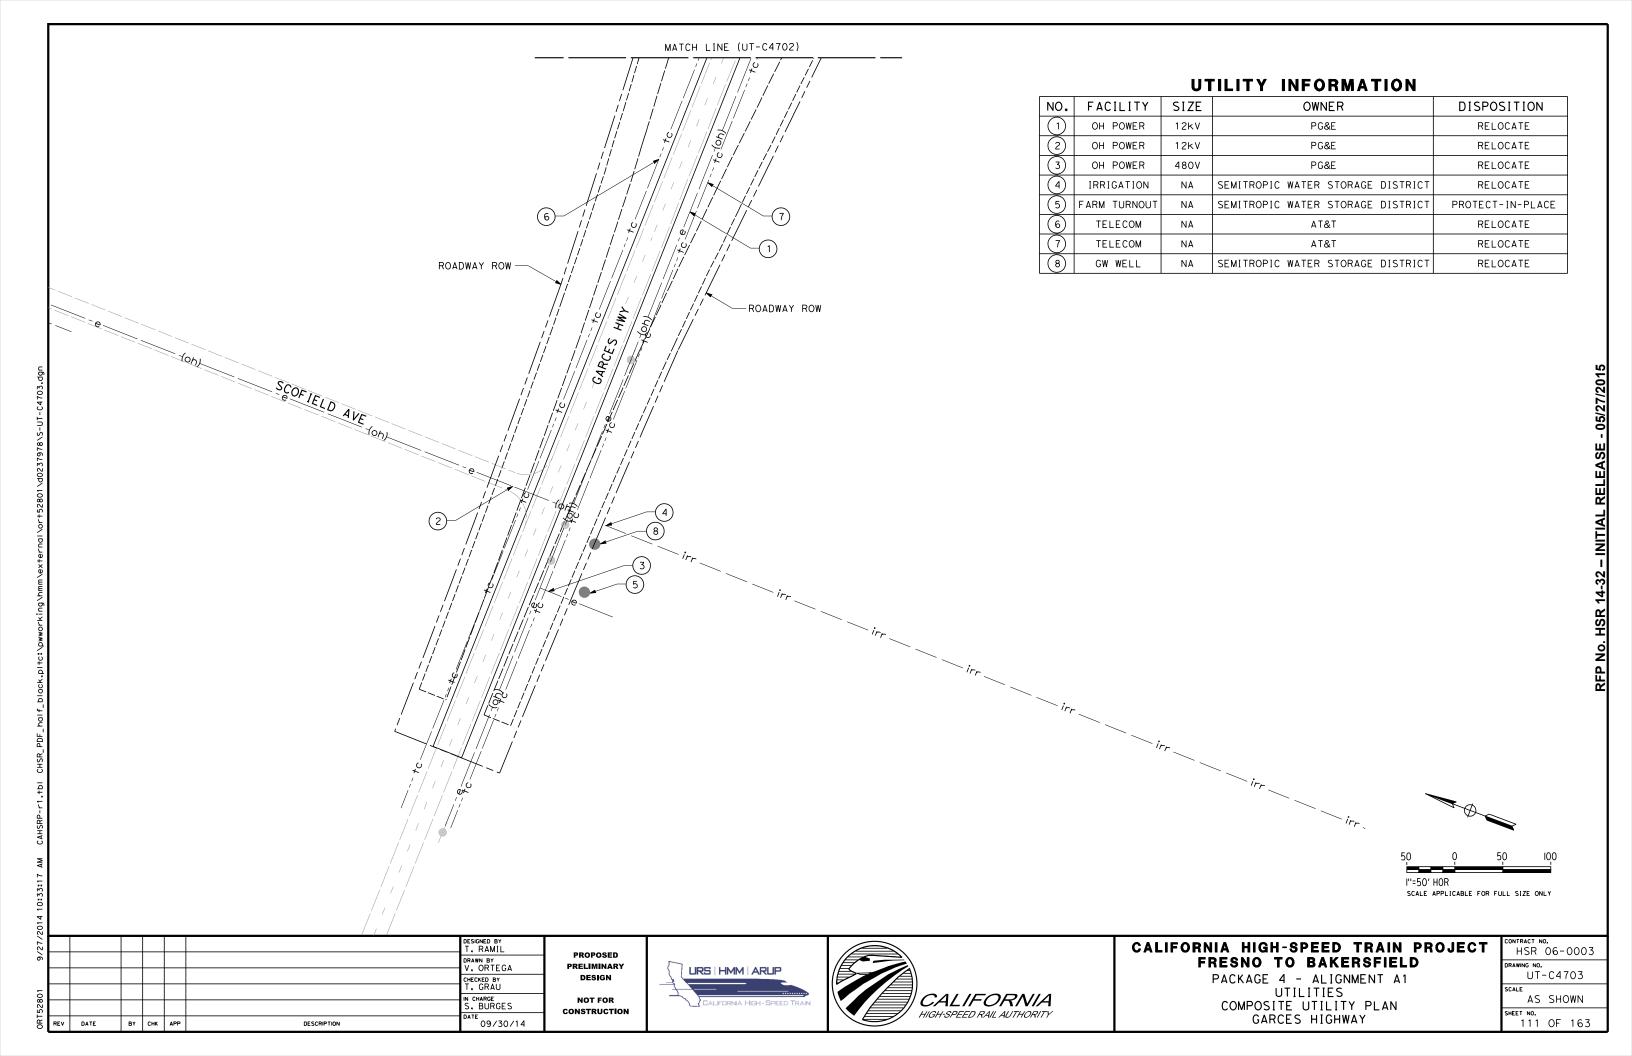

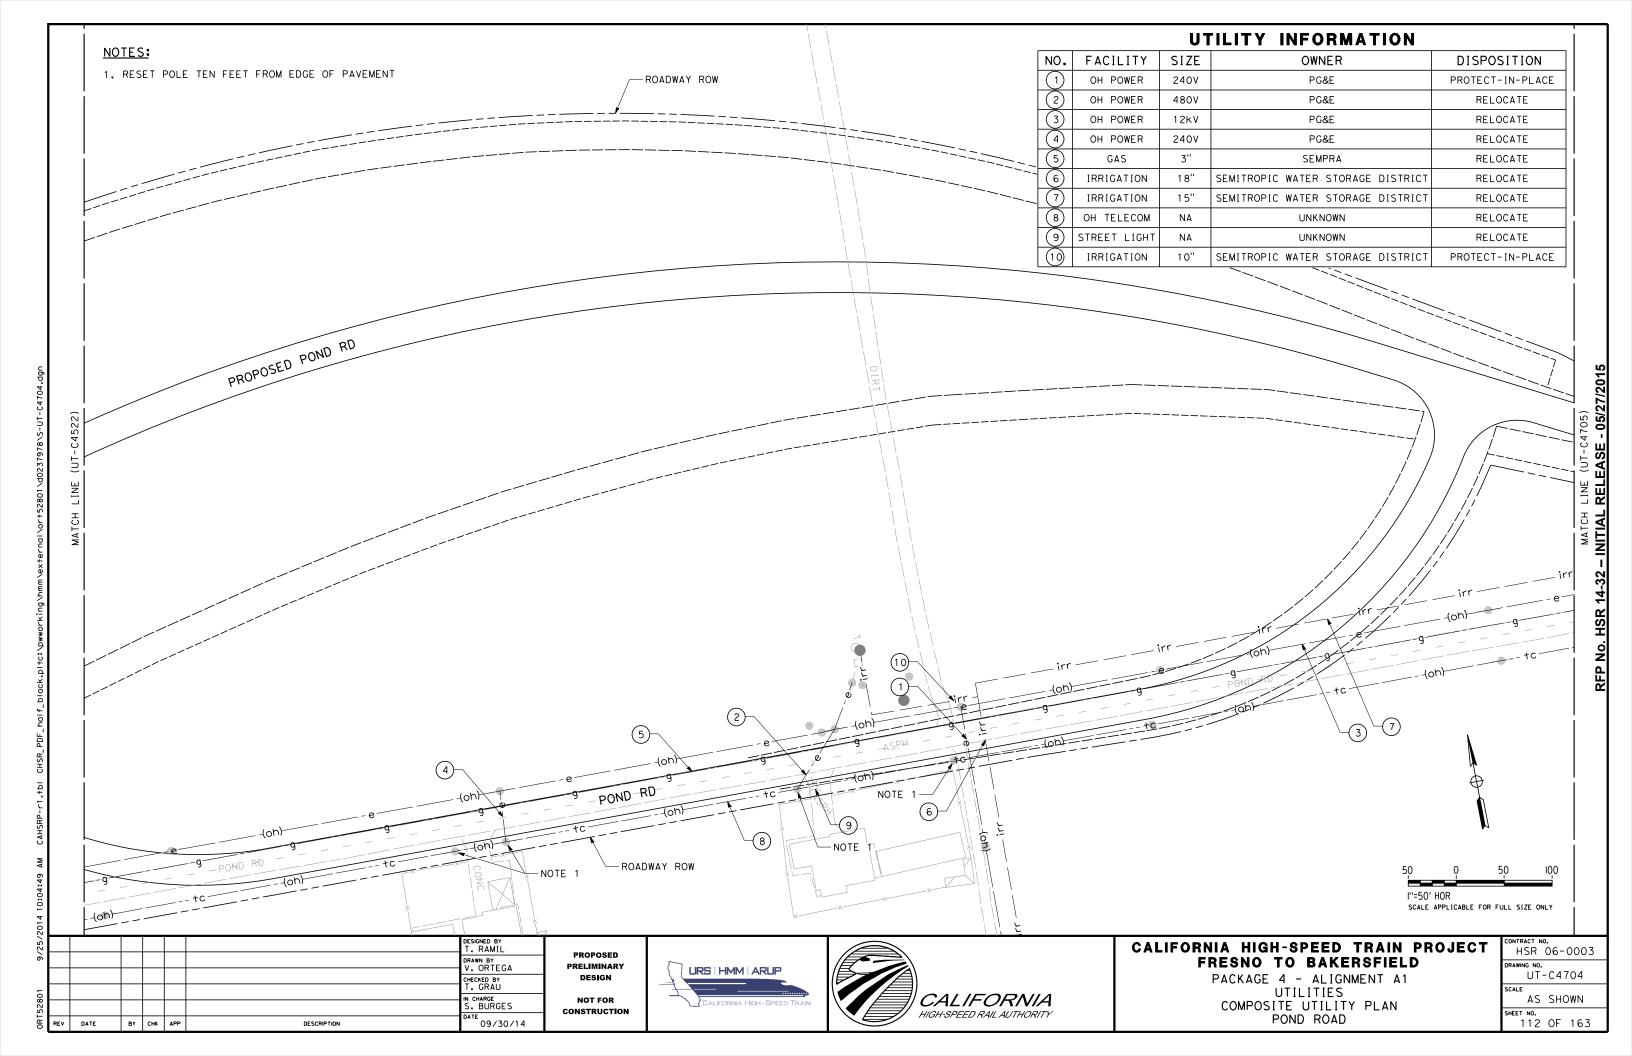

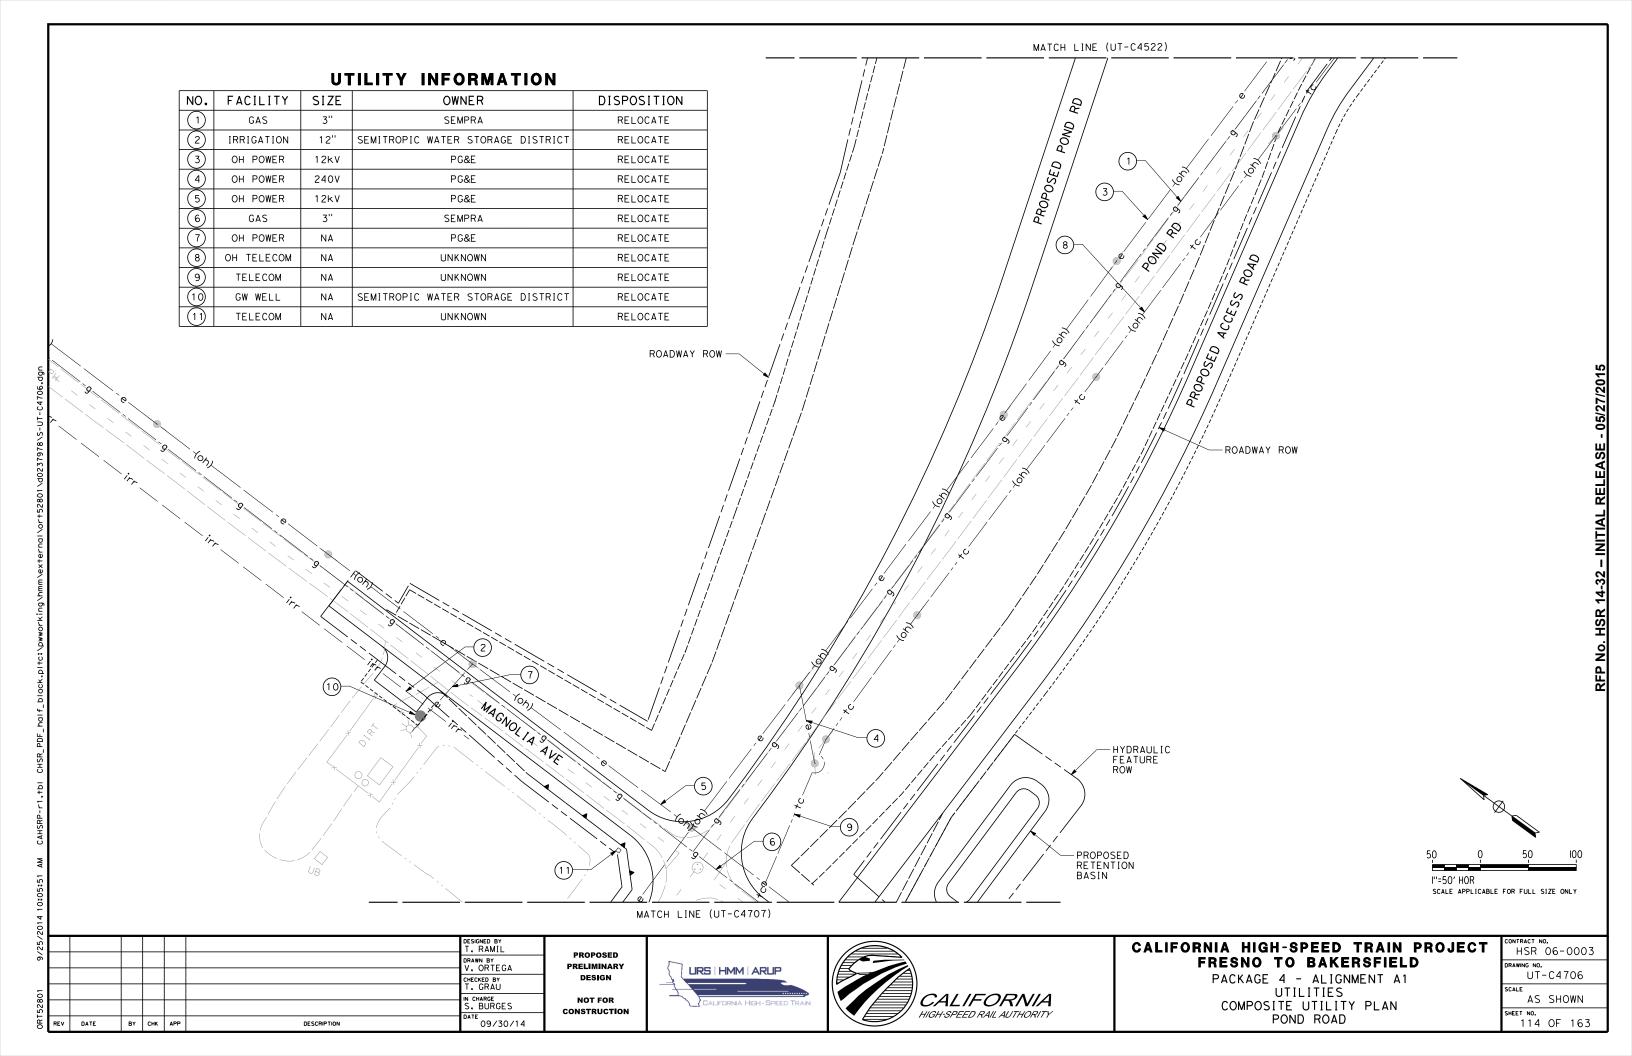

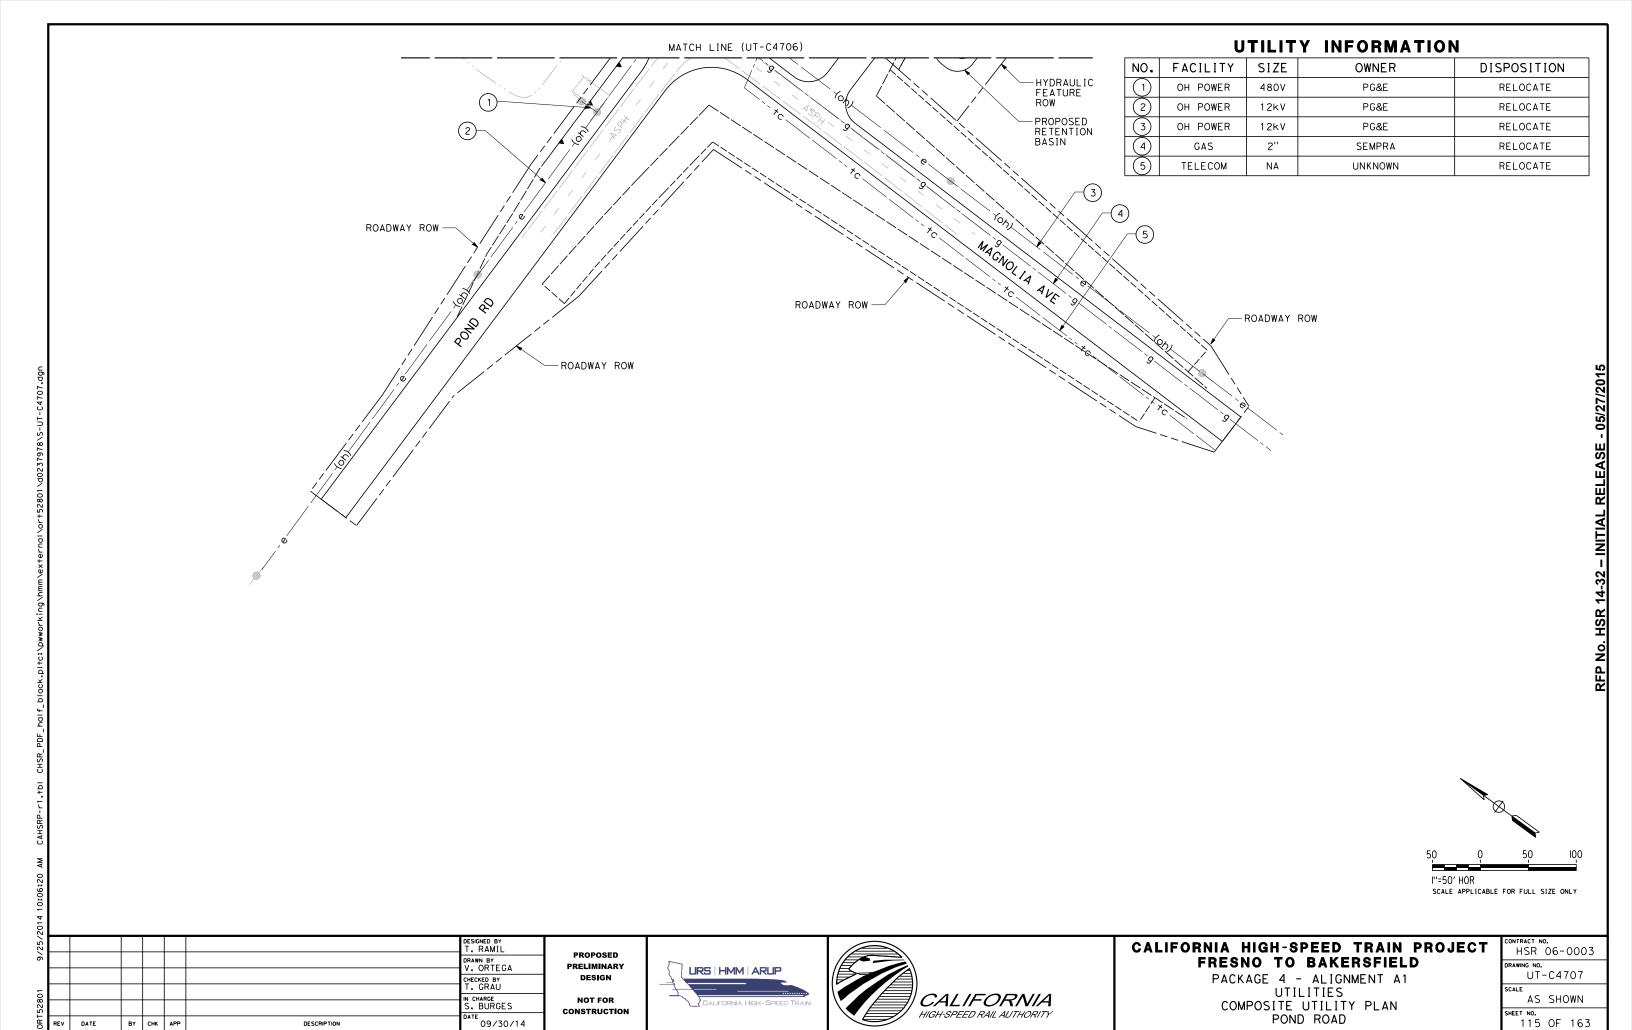


<sup>E</sup>09/30/14

DATE


BY CHK APP

DESCRIPTION

POND ROAD

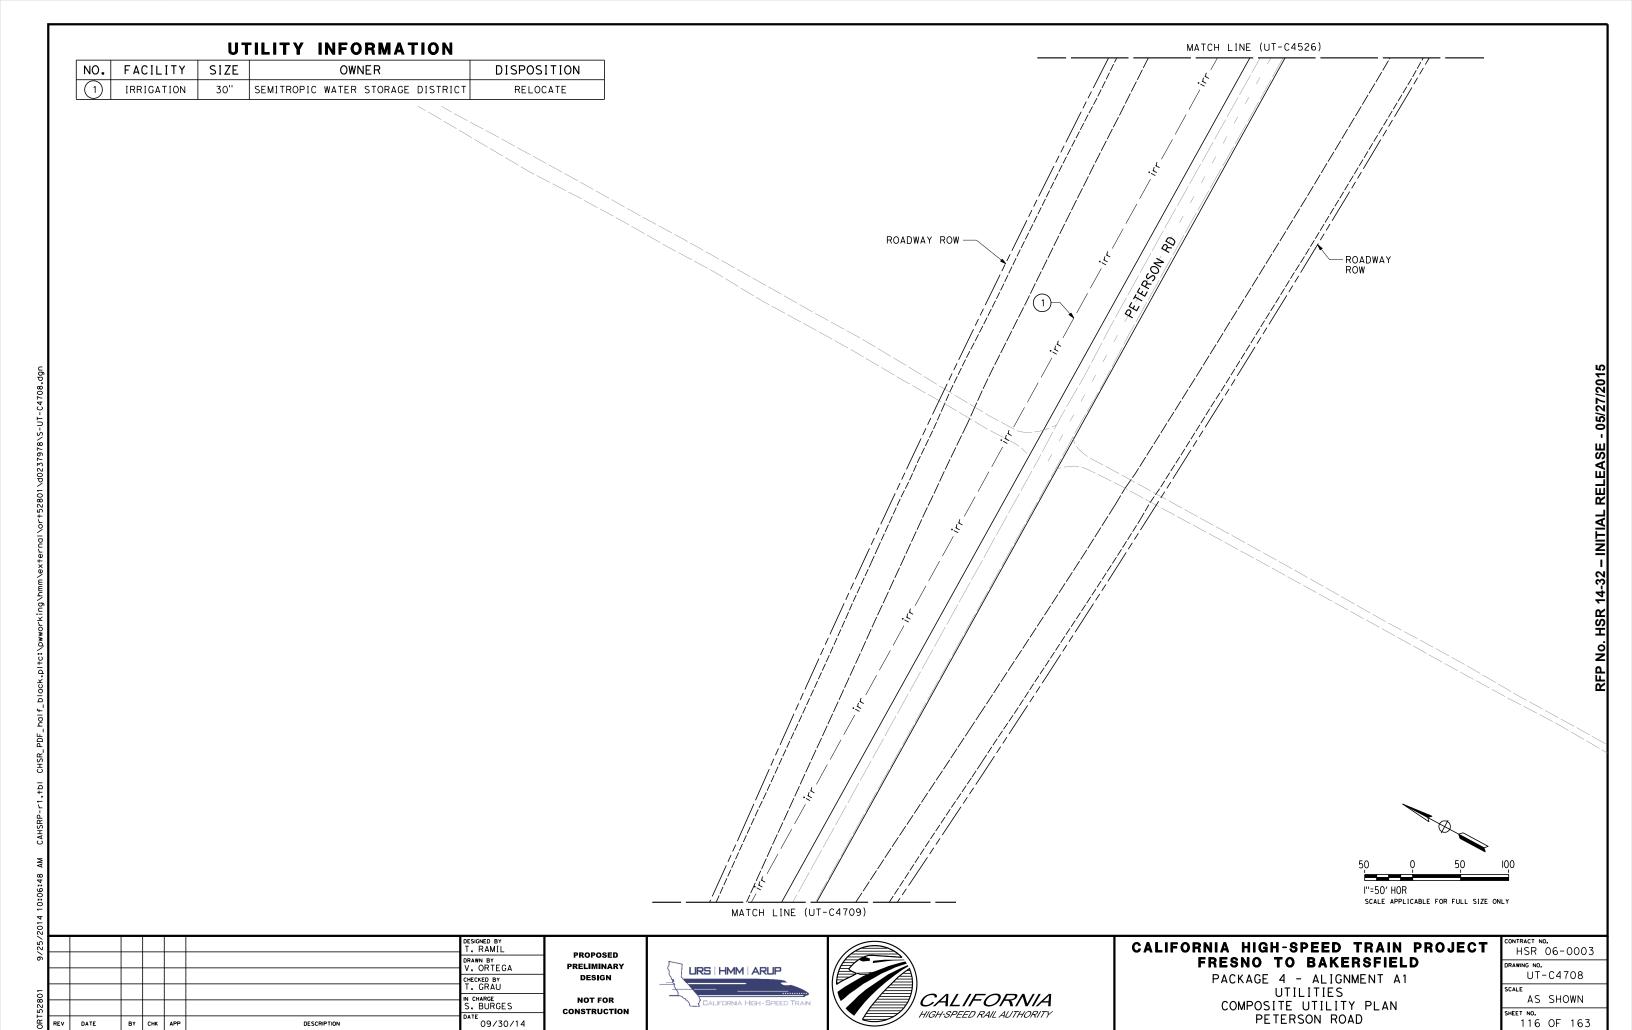



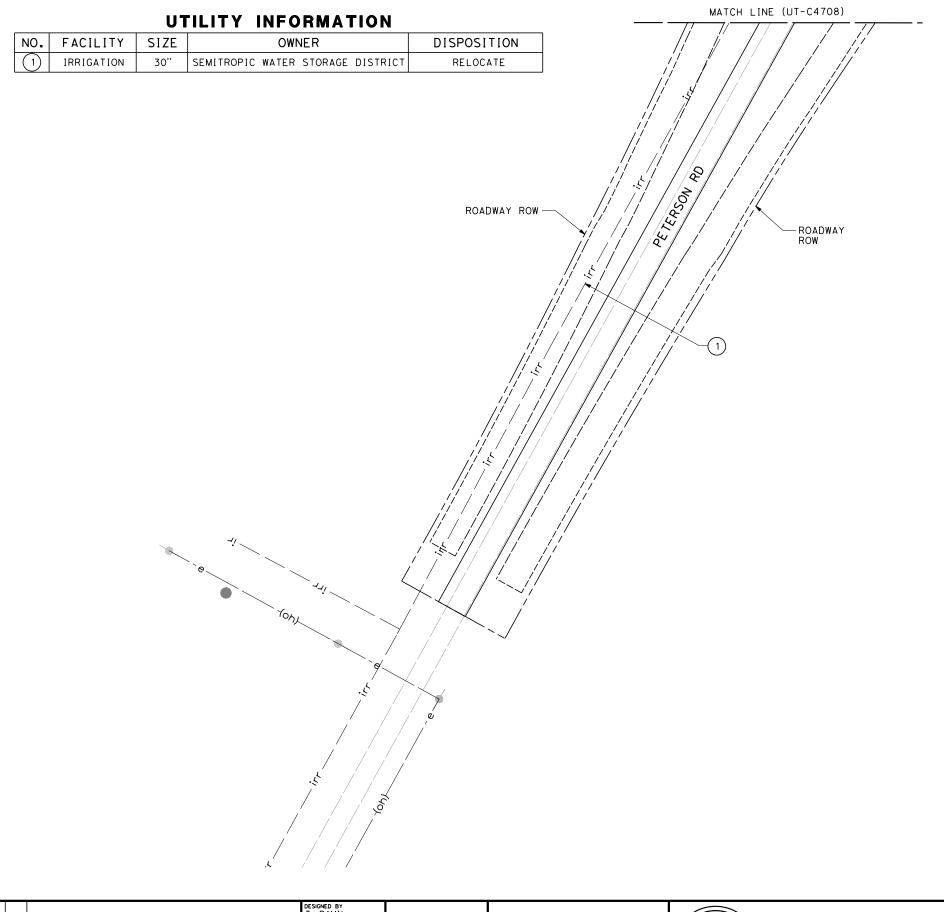

50 0 50 100
I"=50' HOR
SCALE APPLICABLE FOR FULL SIZE ONLY

| DESIGNED BY | T. RAMIL | DRAWN BY | V. ORTEGA | CHECKED BY | T. GRAU | | N. CHARGE | S. BURGES | DATE | BY | CHK | APP | DESCRIPTION | DATE | DATE

PROPOSED
PRELIMINARY
DESIGN
NOT FOR

CONSTRUCTION





## CALIFORNIA HIGH-SPEED TRAIN PROJECT FRESNO TO BAKERSFIELD


PACKAGE 4 - ALIGNMENT A1 UTILITIES COMPOSITE UTILITY PLAN PETERSON ROAD

HSR 06-0003
DRAWING NO.
UT-C4709
SCALE
AS SHOWN

AS SHOWN

SHEET NO.

117 OF 163

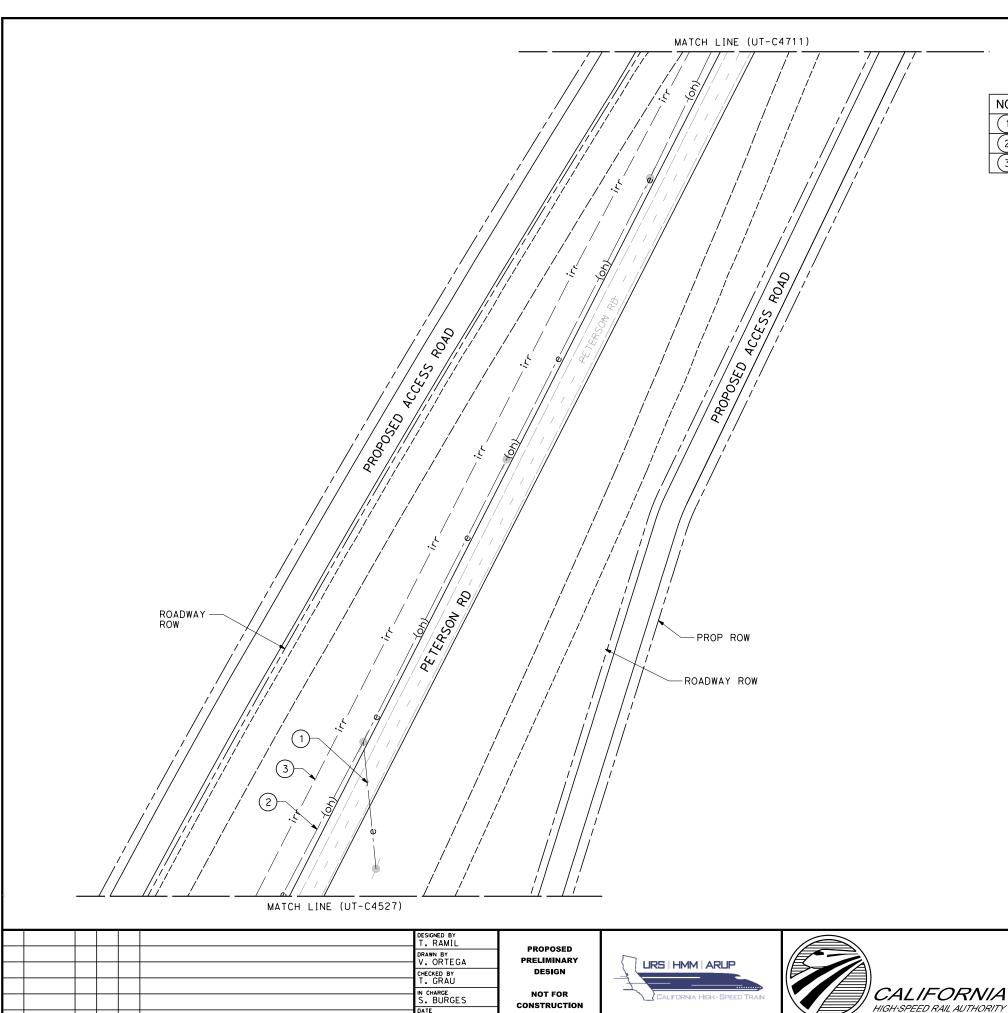

09/30/14


DATE

BY CHK APP

DESCRIPTION

#### **UTILITY INFORMATION**

NO.	FACILITY	FACILITY SIZE OWNER		DISPOSITION
	OH POWER	12kV	PG&E	RELOCATE
2	OH POWER	12kV	PG&E	RELOCATE
3	IRRIGATION	30''	SEMITROPIC WATER STORAGE DISTRICT	RELOCATE

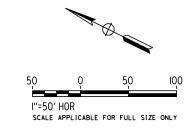



# CALIFORNIA HIGH-SPEED TRAIN PROJECT FRESNO TO BAKERSFIELD

PACKAGE 4 - ALIGNMENT A1 UTILITIES COMPOSITE UTILITY PLAN PETERSON ROAD

CONTRACT NO.
HSR 06-0003
DRAWING NO.
UT-C4710
SCALE
AS SHOWN
SHEET NO.
118 OF 163

ΝО.	FACILITY	SIZE	OWNER	DISPOSITION						
	IRRIGATION	30''	SEMITROPIC WATER STORAGE DISTRICT	RELOCATE						
(2)	OH POWER	12kV	PG&E	RELOCATE						
3	POWER	NA	PG&E	RELOCATE						

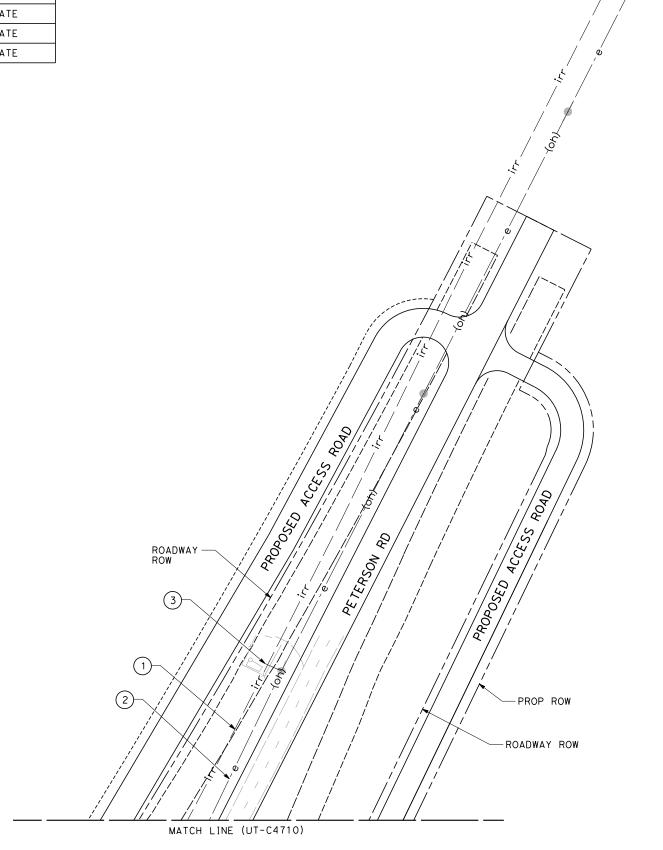

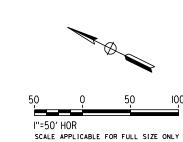

						DESIGNED BY T. RAMIL
						DRAWN BY V. ORTEGA
						CHECKED BY T. GRAU
						IN CHARGE S. BURGES
REV	DATE	ВΥ	СНК	APP	DESCRIPTION	DATE 09/30/14

PROPOSED PRELIMINARY DESIGN NOT FOR

CONSTRUCTION







#### CALIFORNIA HIGH-SPEED TRAIN PROJECT FRESNO TO BAKERSFIELD


PACKAGE 4 - ALIGNMENT A1 UTILITIES COMPOSITE UTILITY PLAN PETERSON ROAD

•	CONTRACT NO. HSR 06-0003
	DRAWING NO. UT-C4711
	SCALE AS SHOWN
	SHEET NO. 119 OF 163

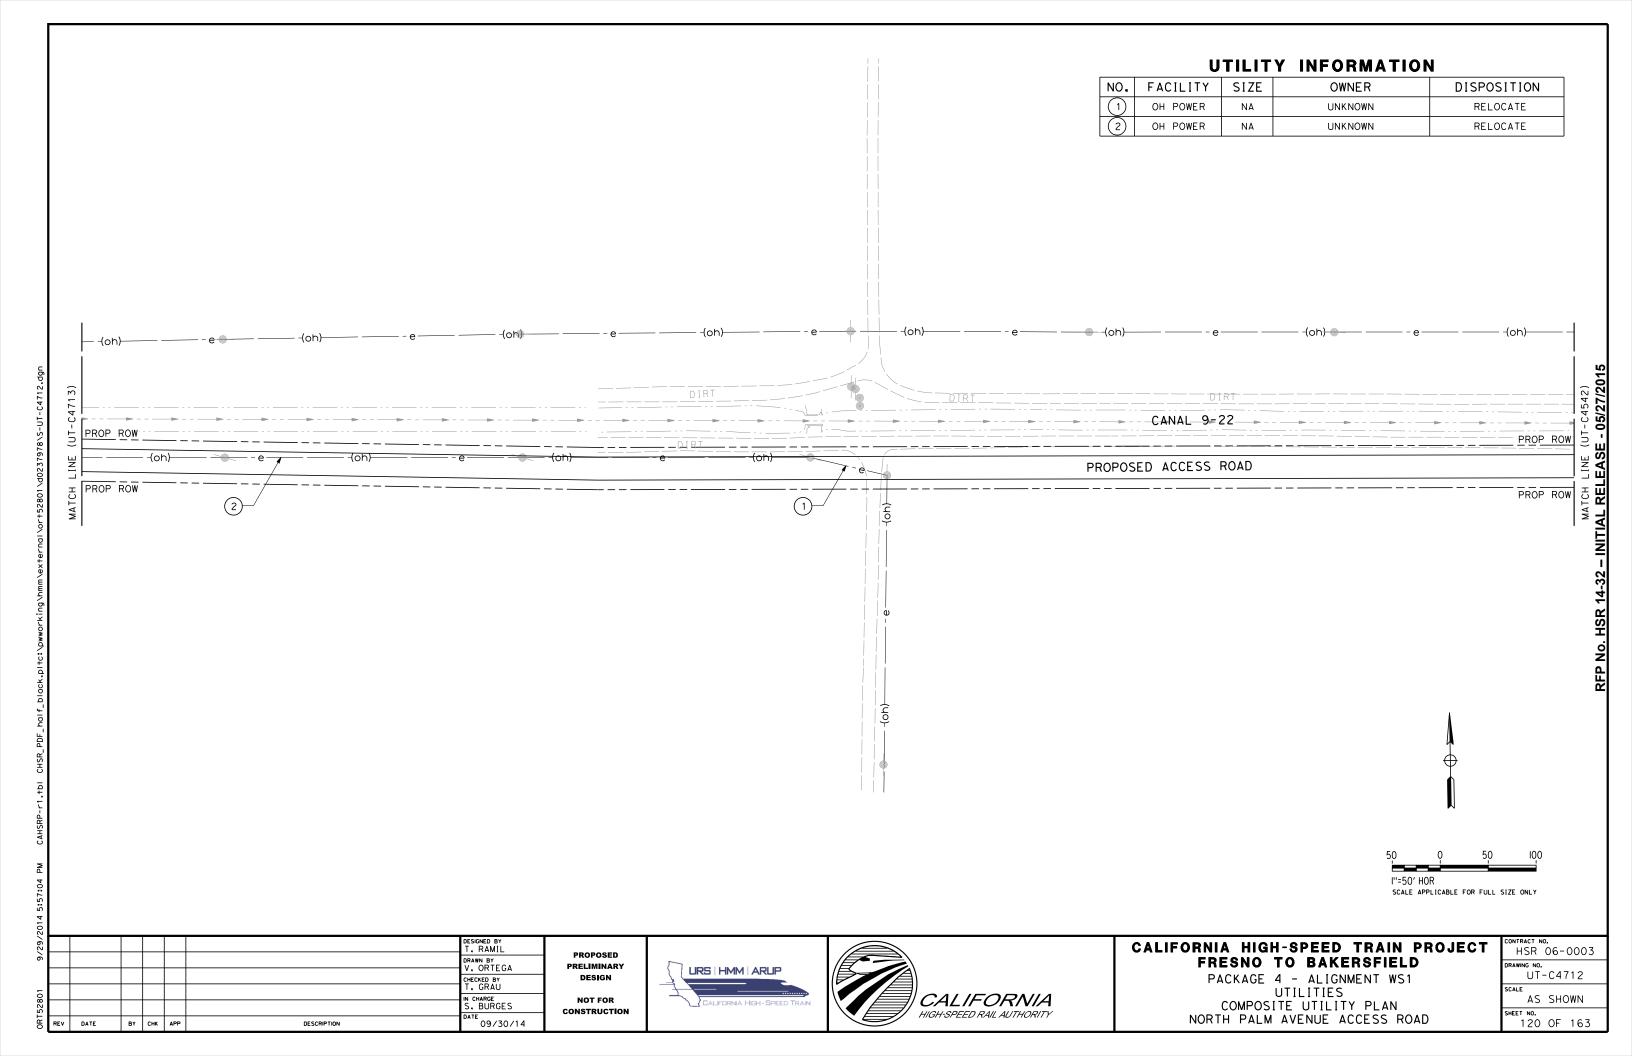

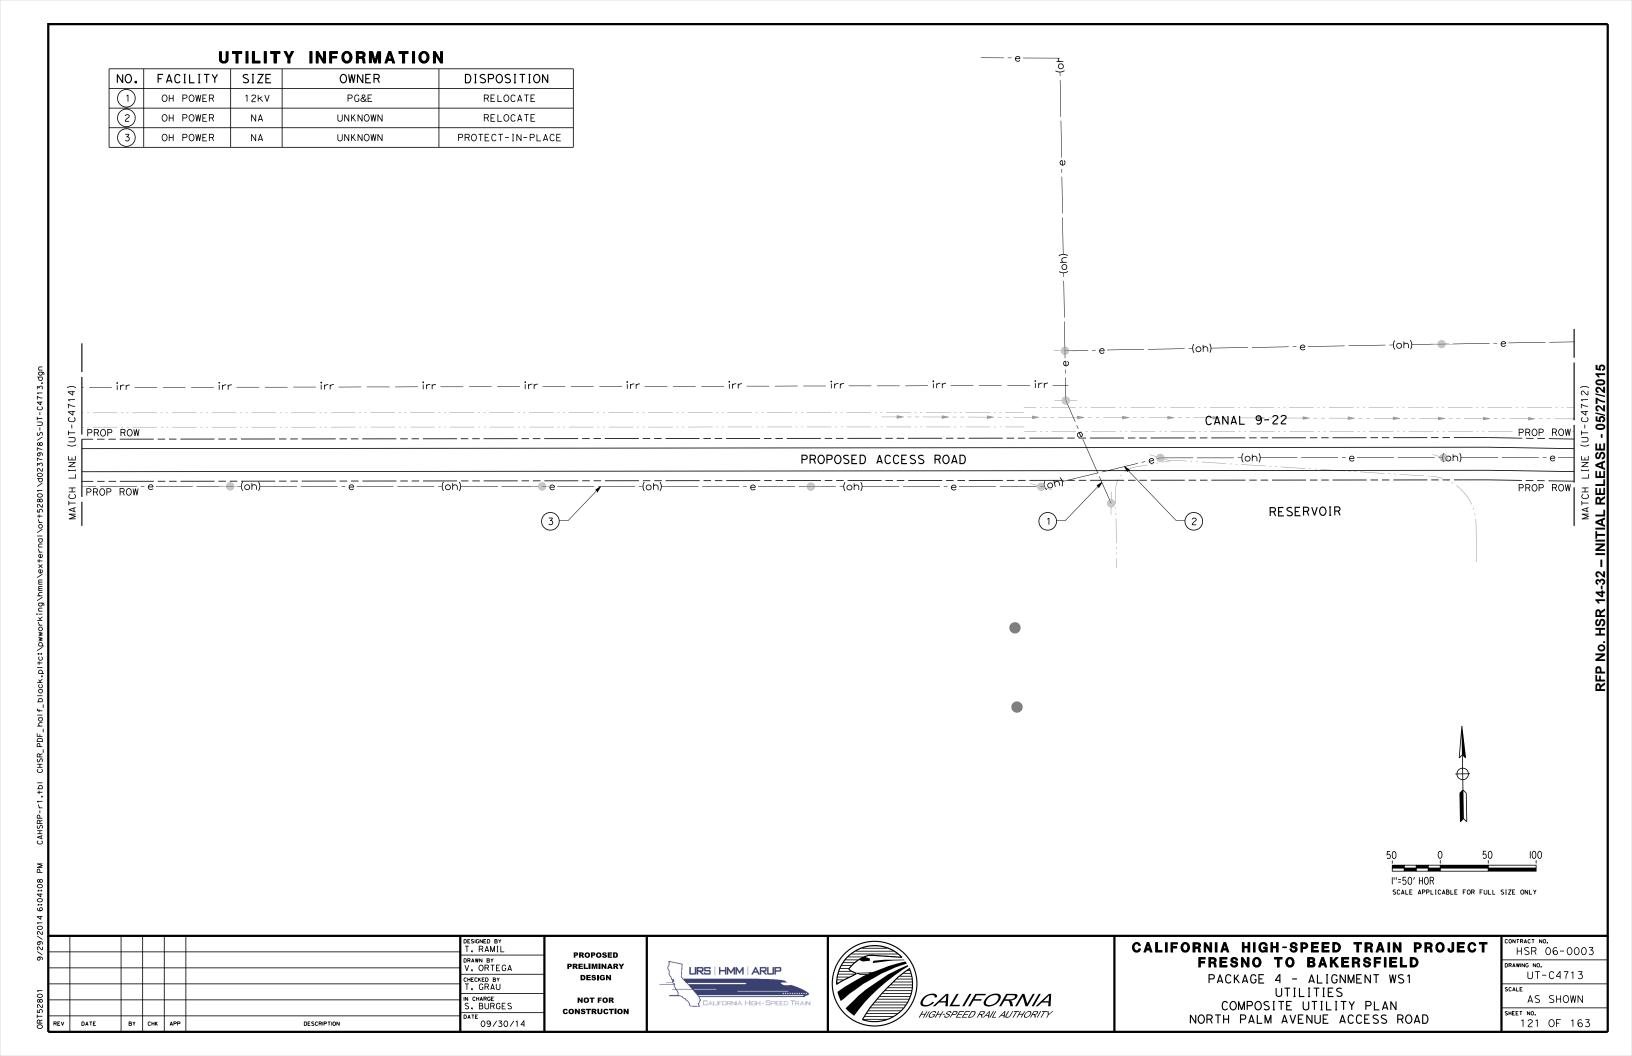

### UTILITY INFORMATION FACILITY SIZE NO. OWNER DISPOSITION OH POWER UNKNOWN PROTECT IN PLACE OH POWER NA RELOCATE UNKNOWN OH POWER UNKNOWN PROTECT IN PLACE GAS NA SEMPRA PROTECT IN PLACE AVE PROP ROW CANAL 9-22 PROP ROW 5 NORTH PALM PROPOSED ACCESS ROAD

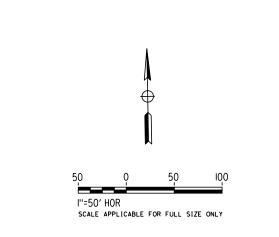

						DESIGNED BY T. RAMIL	Г
						DRAWN BY V. ORTEGA	
						CHECKED BY	
						IN CHARGE S. BURGES	
REV	DATE	BY	СНК	APP	DESCRIPTION	09/30/14	

PROPOSED
PRELIMINARY
DESIGN
NOT FOR

CONSTRUCTION








### CALIFORNIA HIGH-SPEED TRAIN PROJECT FRESNO TO BAKERSFIELD

PACKAGE 4 - ALIGNMENT WS1
UTILITIES
COMPOSITE UTILITY PLAN
NORTH PALM AVENUE ACCESS ROAD

CONTRACT NO.
HSR 06-0003
DRAWING NO.
UT-C4714
SCALE
AS SHOWN
SHEET NO.
122 OF 163

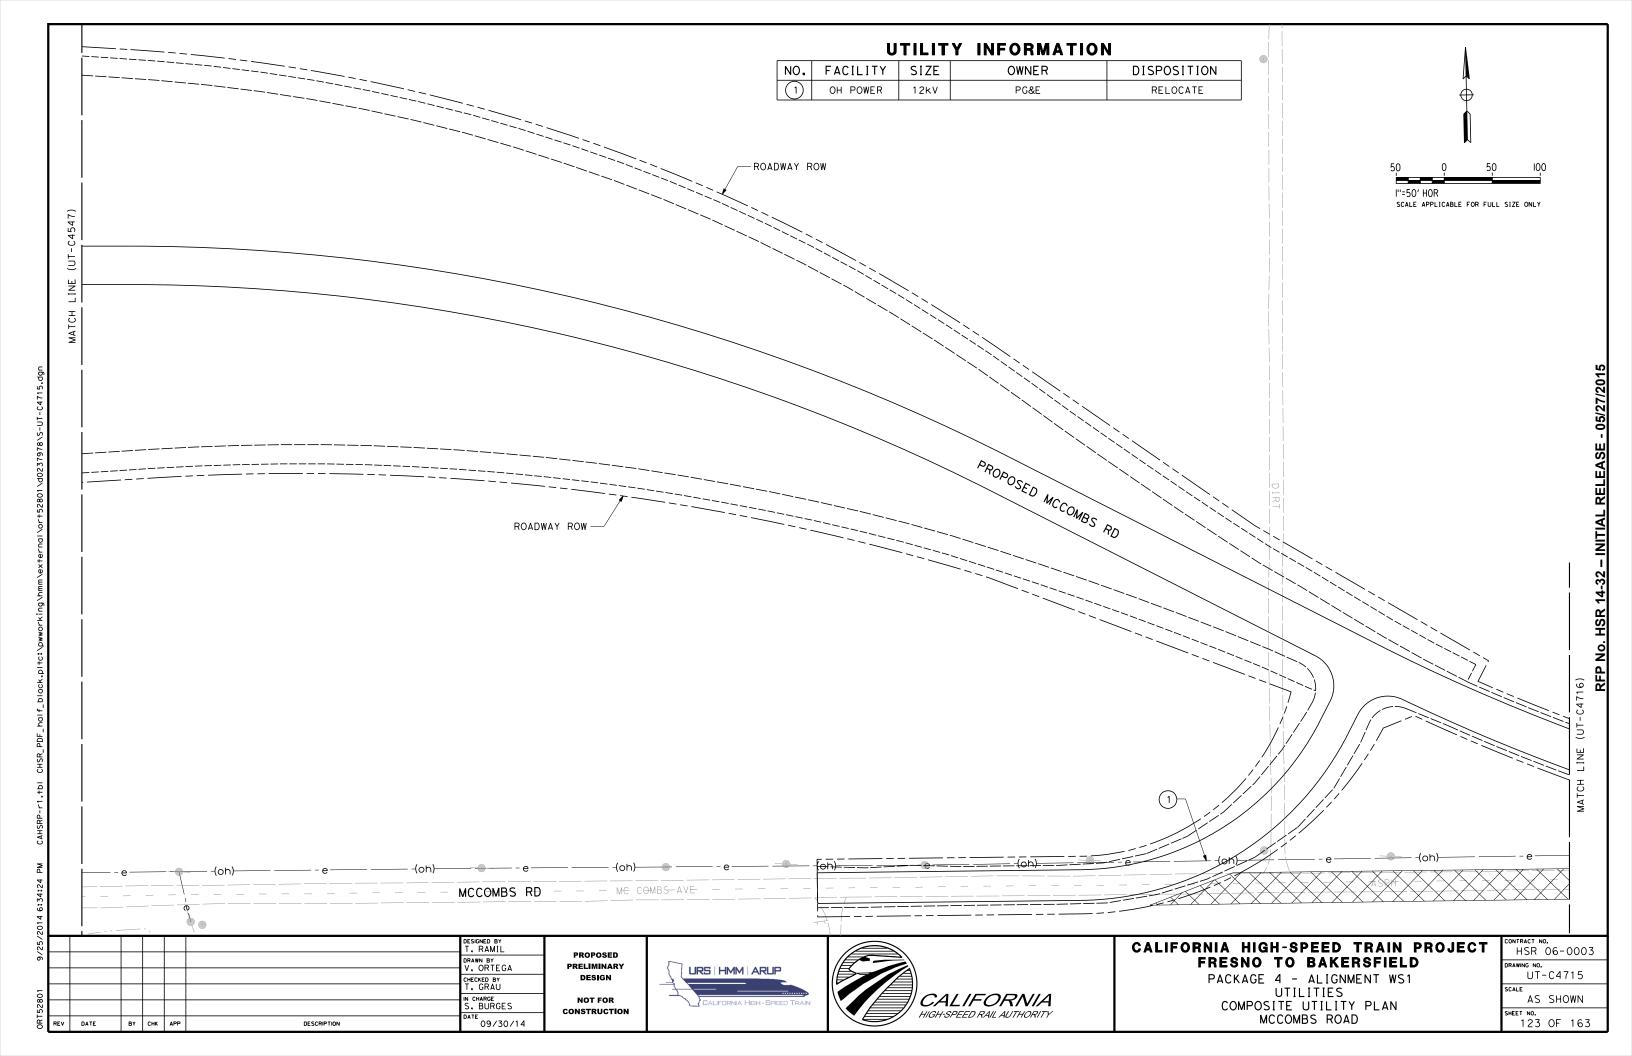

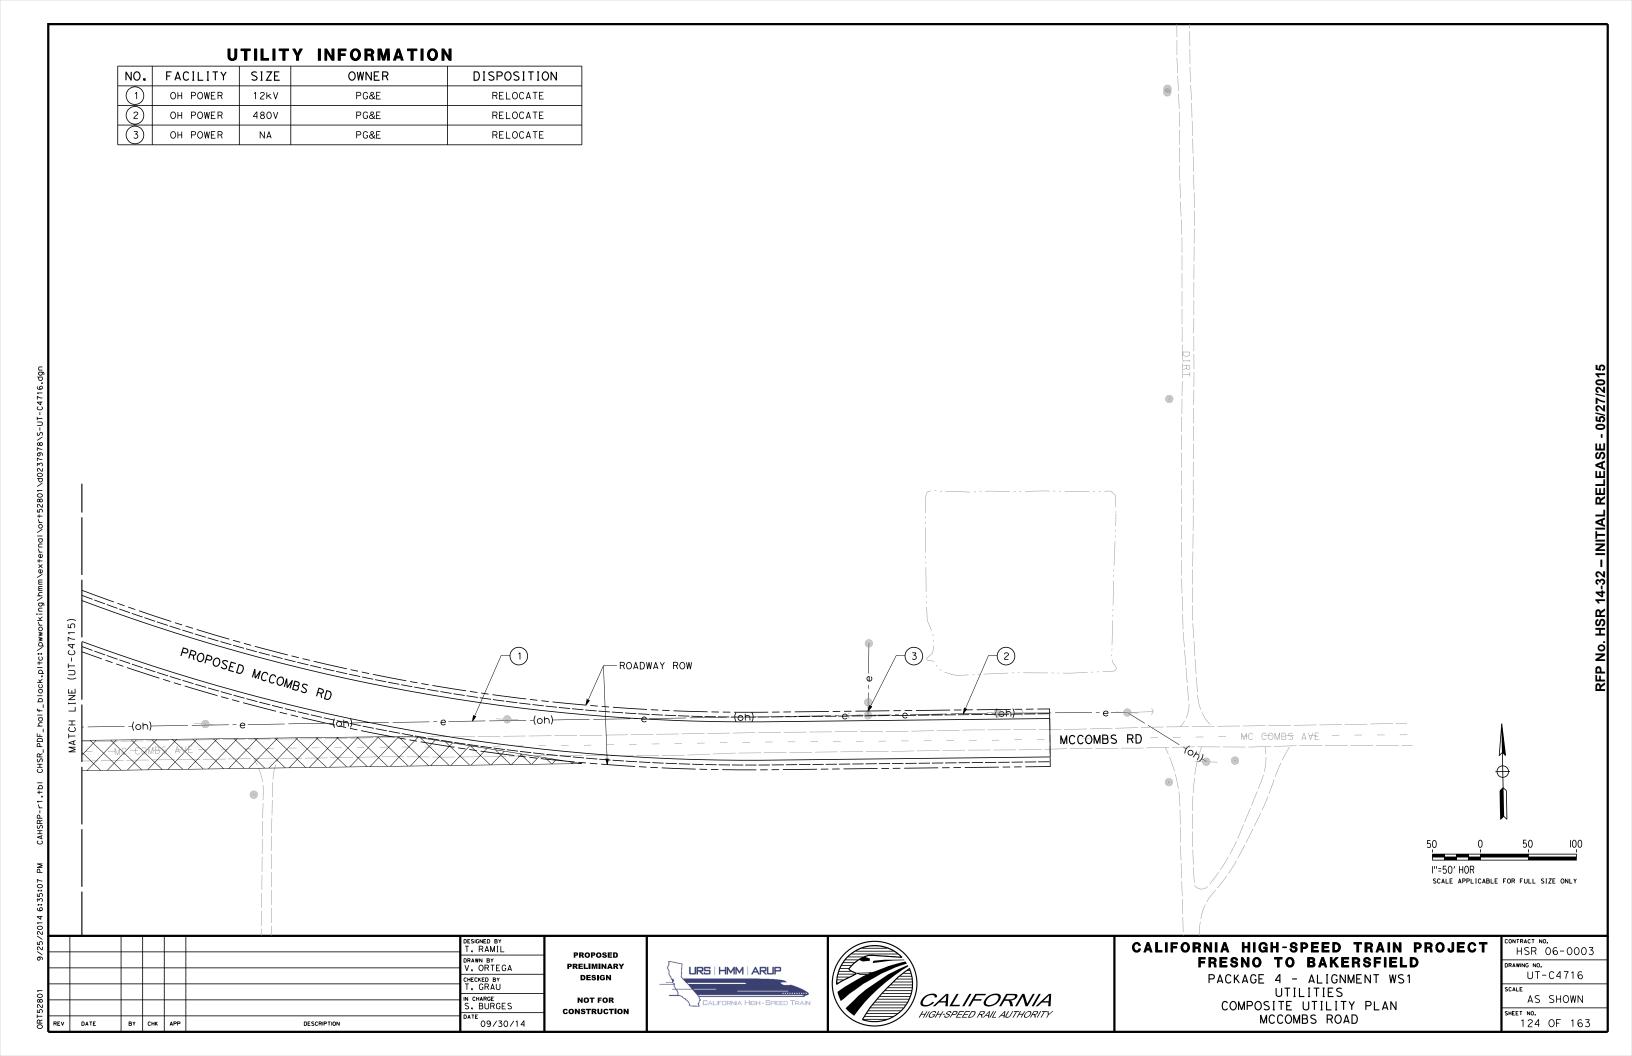


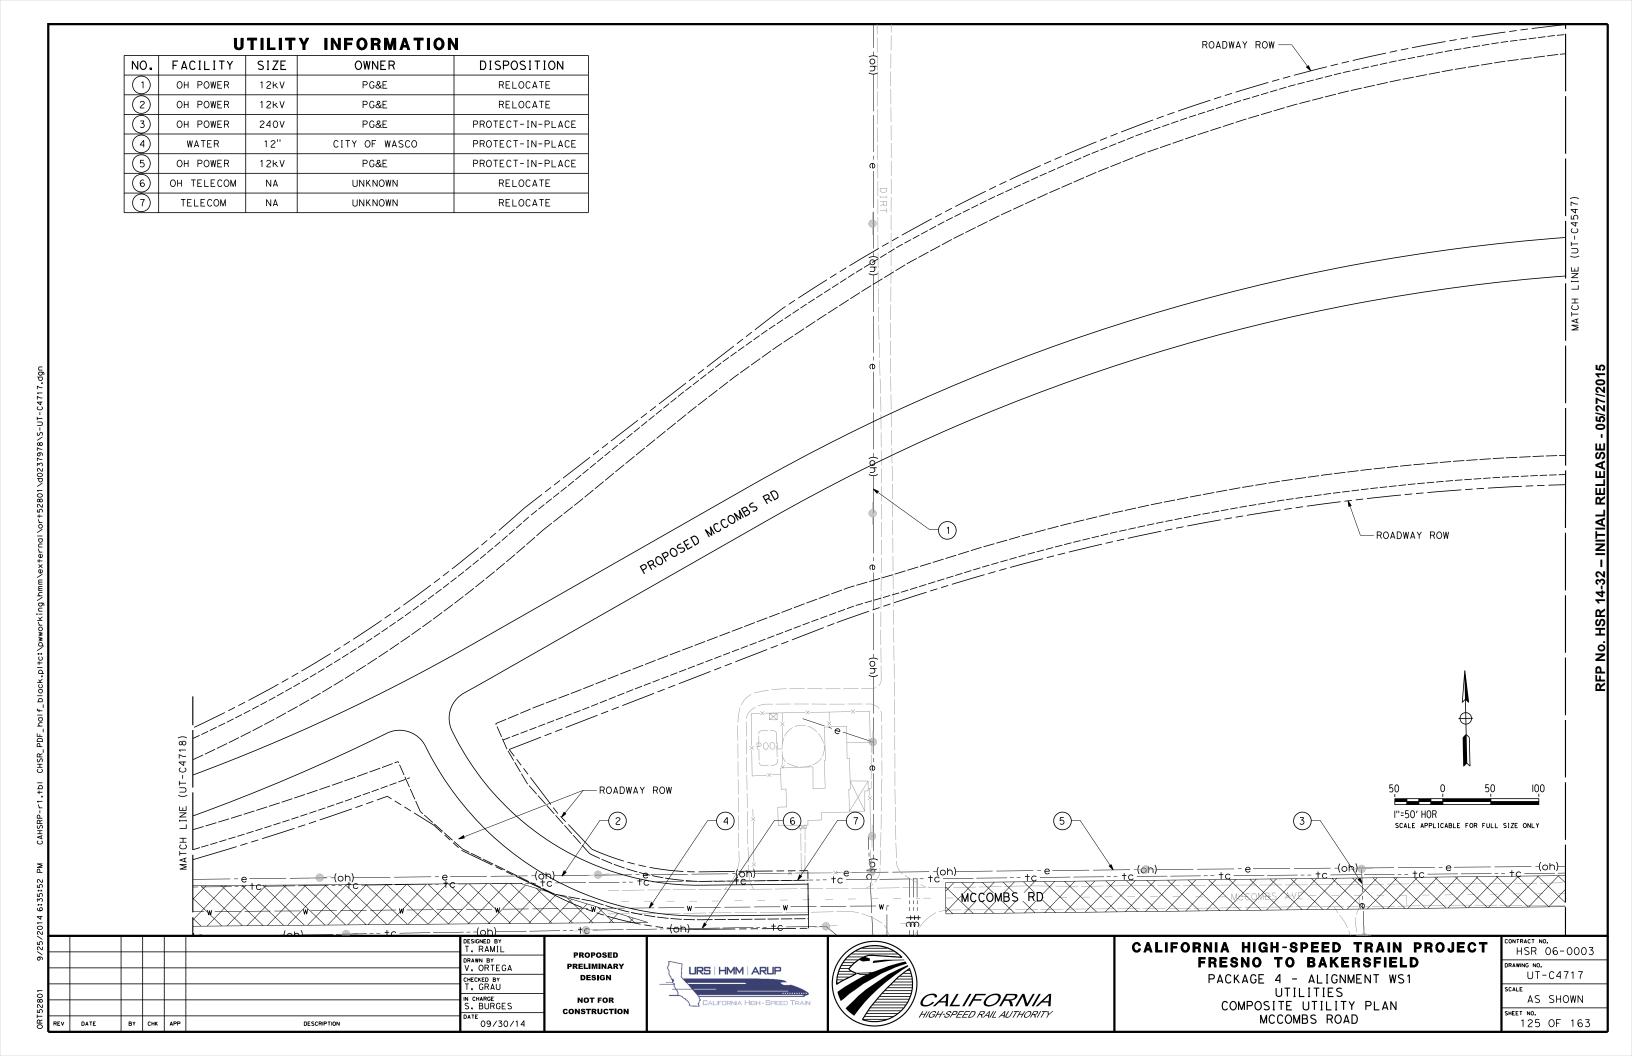

NO.	FACILITY	SIZE	OWNER	DISPOSITION
1	OH POWER	12kV	PG&E	RELOCATE
2	OH POWER	12kV	PG&E	RELOCATE
3	WATER	12"	CITY OF WASCO	PROTECT-IN-PLACE
4	OH TELECOM	NA	UNKNOWN	RELOCATE
5	TELECOM	NA	UNKNOWN	RELOCATE
6	OH POWER	NA	UNKNOWN	RELOCATE
7	OH TELECOM	NA	UNKNOWN	RELOCATE

MCCOMBS ROAD

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SCALE APPLICABLE FOR FULL SIZE ONLY

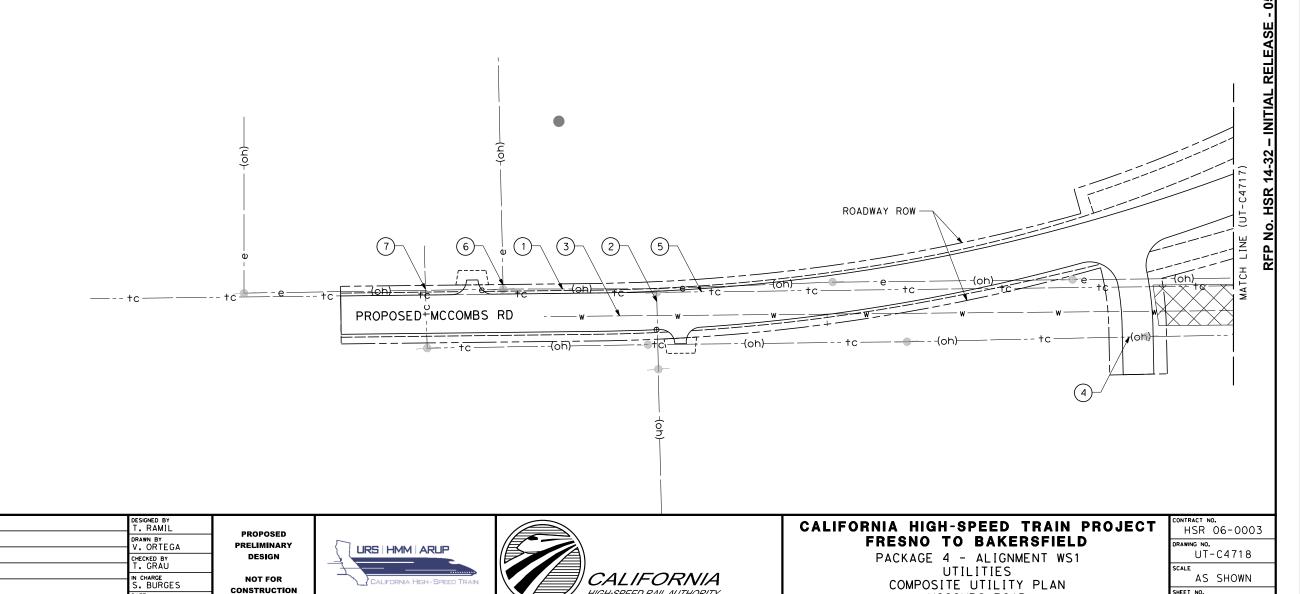
BY CHK APP


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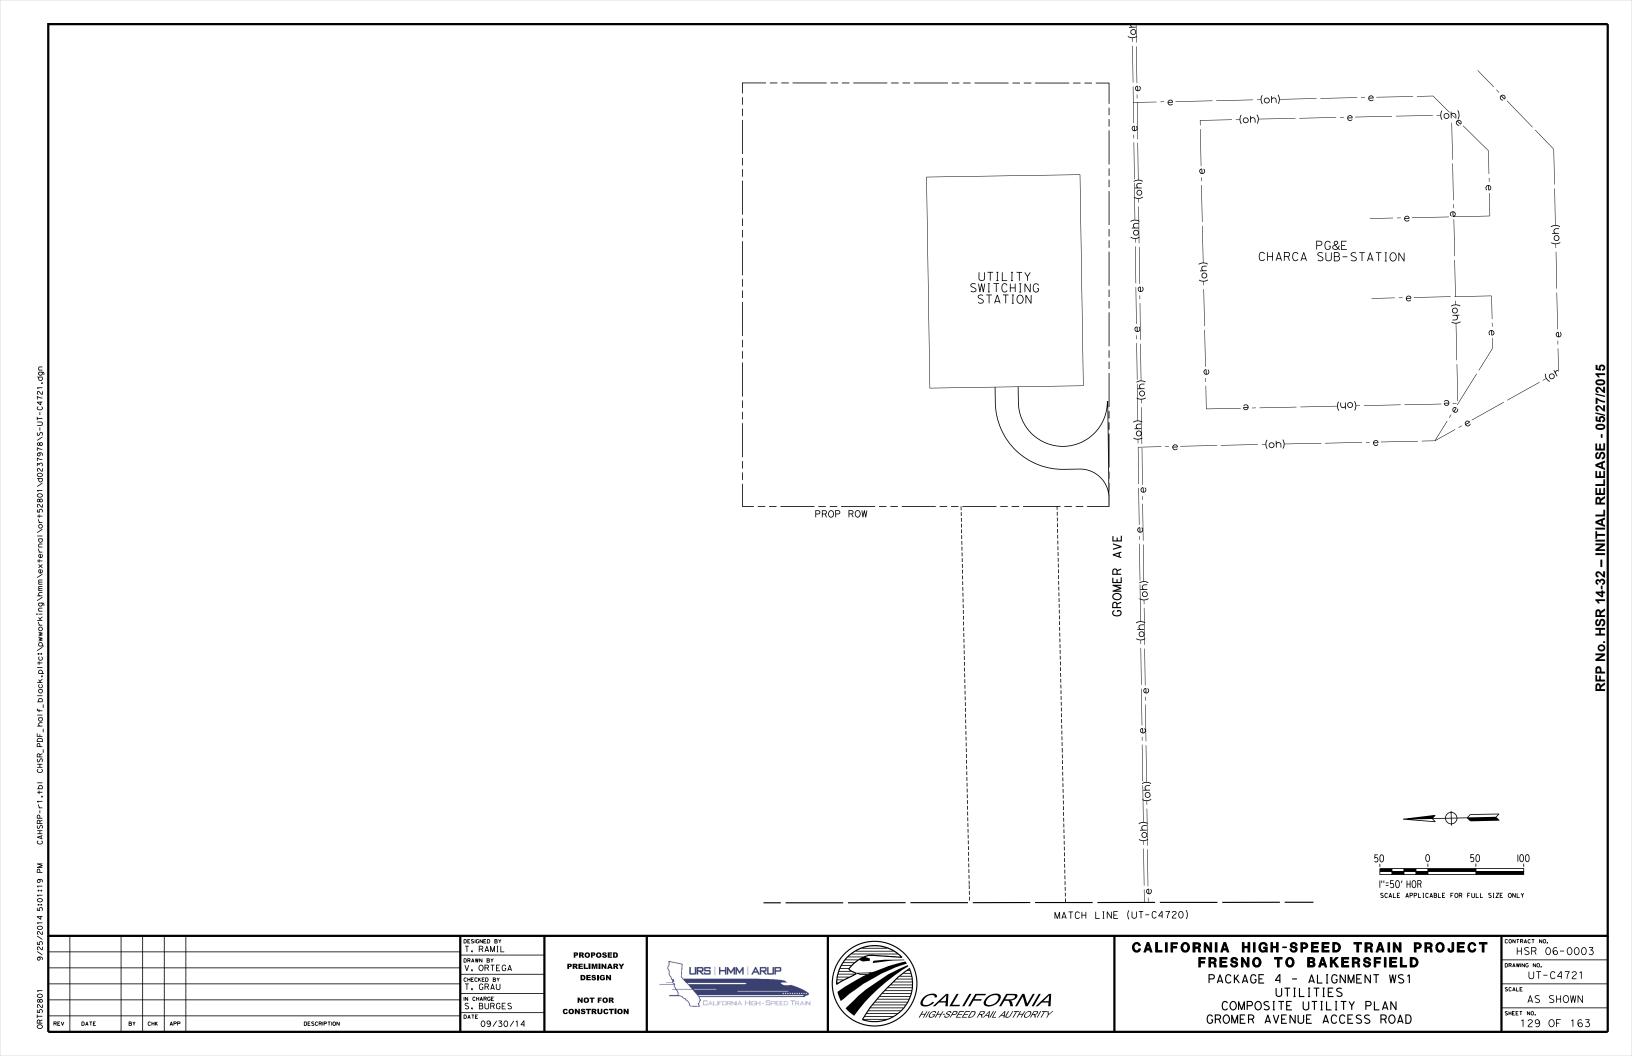
N CHARGE S. BURGES

09/30/14

NOT FOR CONSTRUCTION



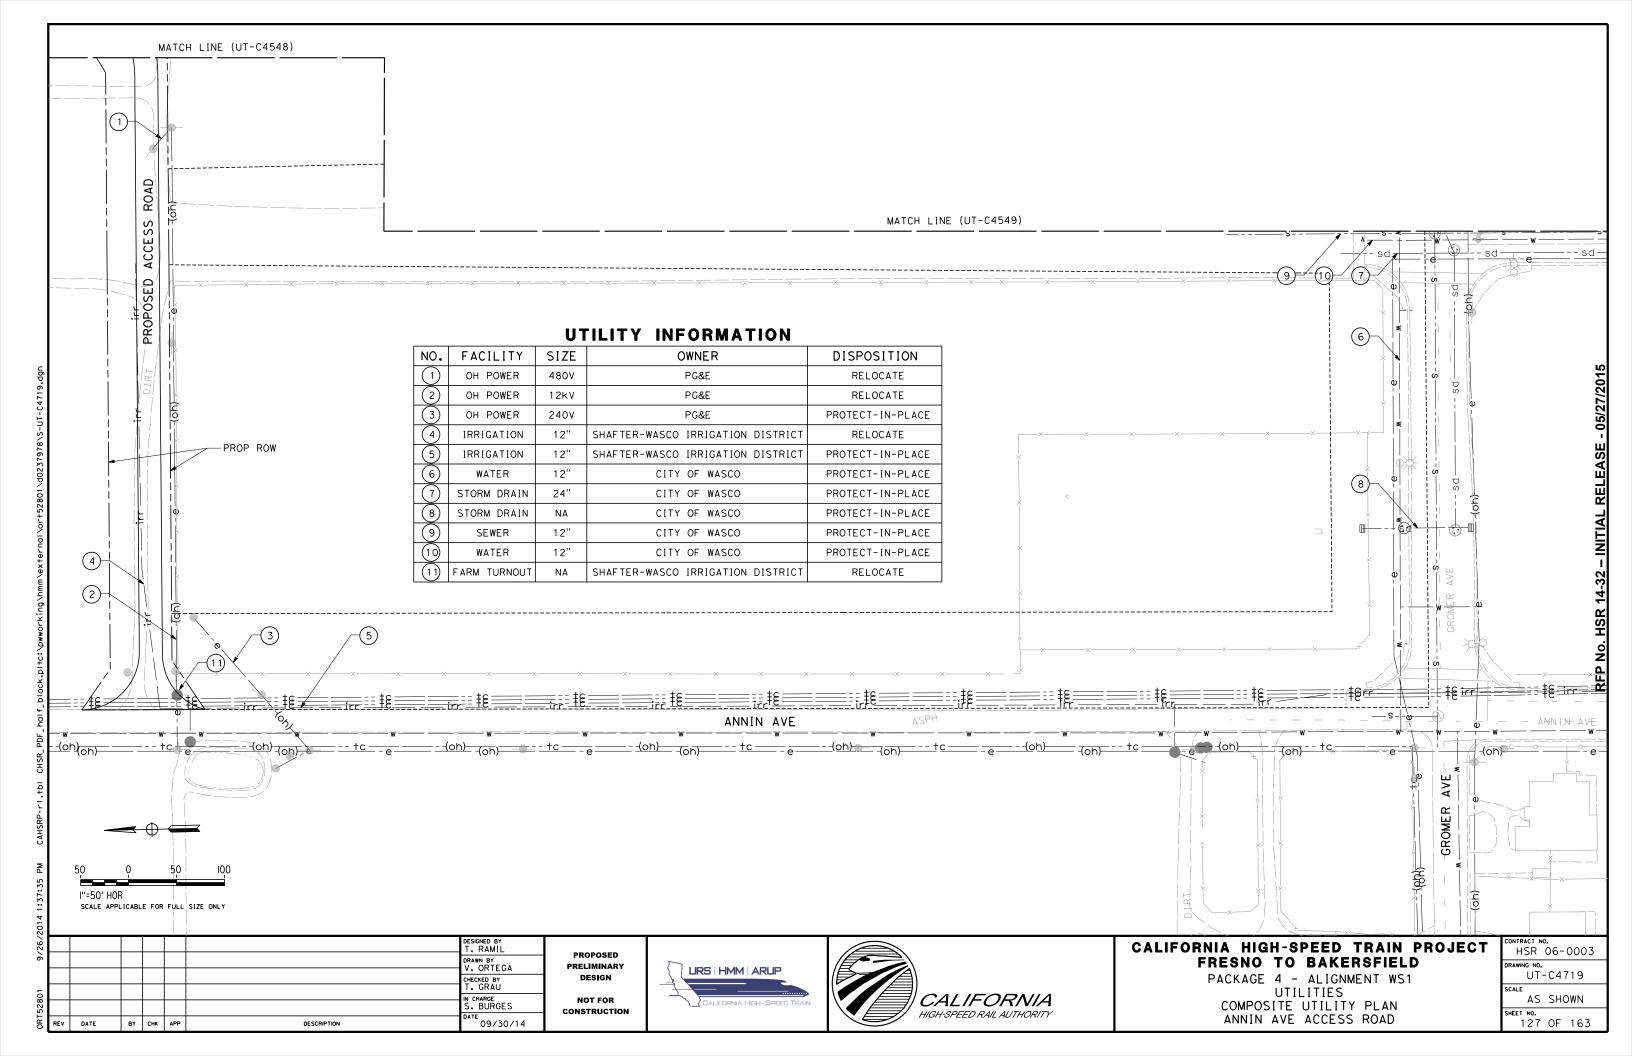

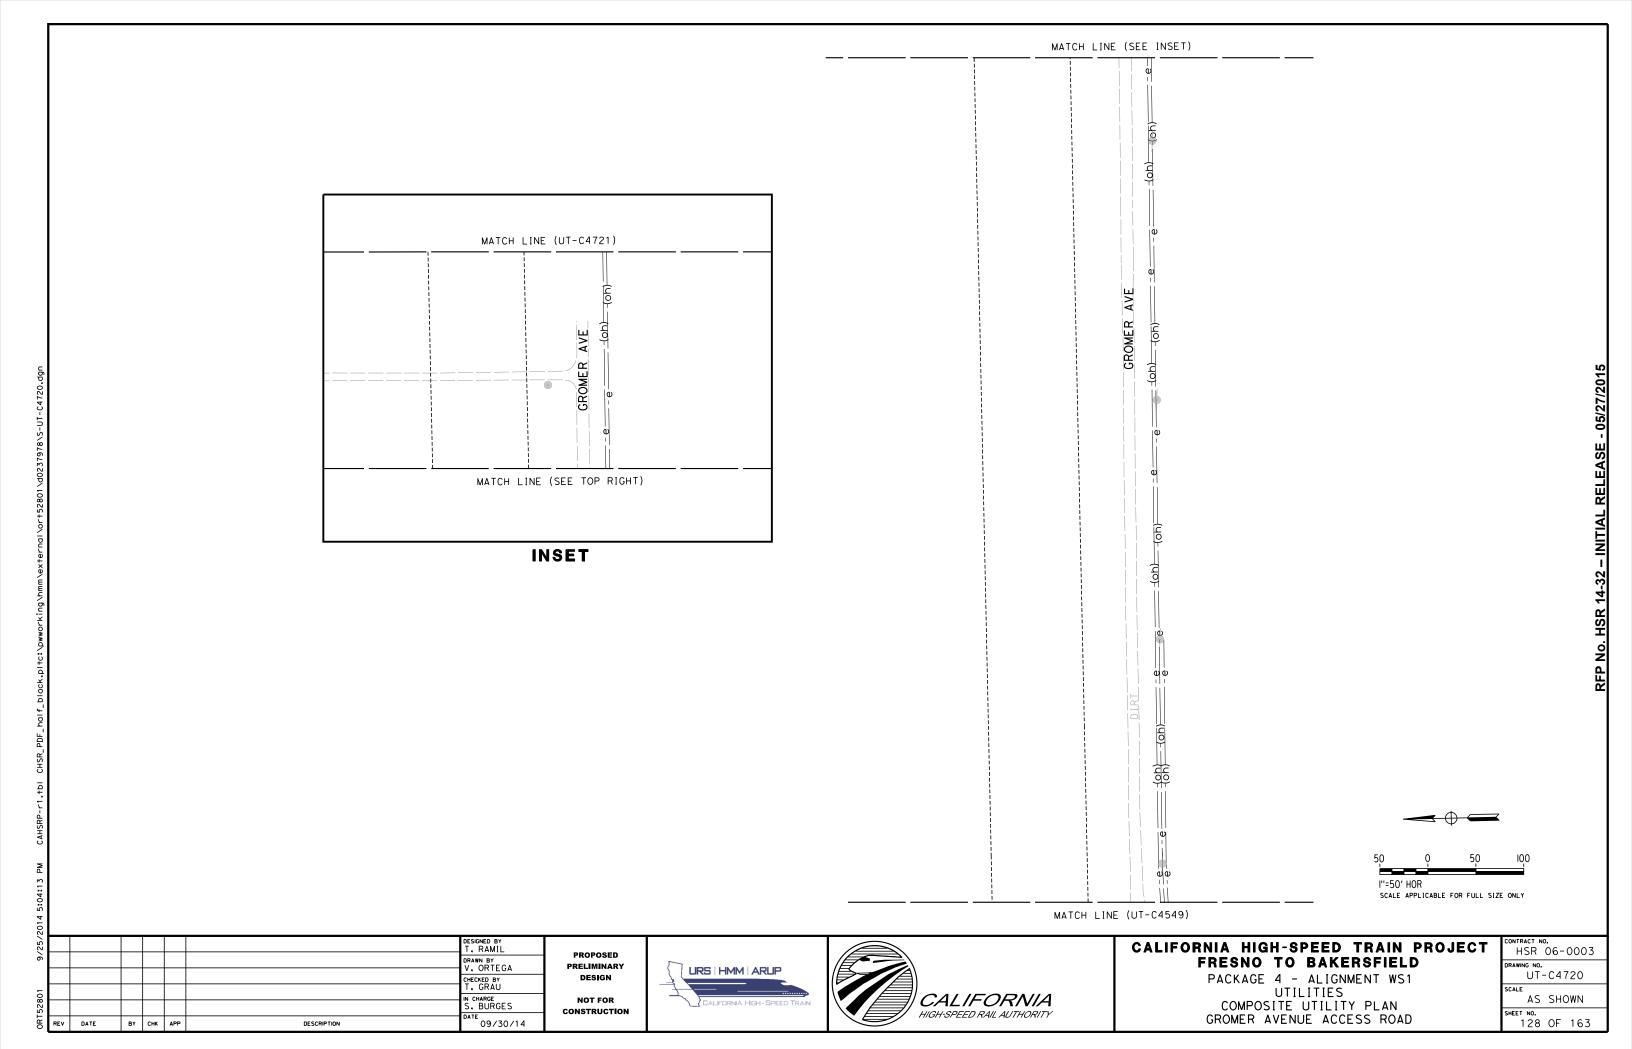

### **UTILITY INFORMATION** SIZE NO. FACILITY OWNER DISPOSITION GAS SEMPRA RELOCATE (2) IRRIGATION 66" SHAFTER-WASCO IRRIGATION DISTRICT RELOCATE PG&E OH POWER 12kV RELOCATE OH POWER PG&E RELOCATE 12kV OH POWER 12kV PG&E RELOCATE TELECOM AT&T RELOCATE NΑ ROADWAY ROW SCALE APPLICABLE FOR FULL SIZE ONLY MATCH LINE (UT-C4561) DESIGNED BY ONTRACT NO. HSR 06-0003 CALIFORNIA HIGH-SPEED TRAIN PROJECT PROPOSED DRAWN BY V. ORTEGA FRESNO TO BAKERSFIELD UT-C4722 PRELIMINARY URS | HMM | ARUP DESIGN PACKAGE 4 - ALIGNMENT WS1 CHECKED BY

N CHARGE S. BURGES

DATE

BY CHK APP

DESCRIPTION

09/30/14

NOT FOR

CONSTRUCTION

CALIFORNIA


UTILITIES

COMPOSITE UTILITY PLAN

KIMBERLINA ROAD

AS SHOWN

130 OF 163

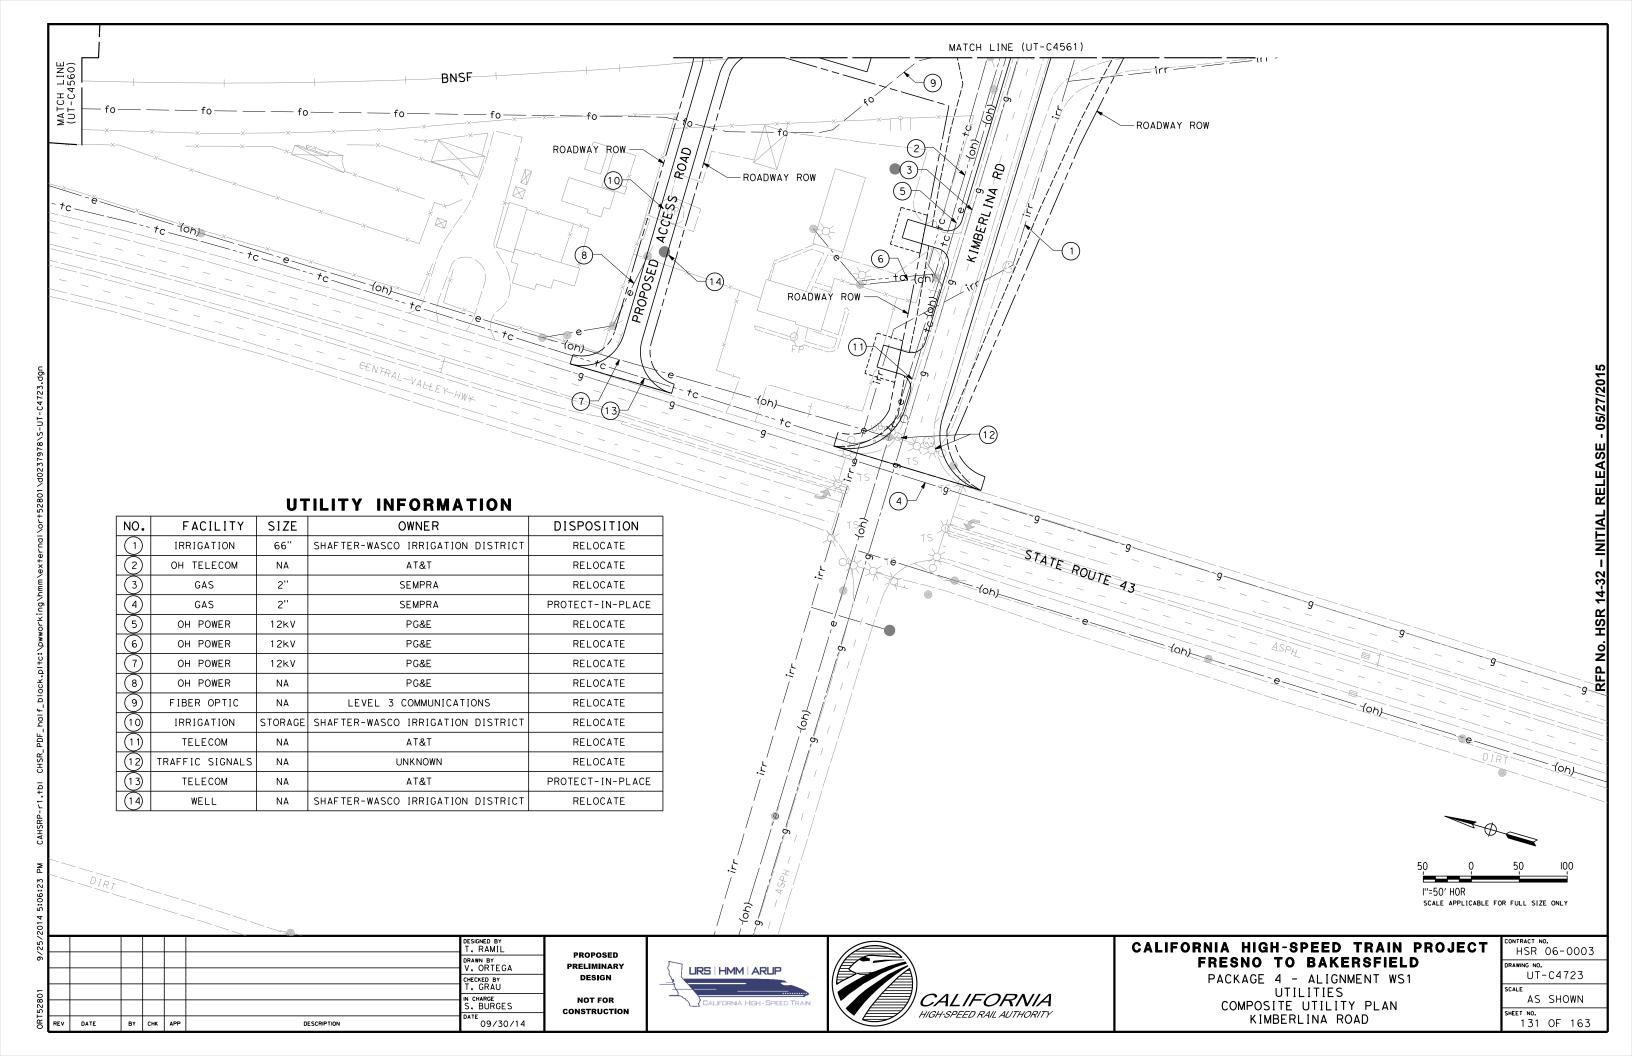

NO.	FACILITY	SIZE	OWNER	DISPOSITION
(1)	OH POWER	12kV	PG&E	RELOCATE

PACKAGE 4 - ALIGNMENT WS1

UTILITIES


COMPOSITE UTILITY PLAN

DRESSER AVENUE ACCESS ROAD

UT-C4724

AS SHOWN

132 OF 163

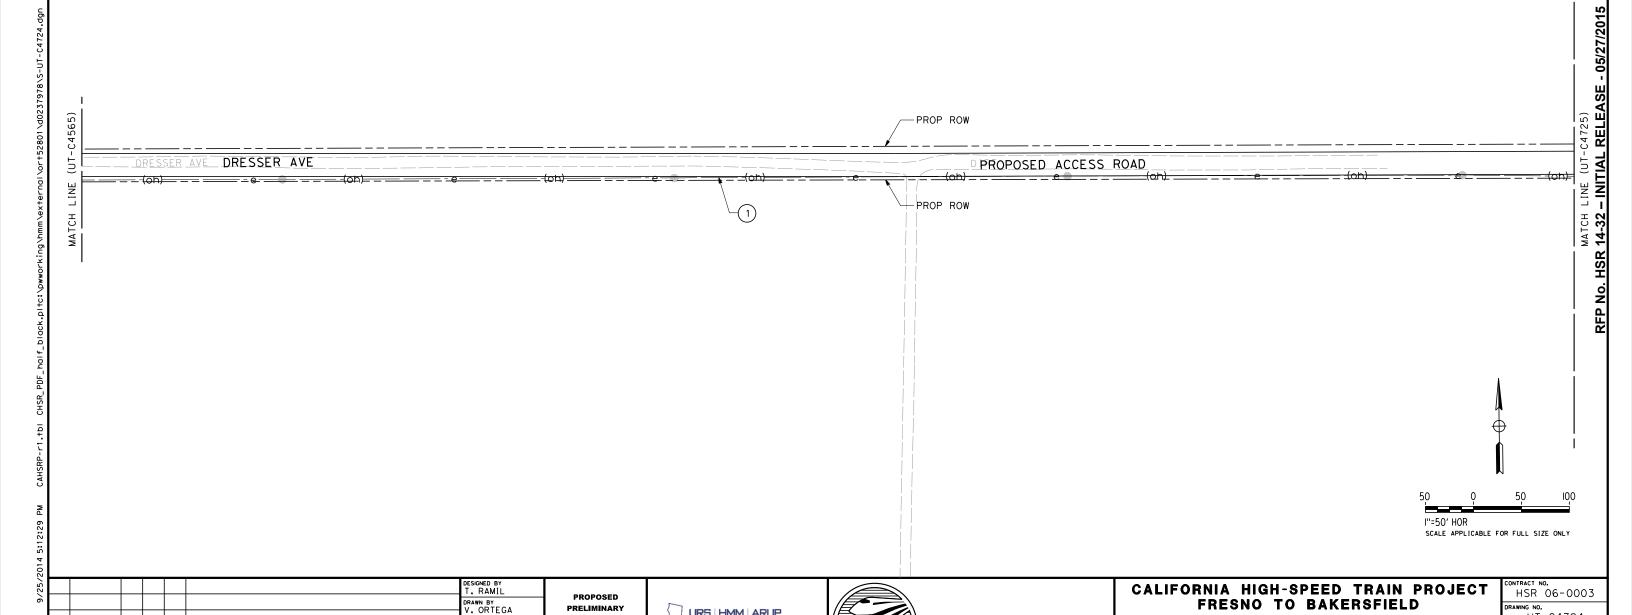

CALIFORNIA

HIGH-SPEED RAIL AUTHORITY

URS | HMM | ARUP

DESIGN

NOT FOR

CONSTRUCTION

CHECKED BY


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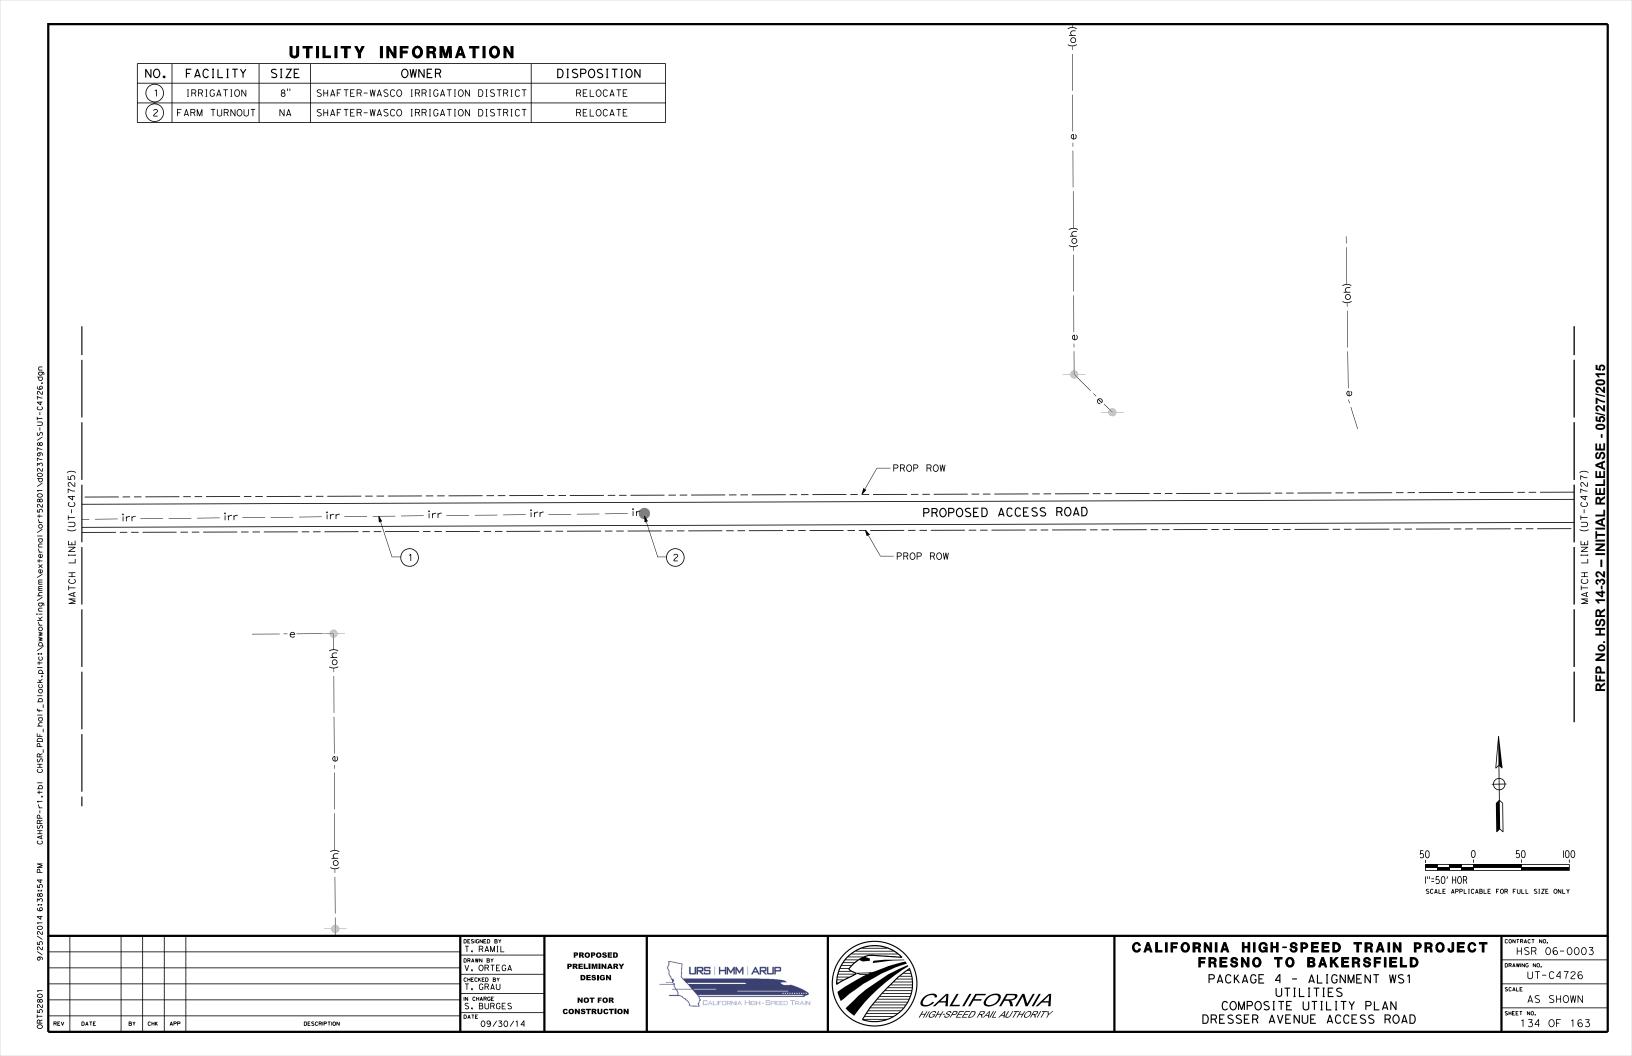
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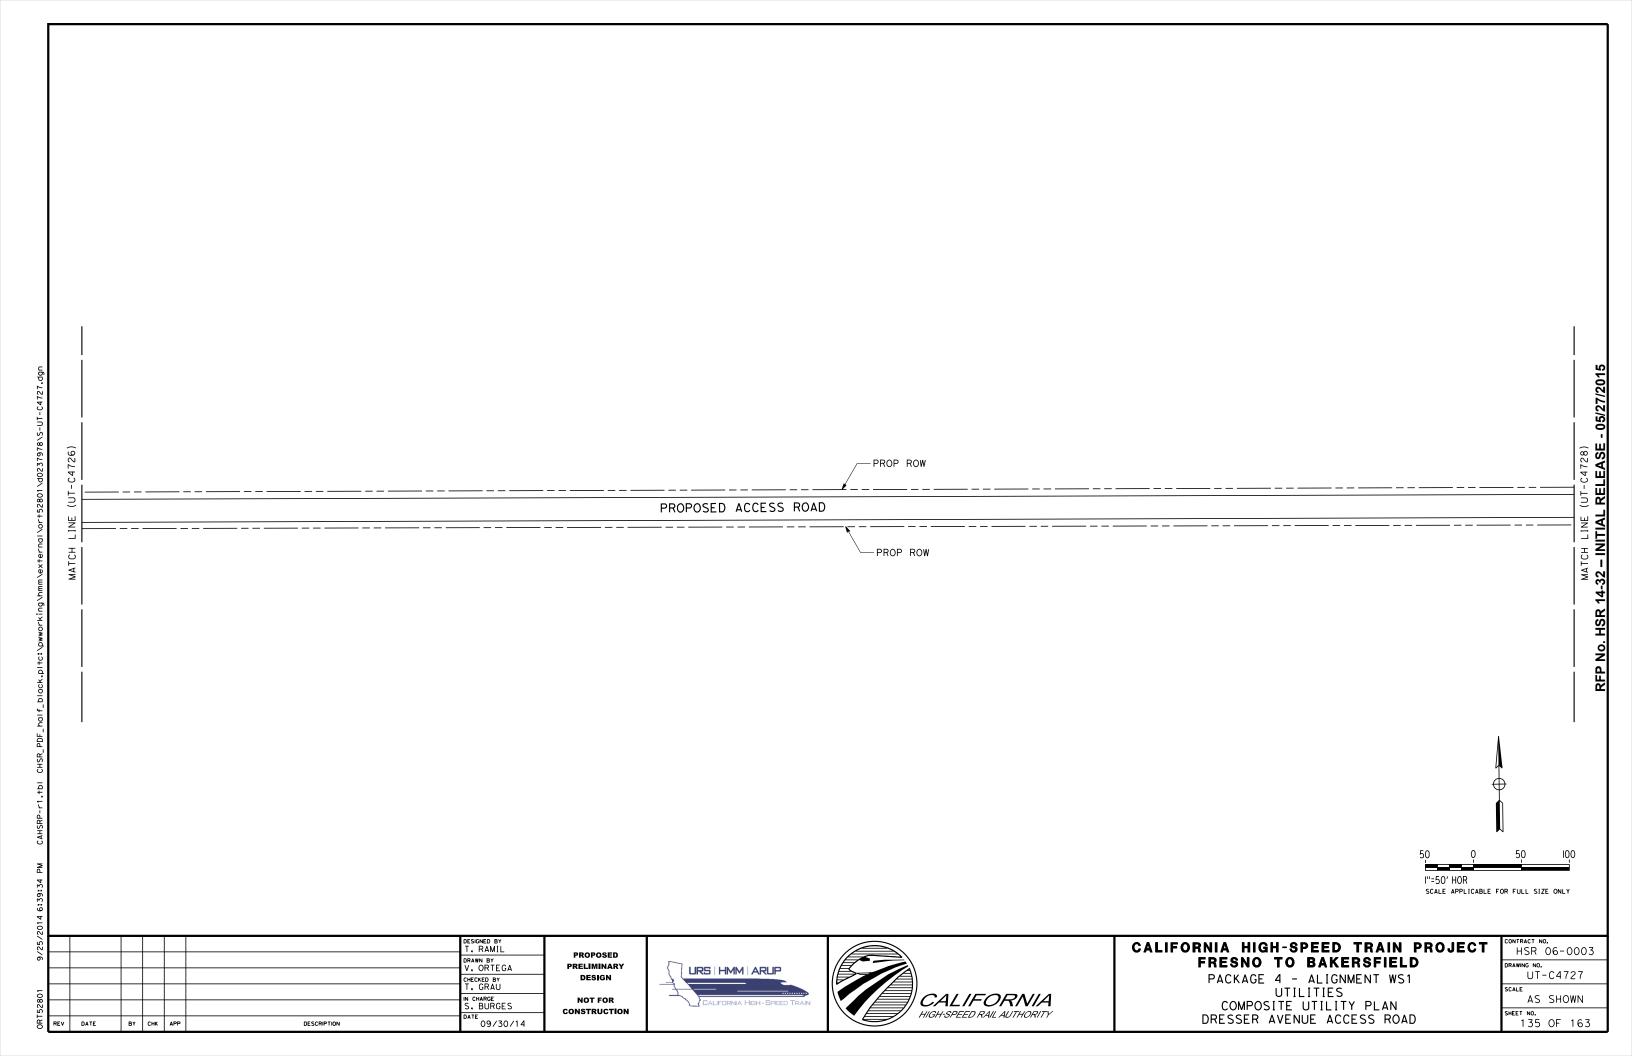
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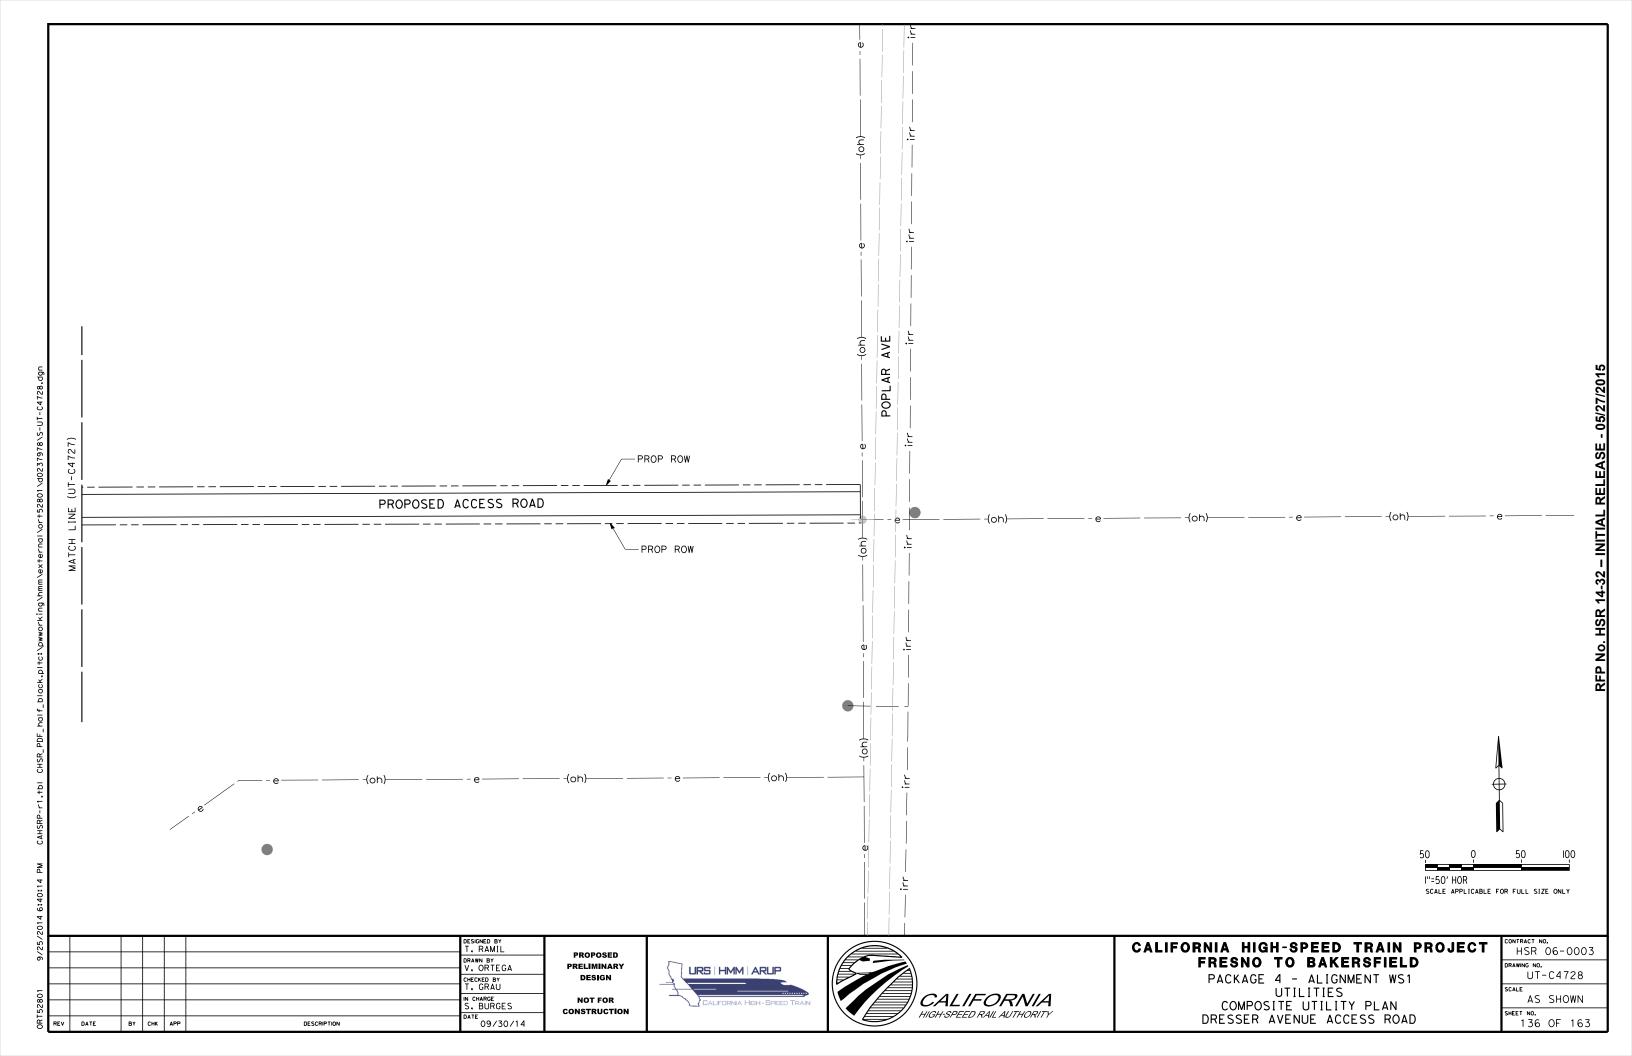
N CHARGE S. BURGES


09/30/14










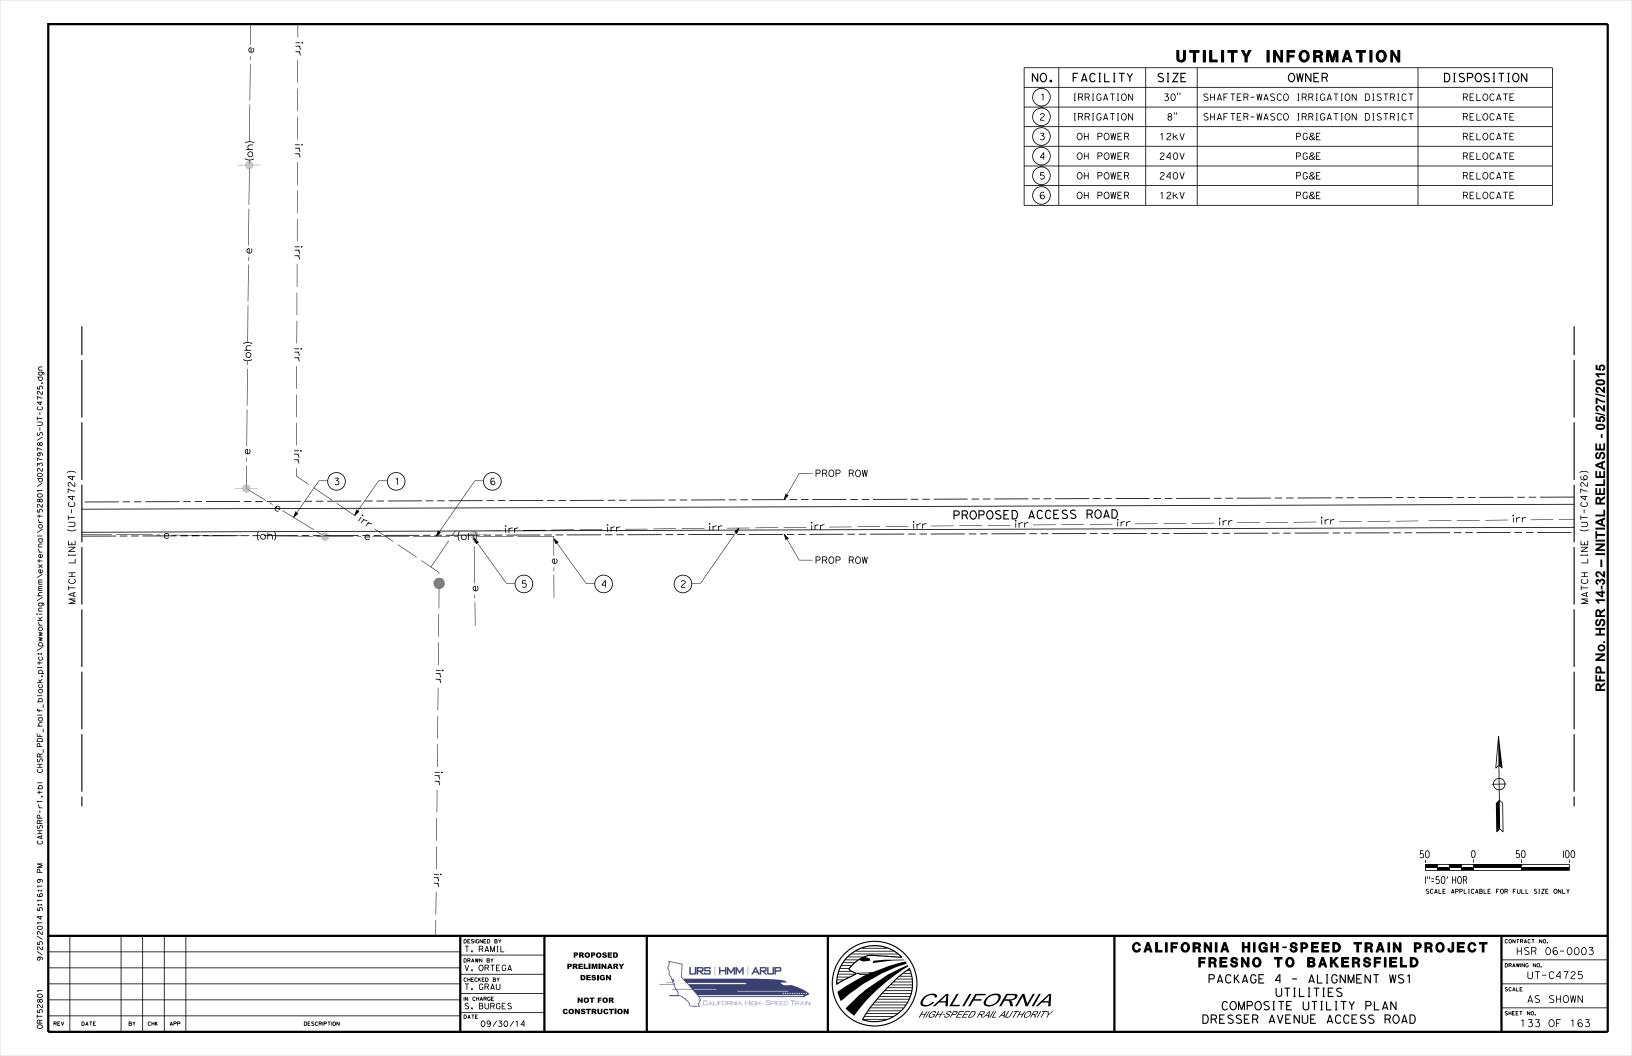


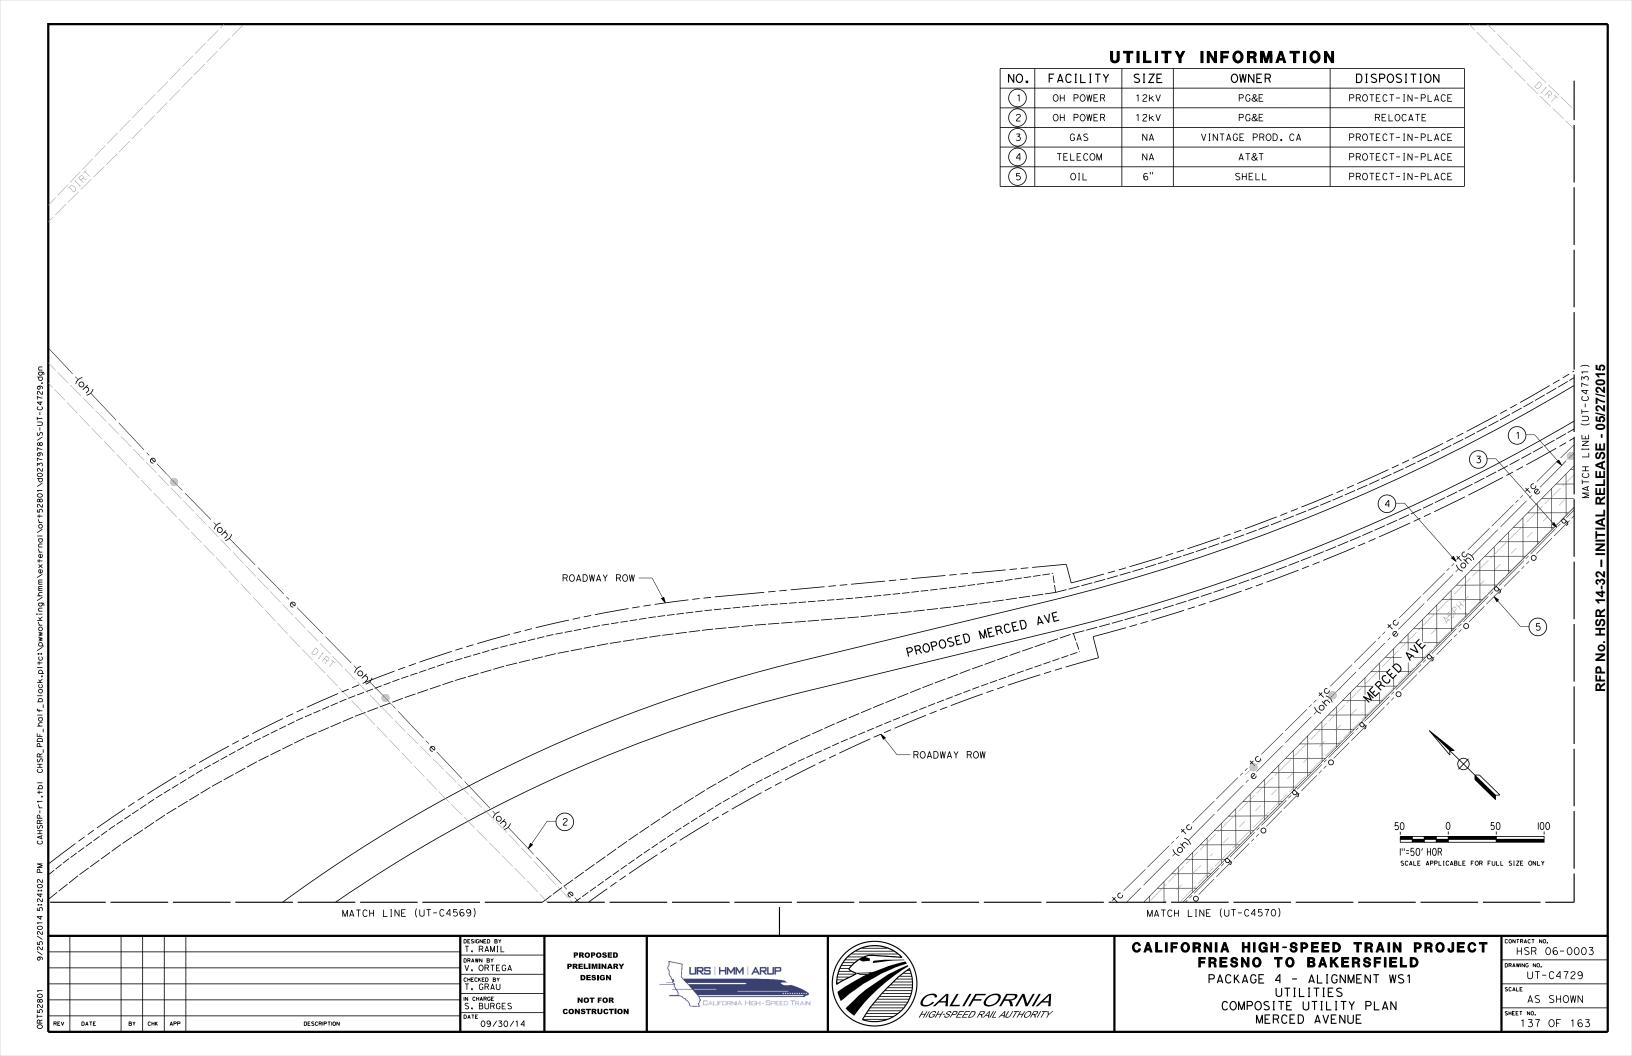


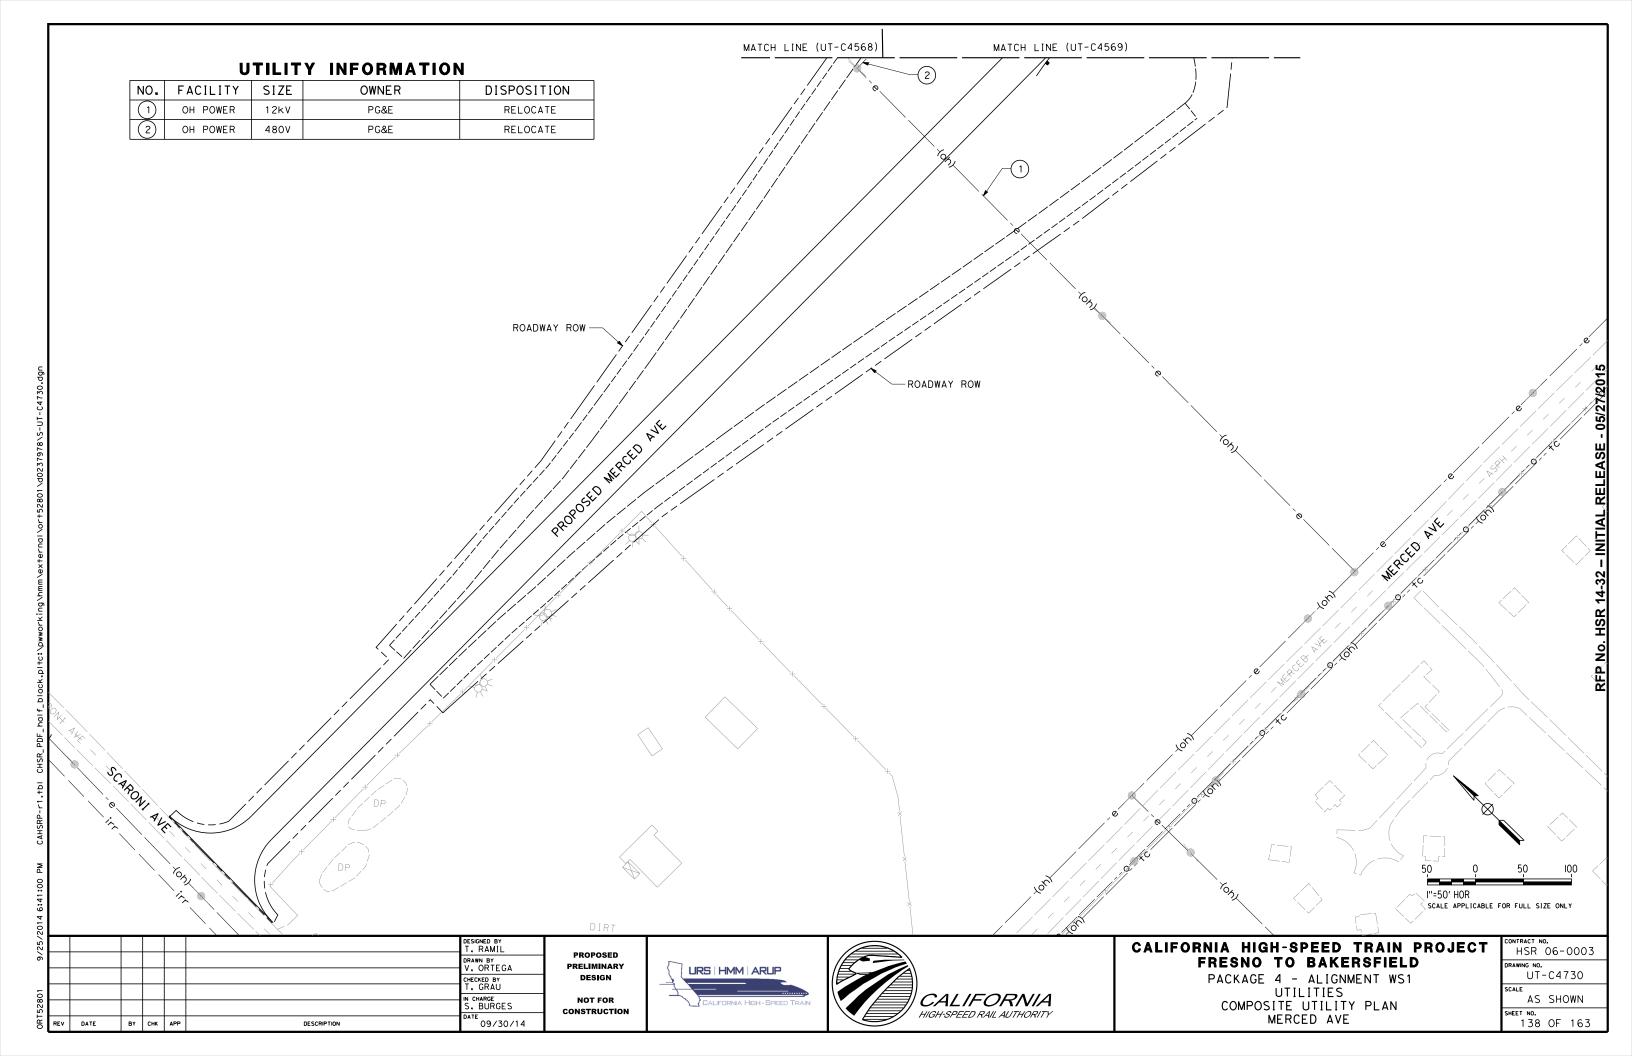


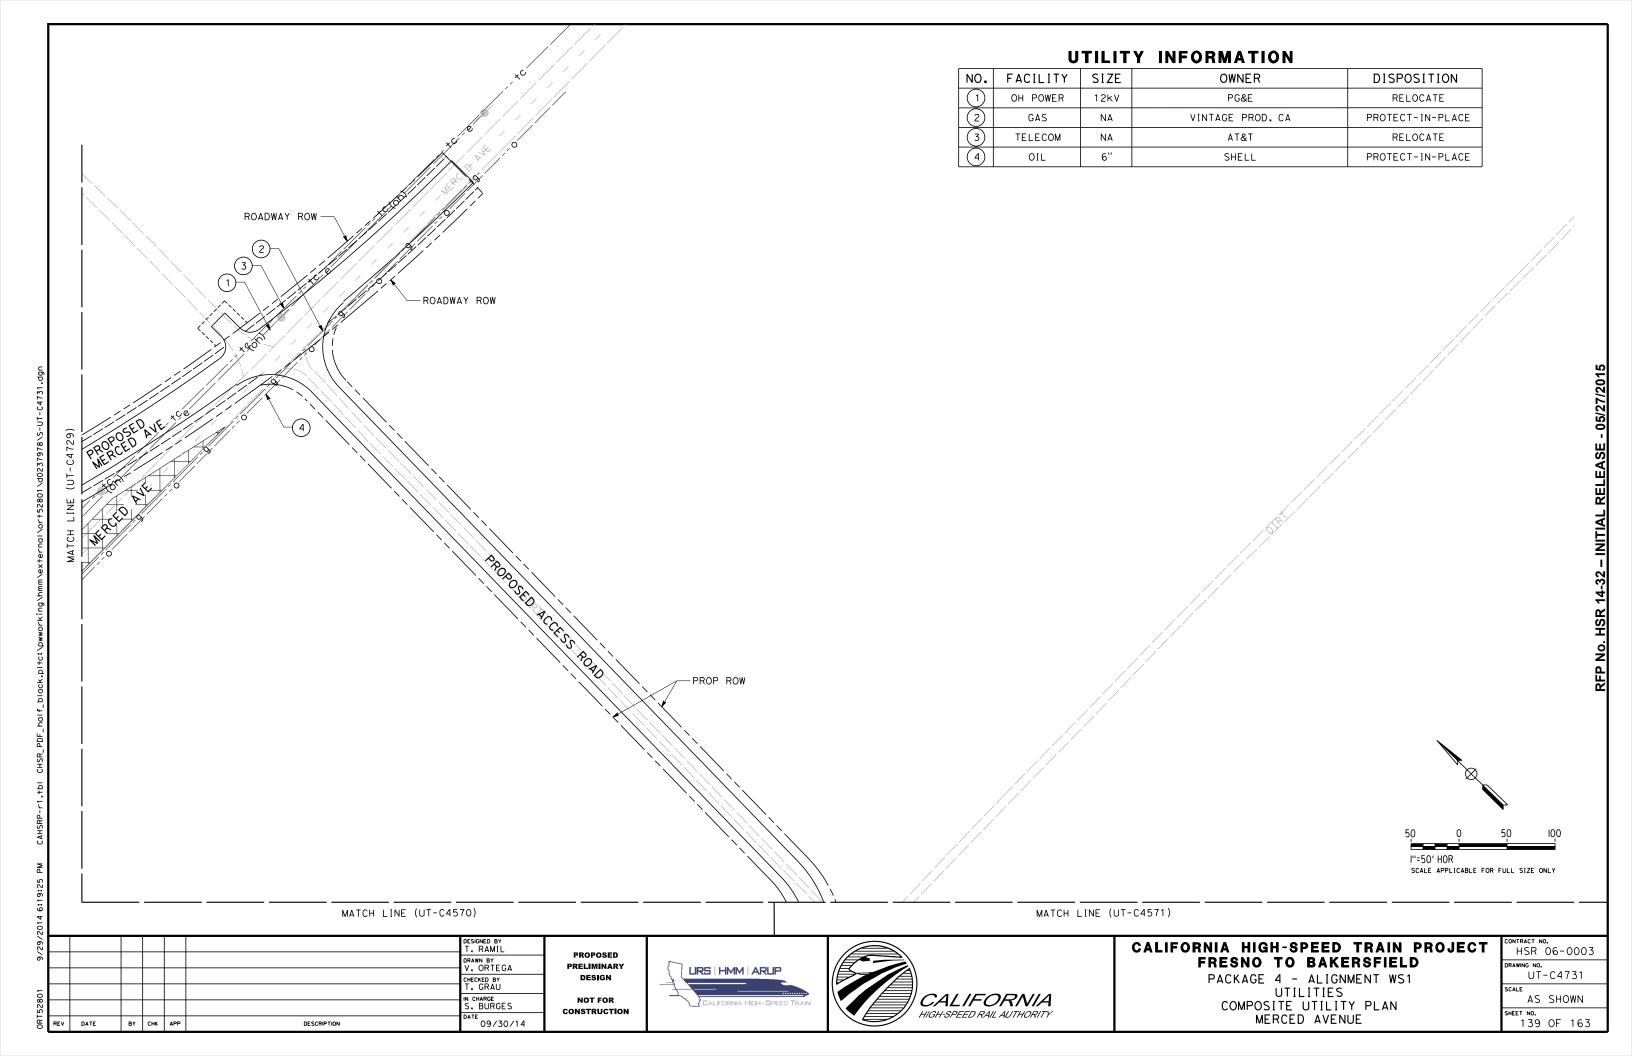


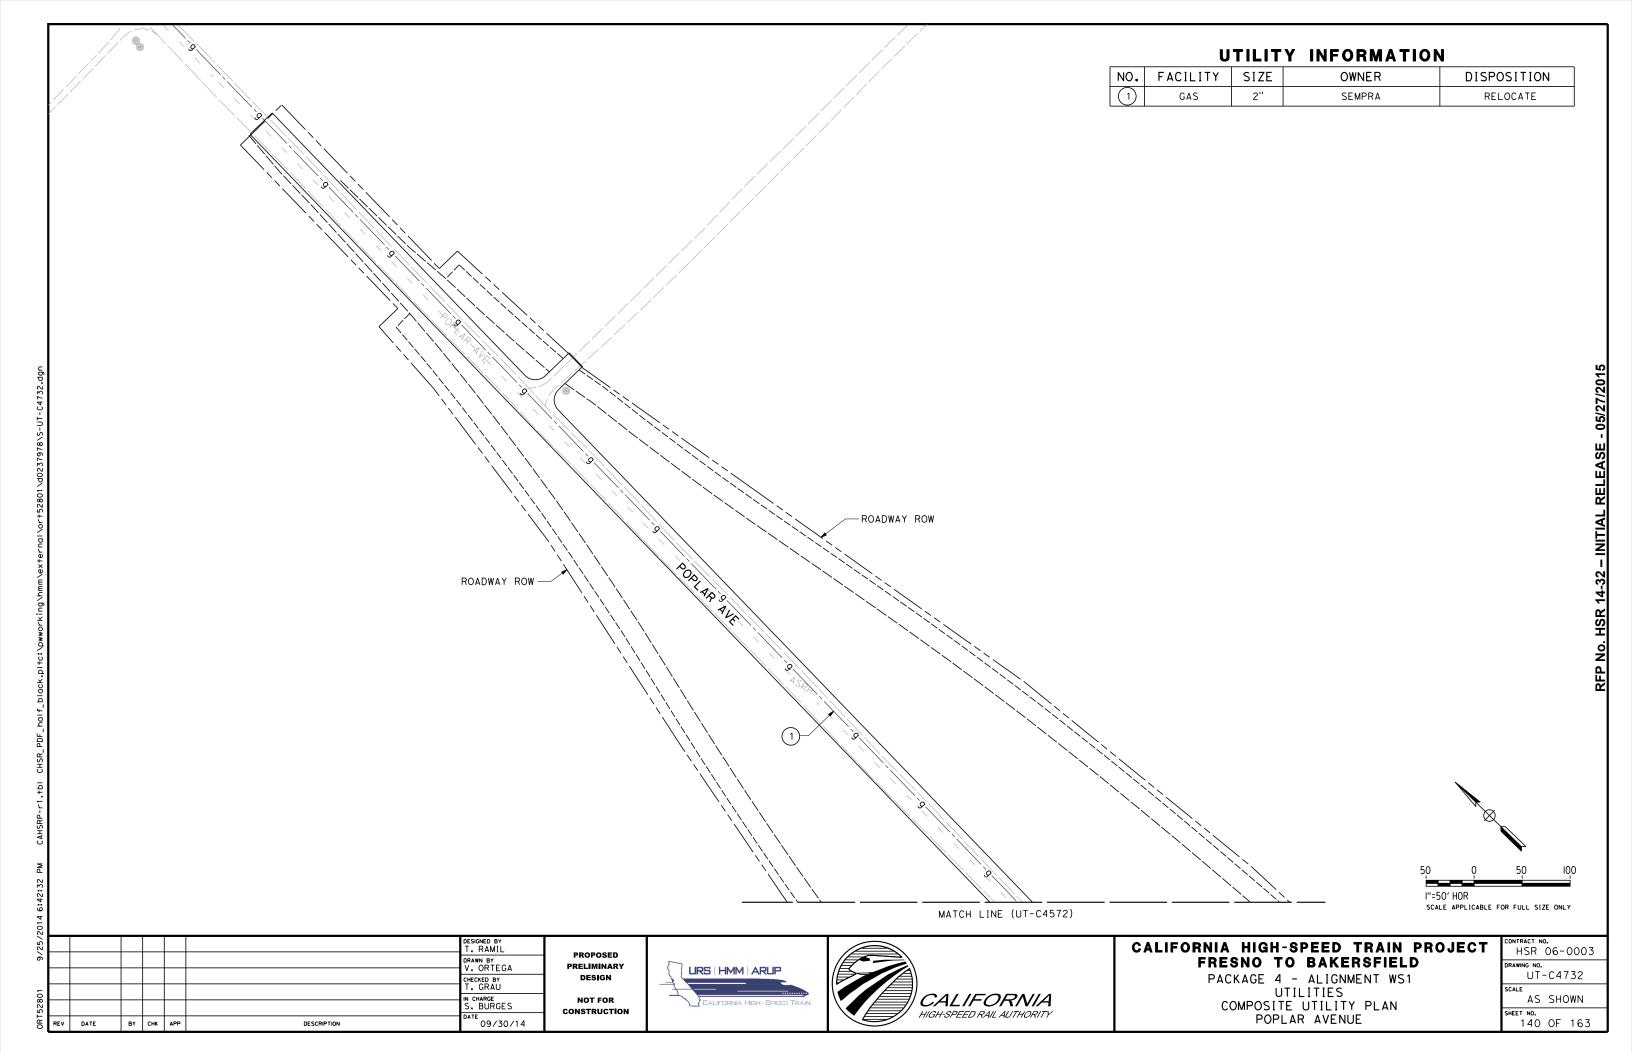


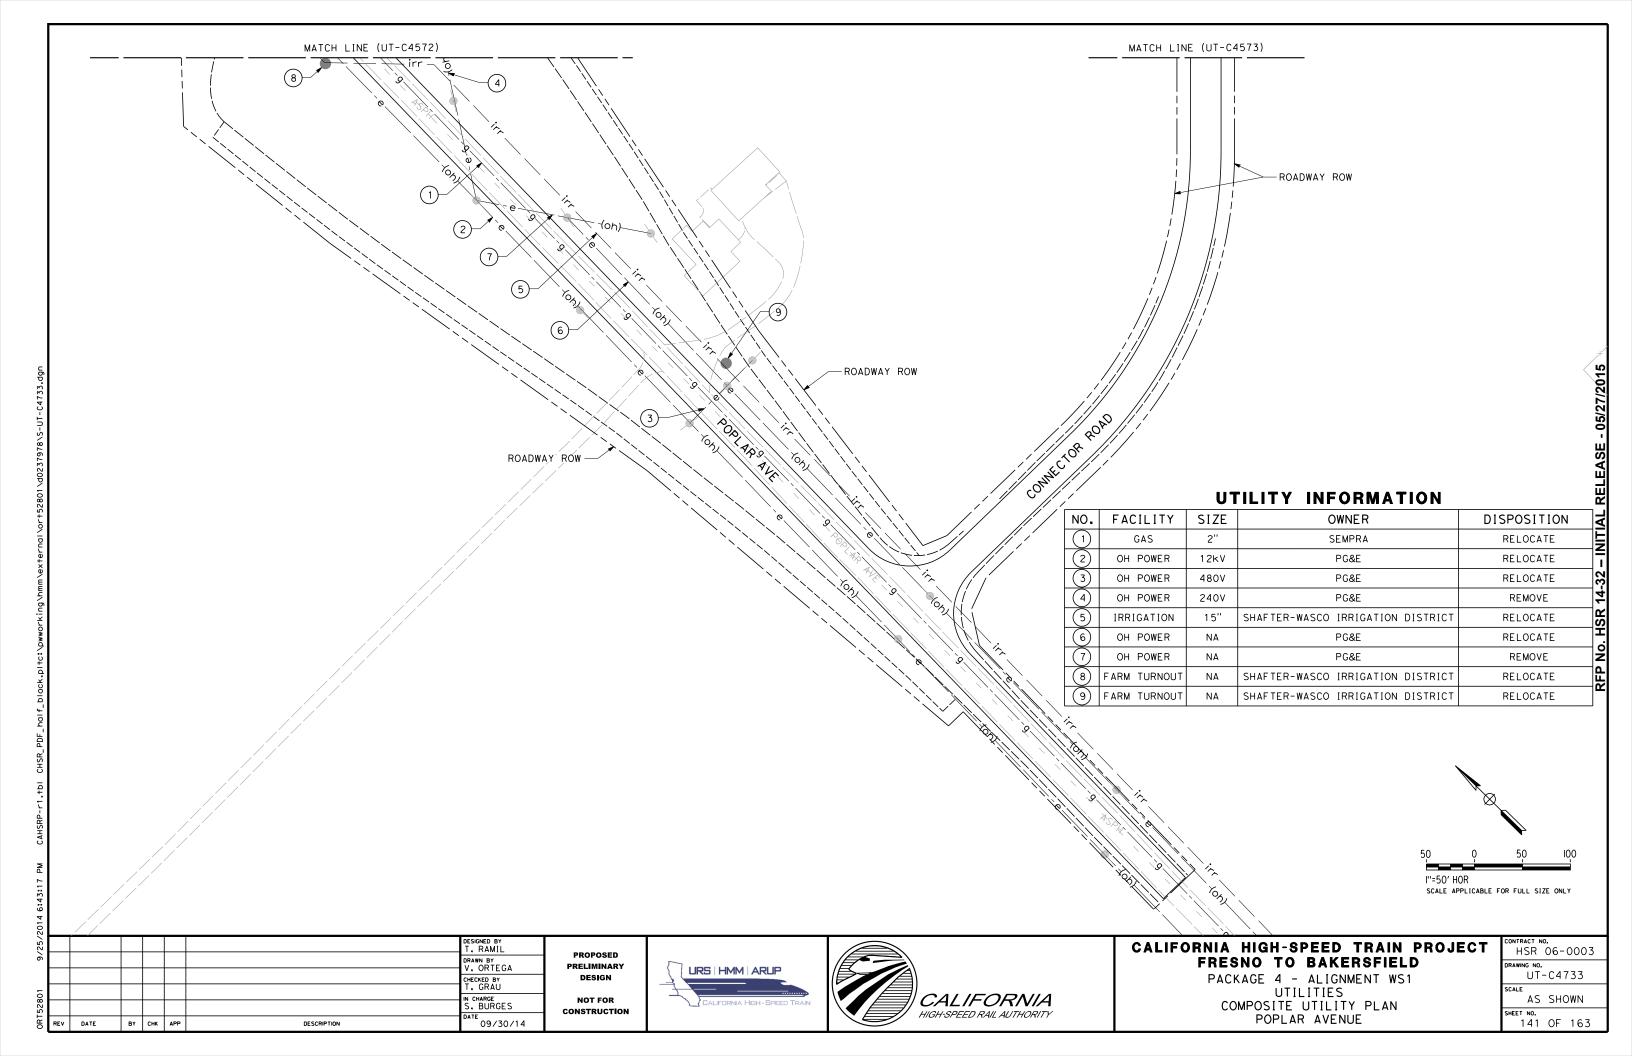


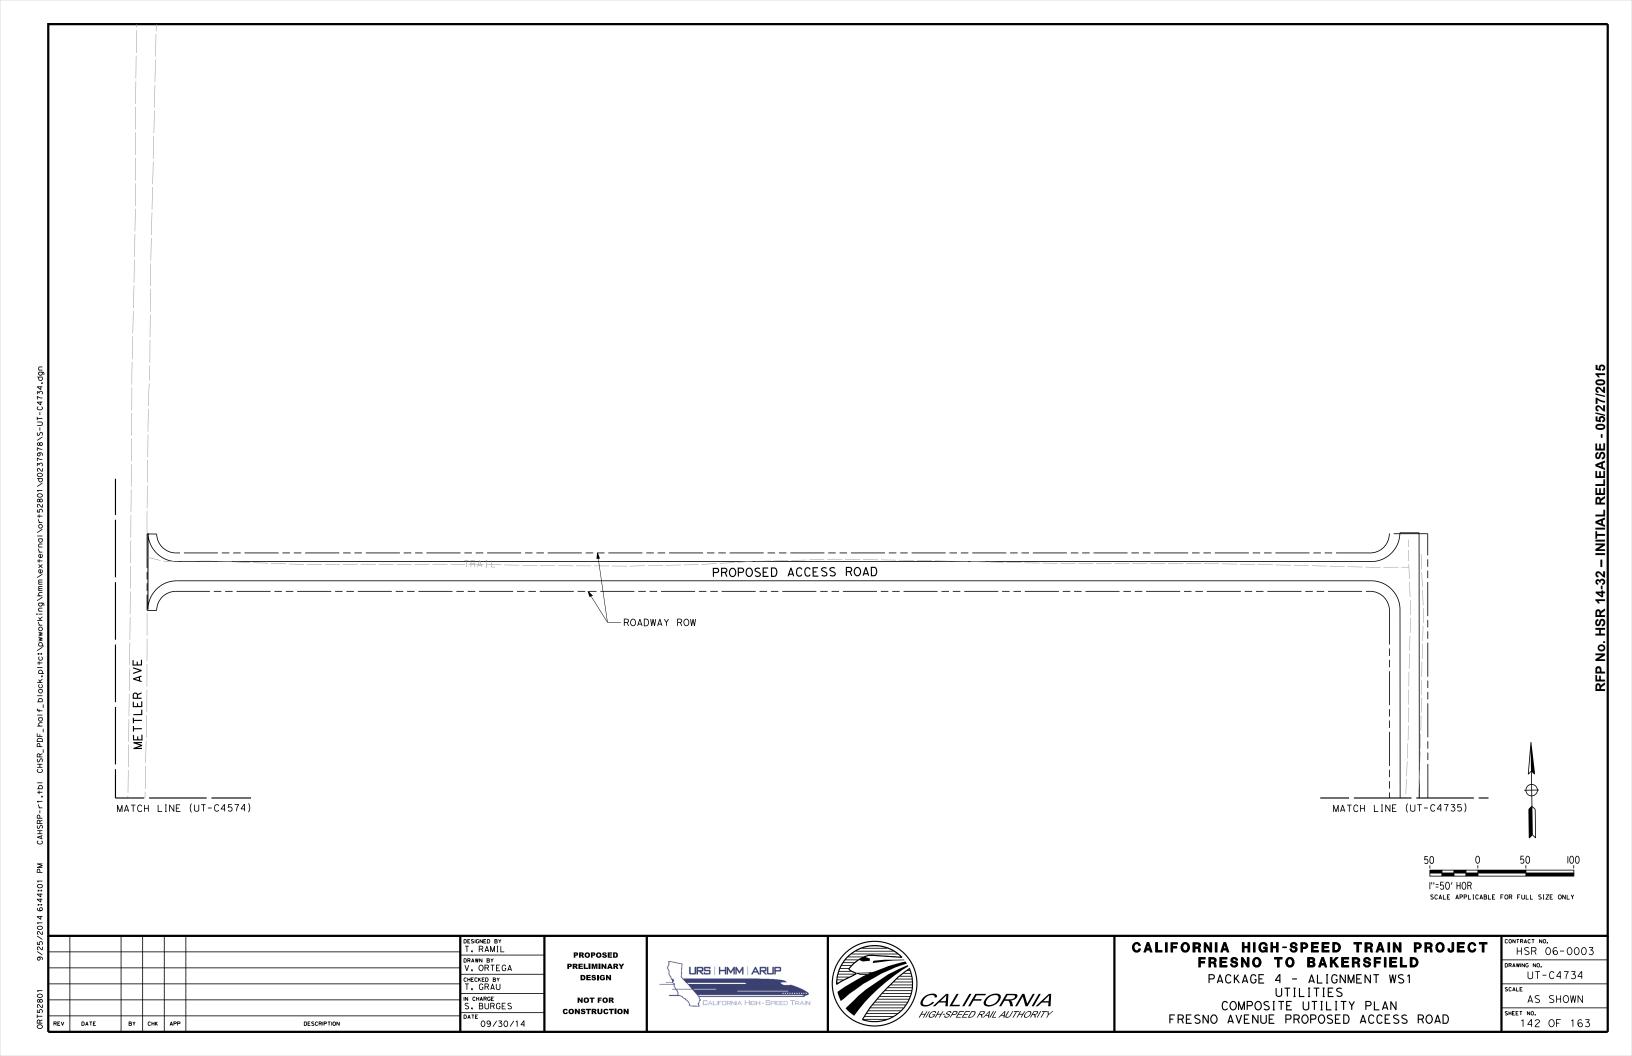


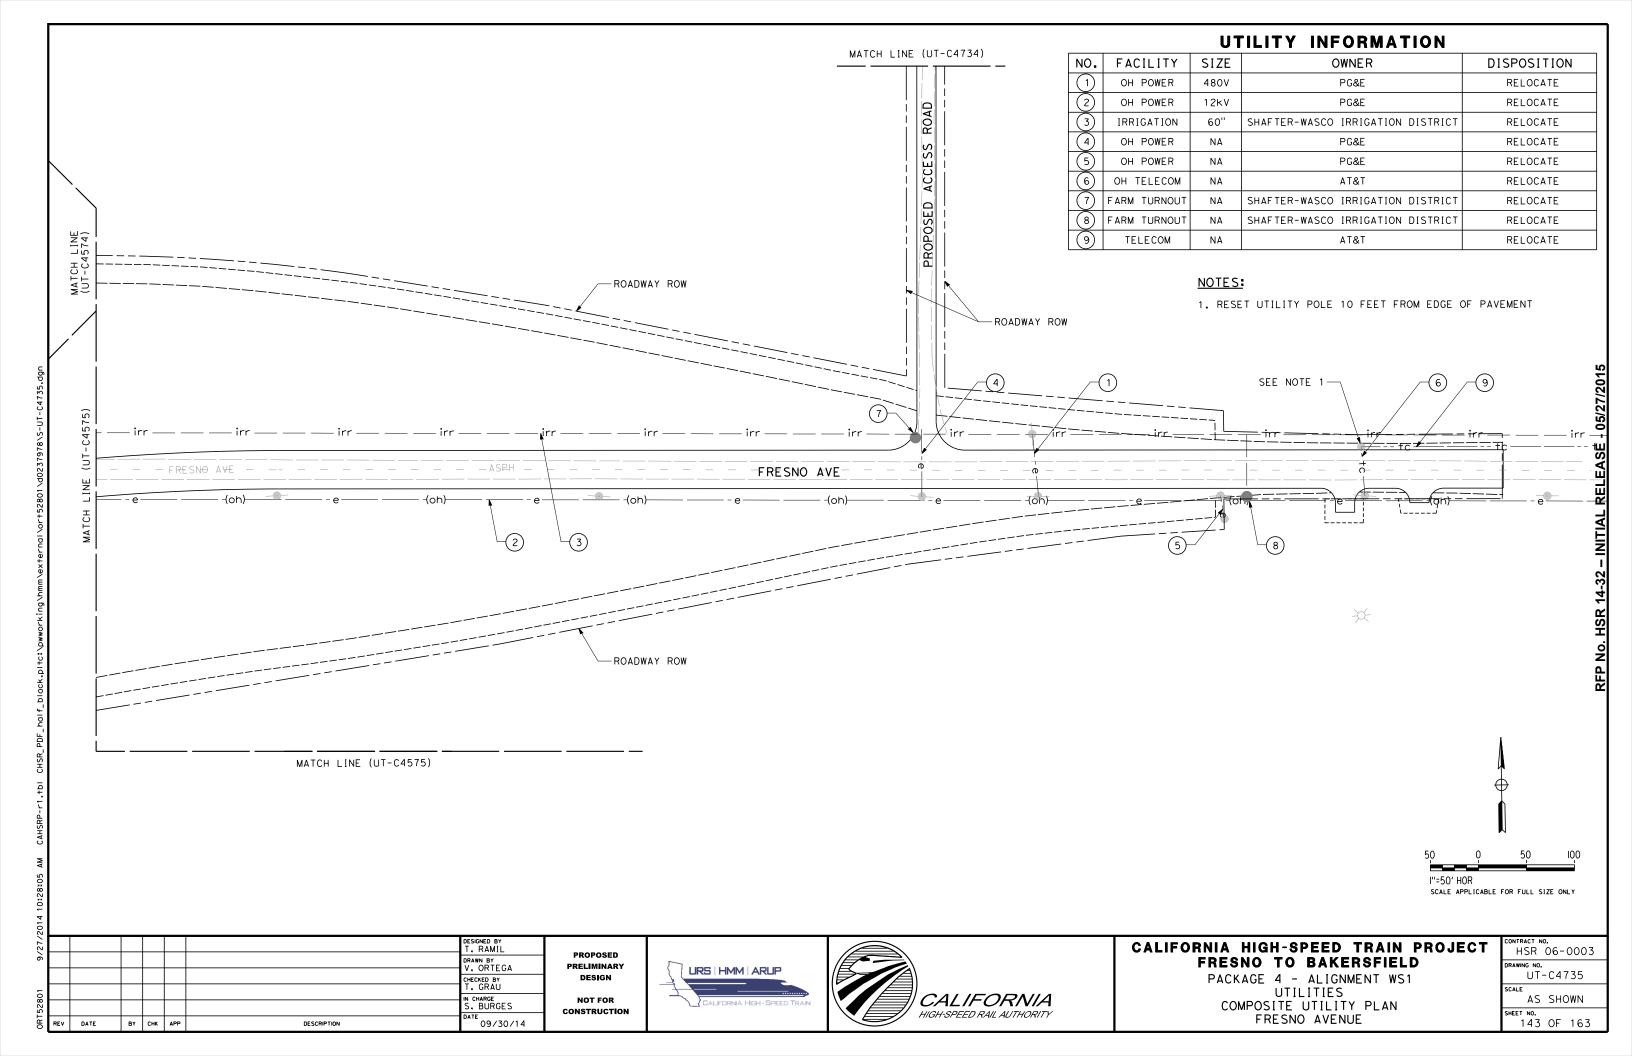


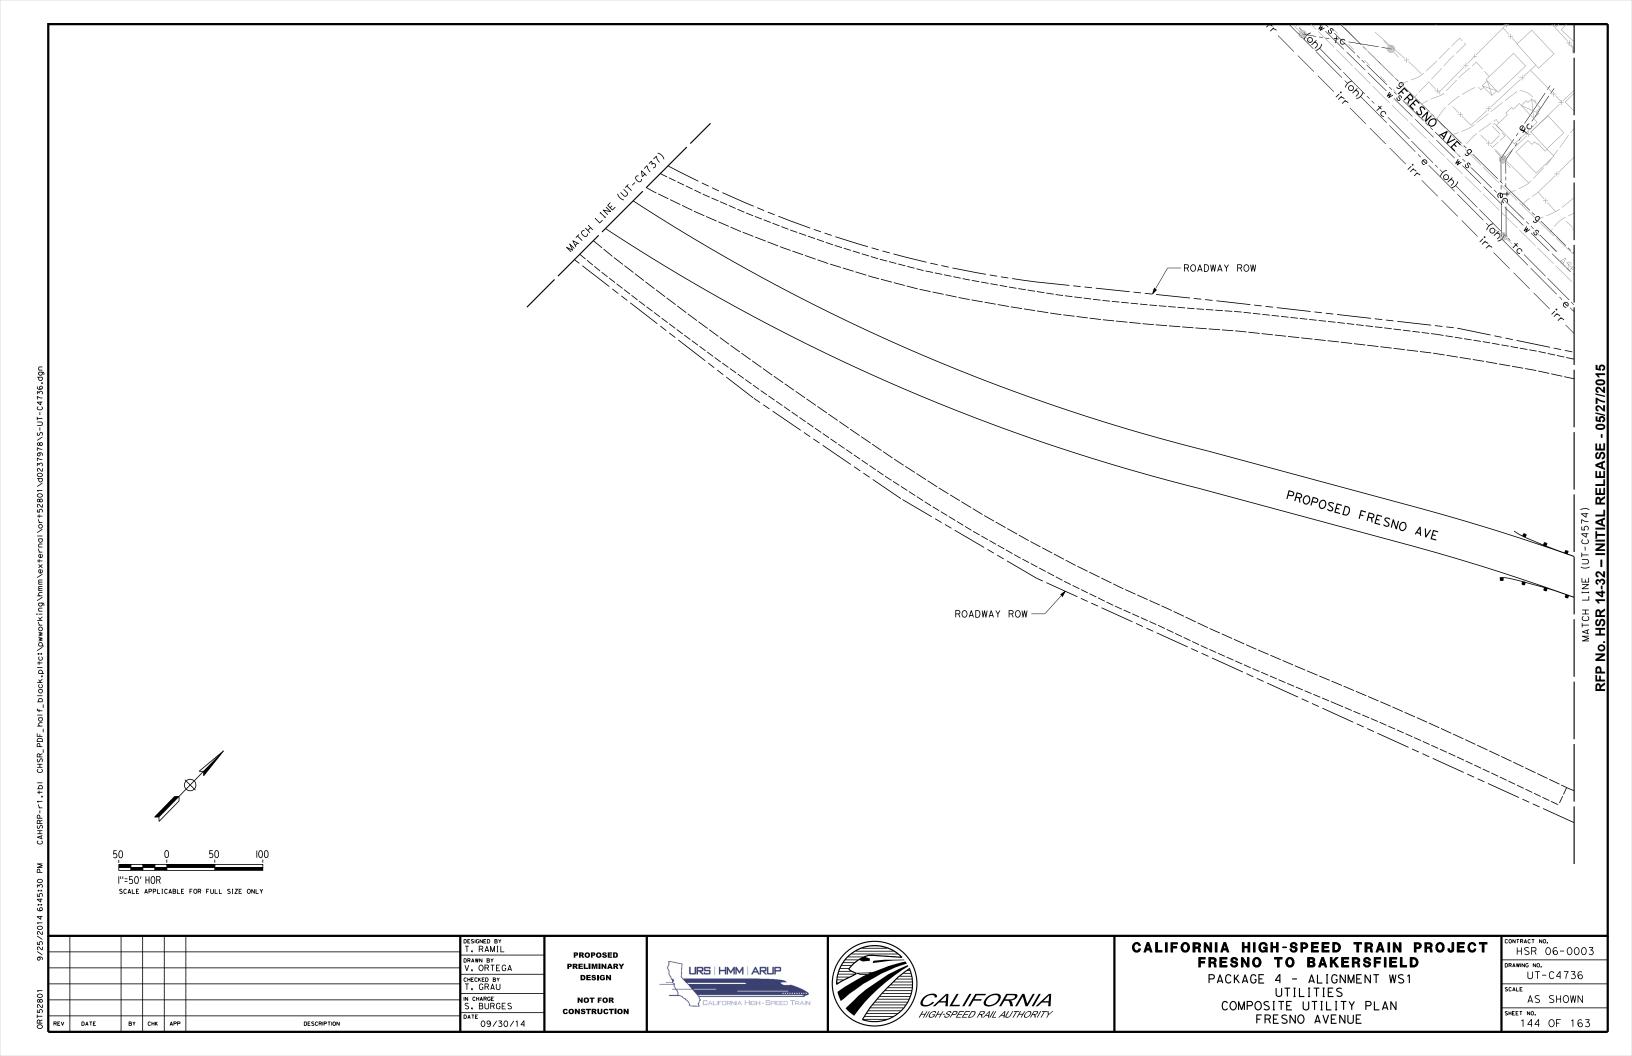


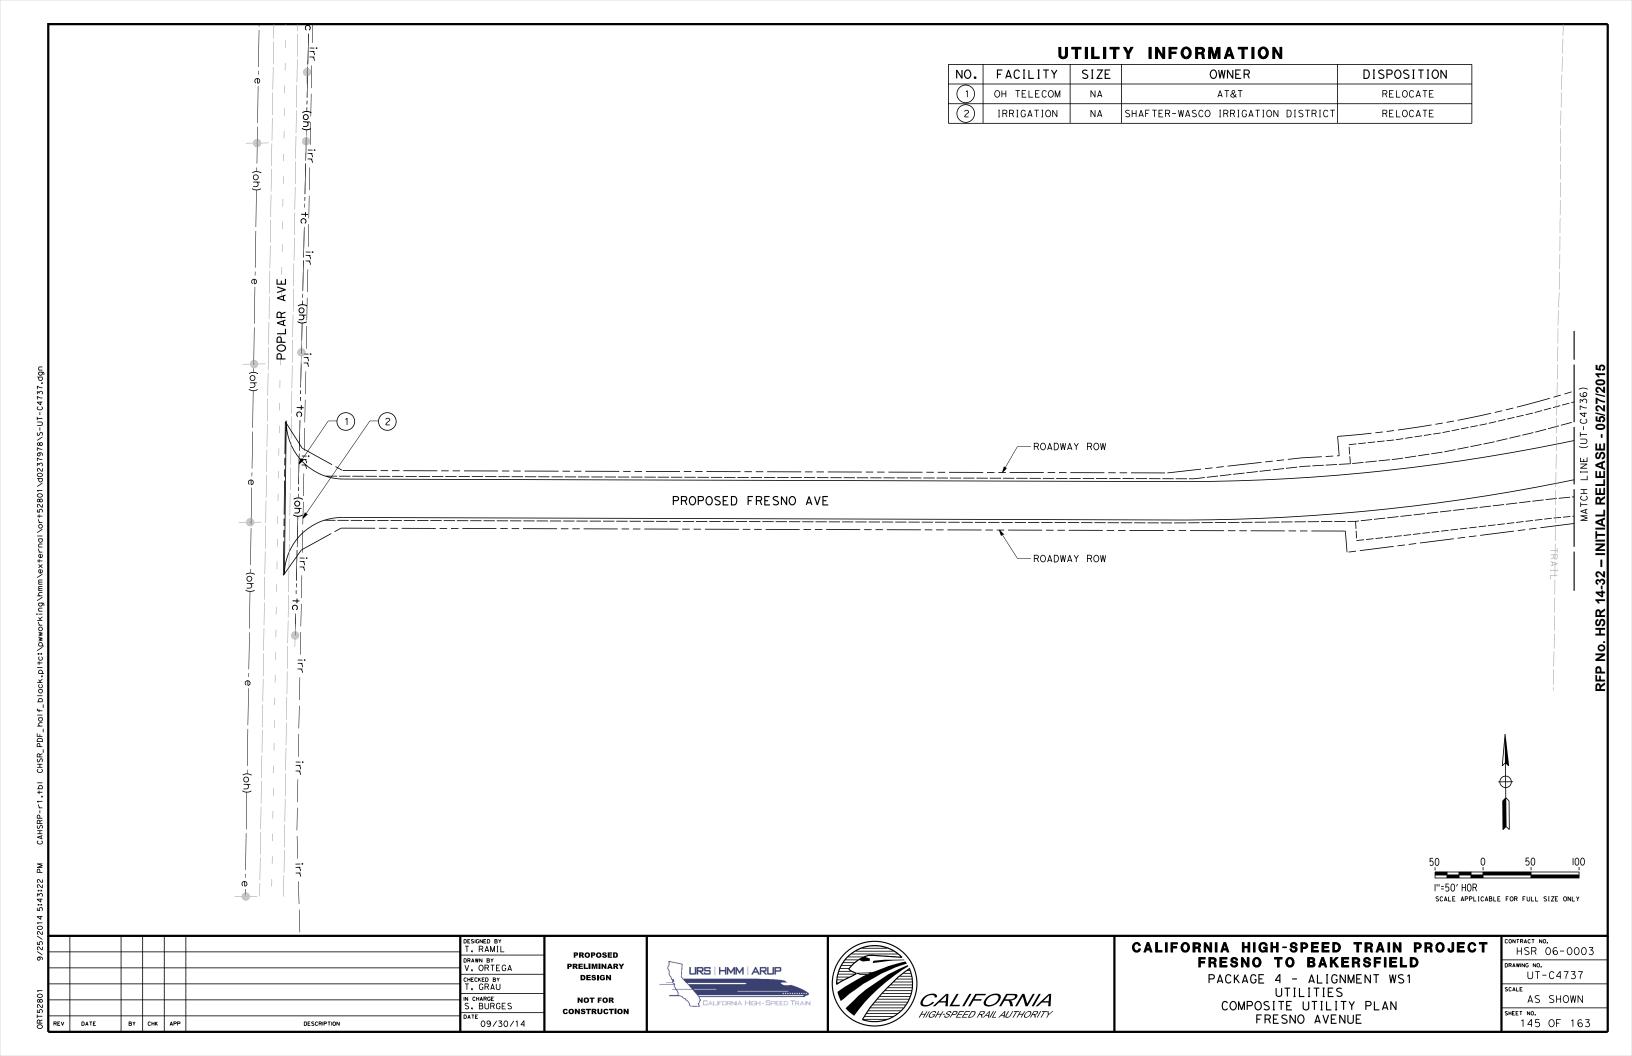

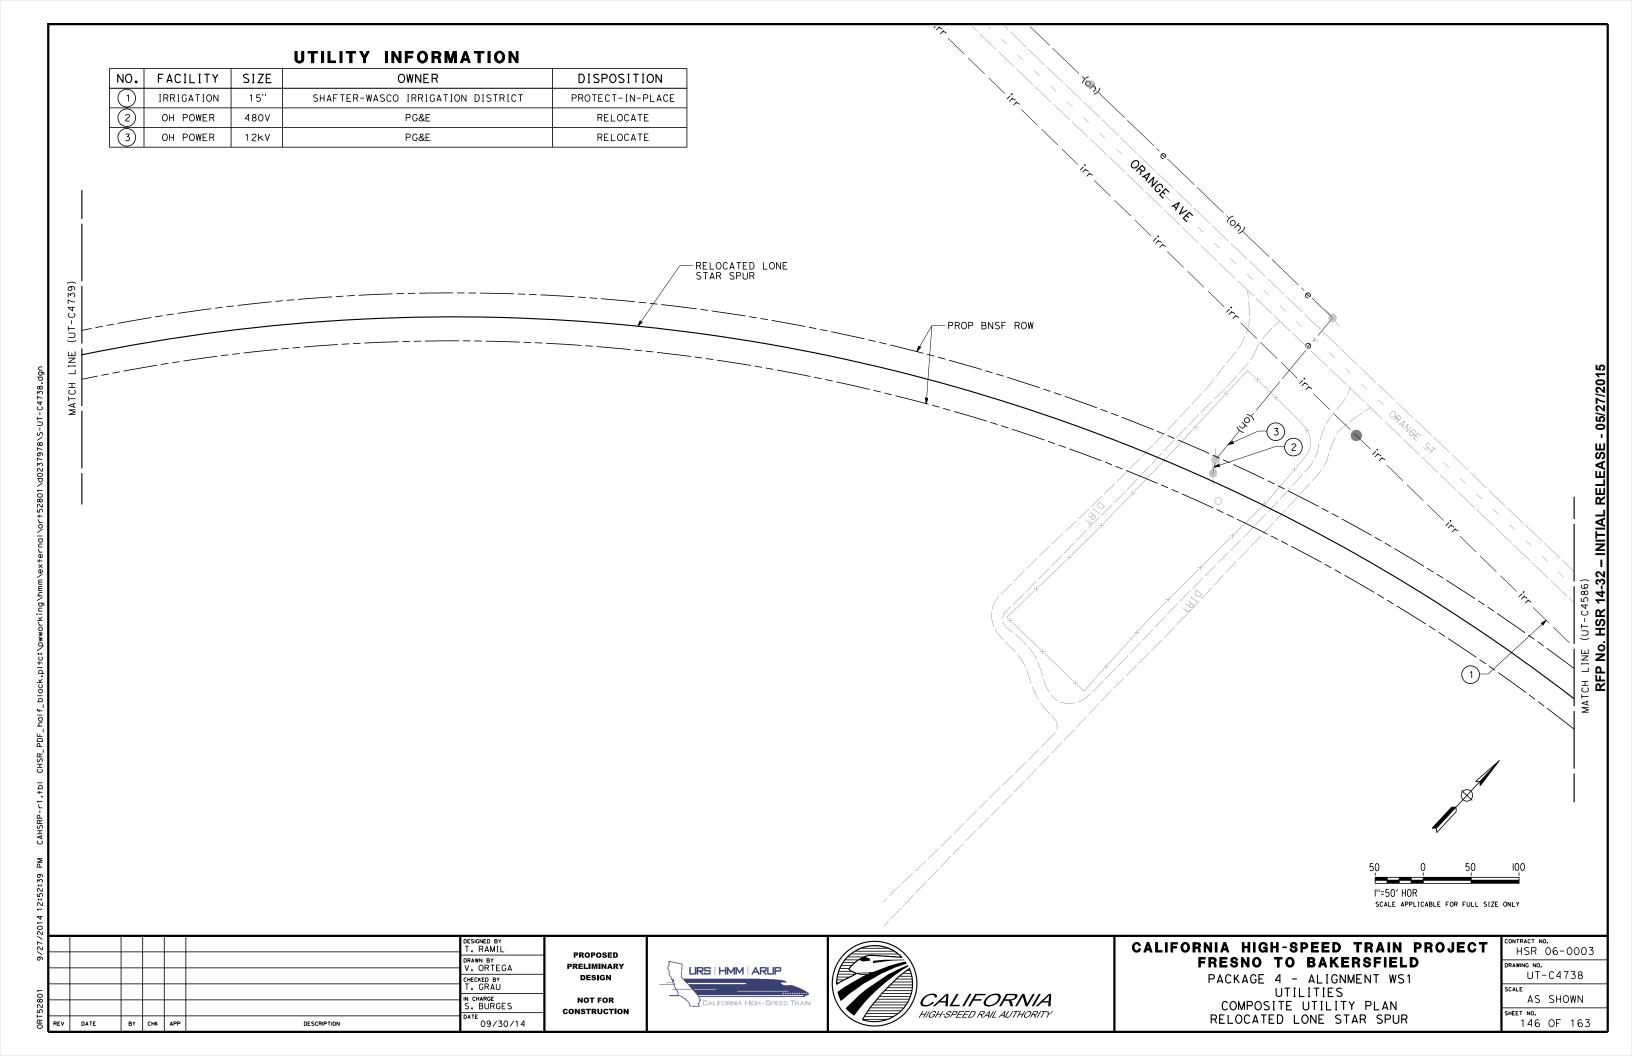

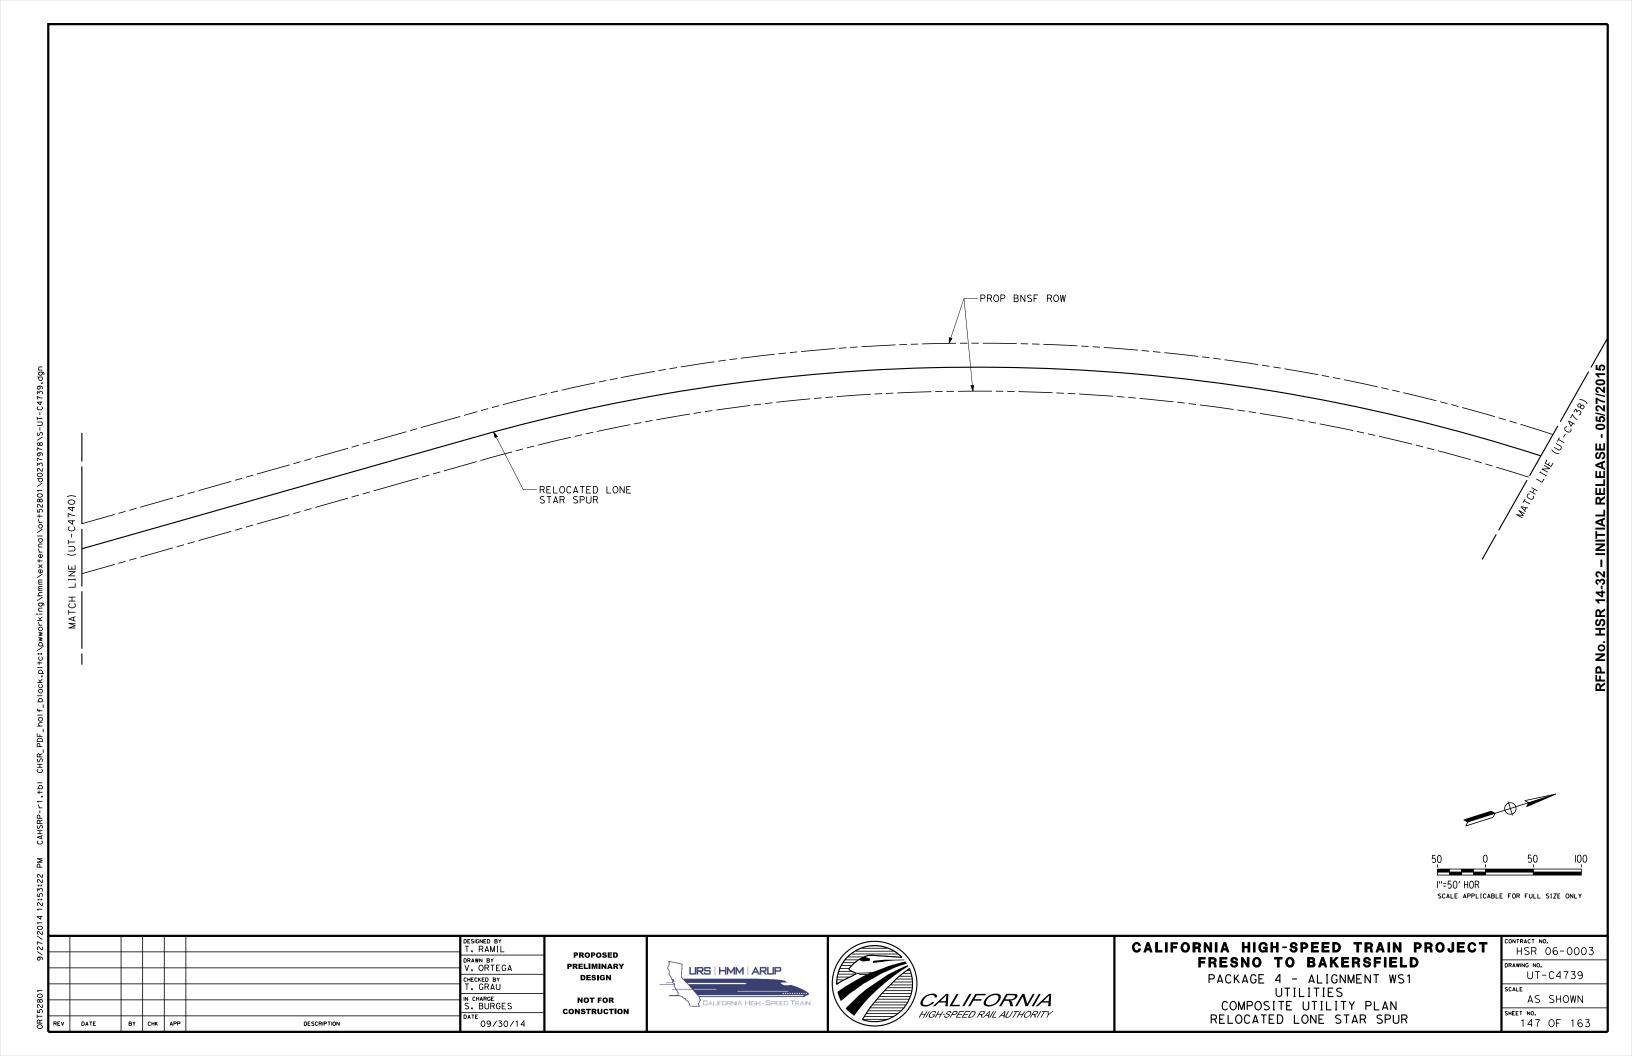

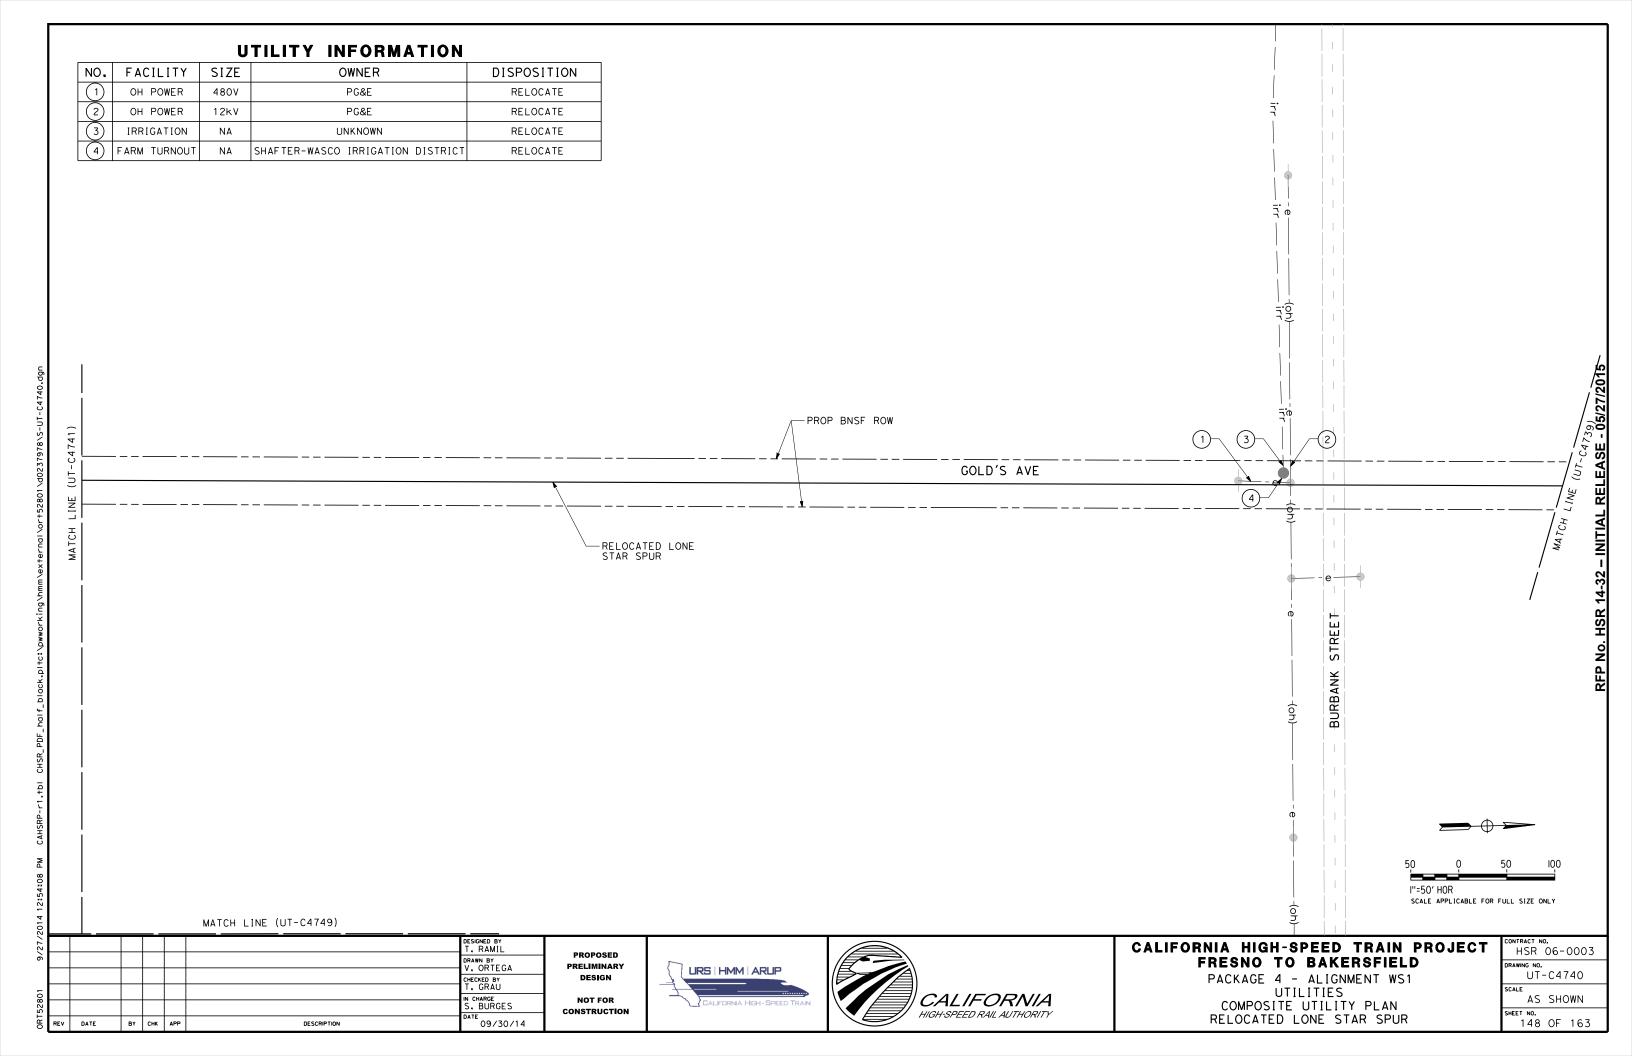

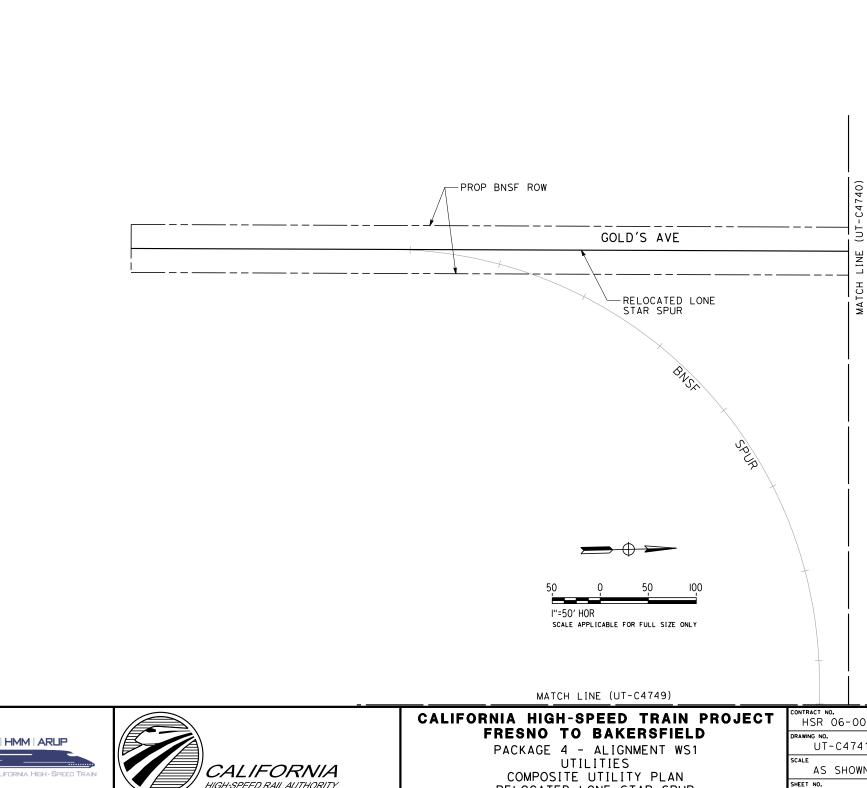

DESIGNED BY DRAWN BY V. ORTEGA CHECKED BY N CHARGE S. BURGES 09/30/14 BY CHK APP DESCRIPTION

PROPOSED PRELIMINARY DESIGN NOT FOR

CONSTRUCTION






RELOCATED LONE STAR SPUR

CONTRACT NO.
HSR 06-0003
DRAWING NO.
UT-C4741
SCALE
AS SHOWN


SHEET NO. 149 OF 163

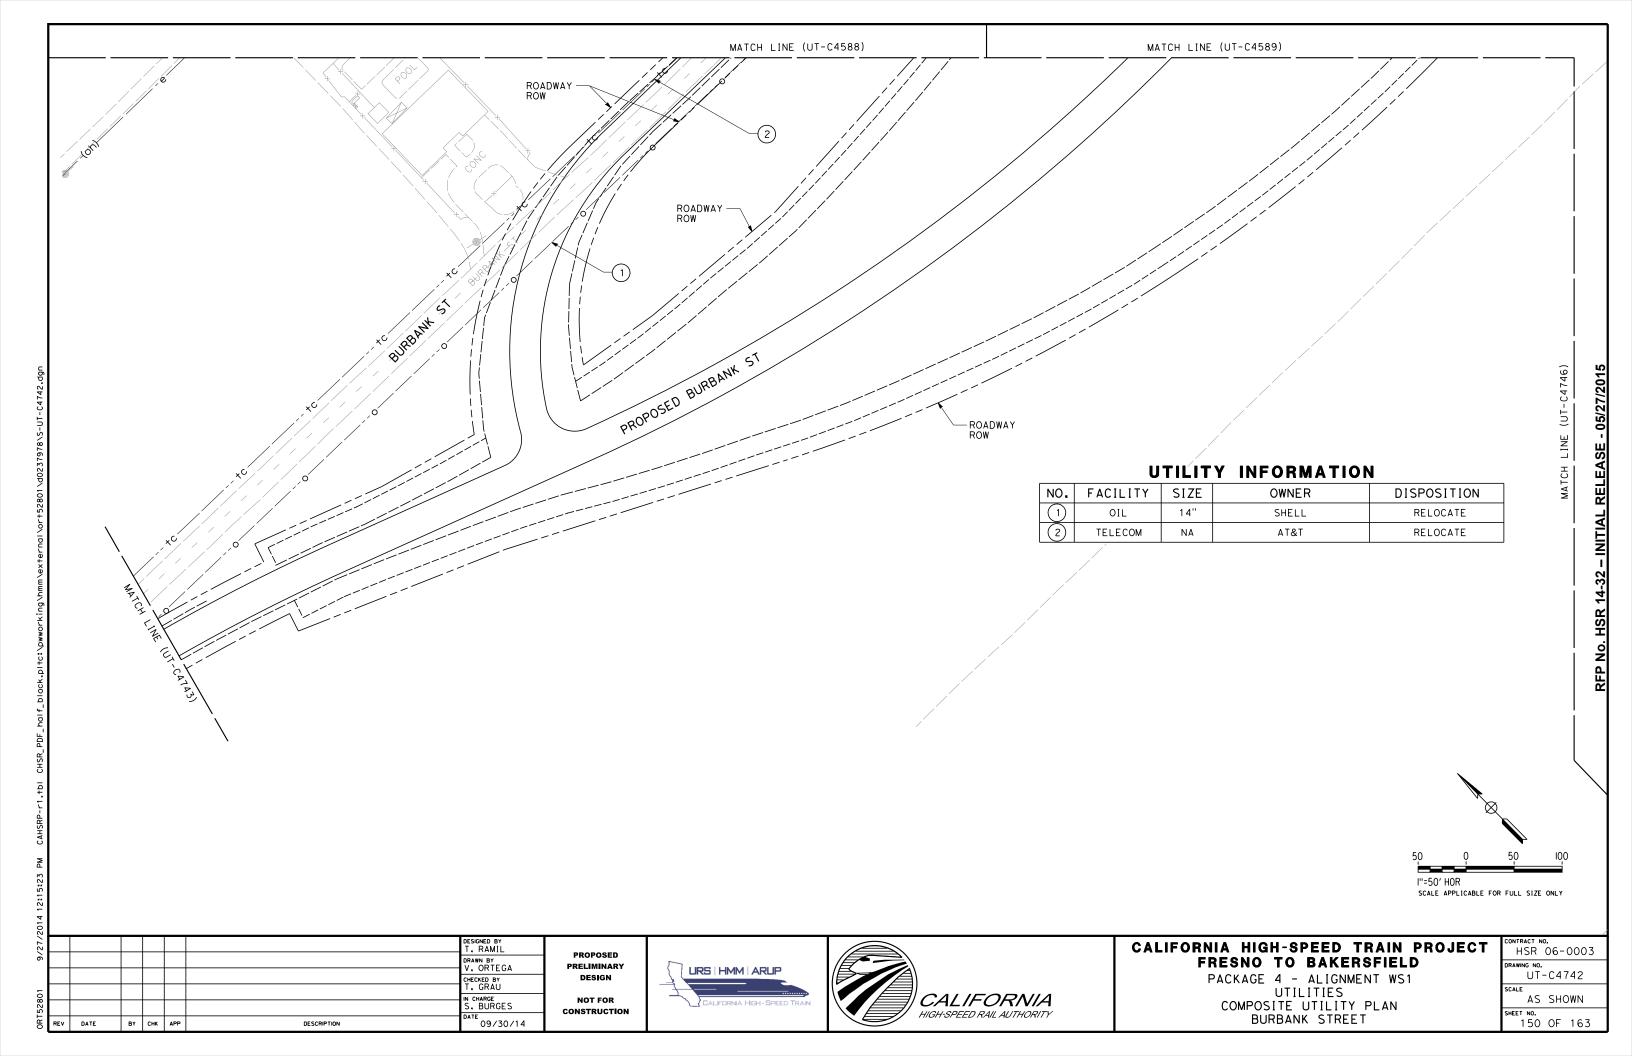


09/30/14

DESCRIPTION

BY CHK APP

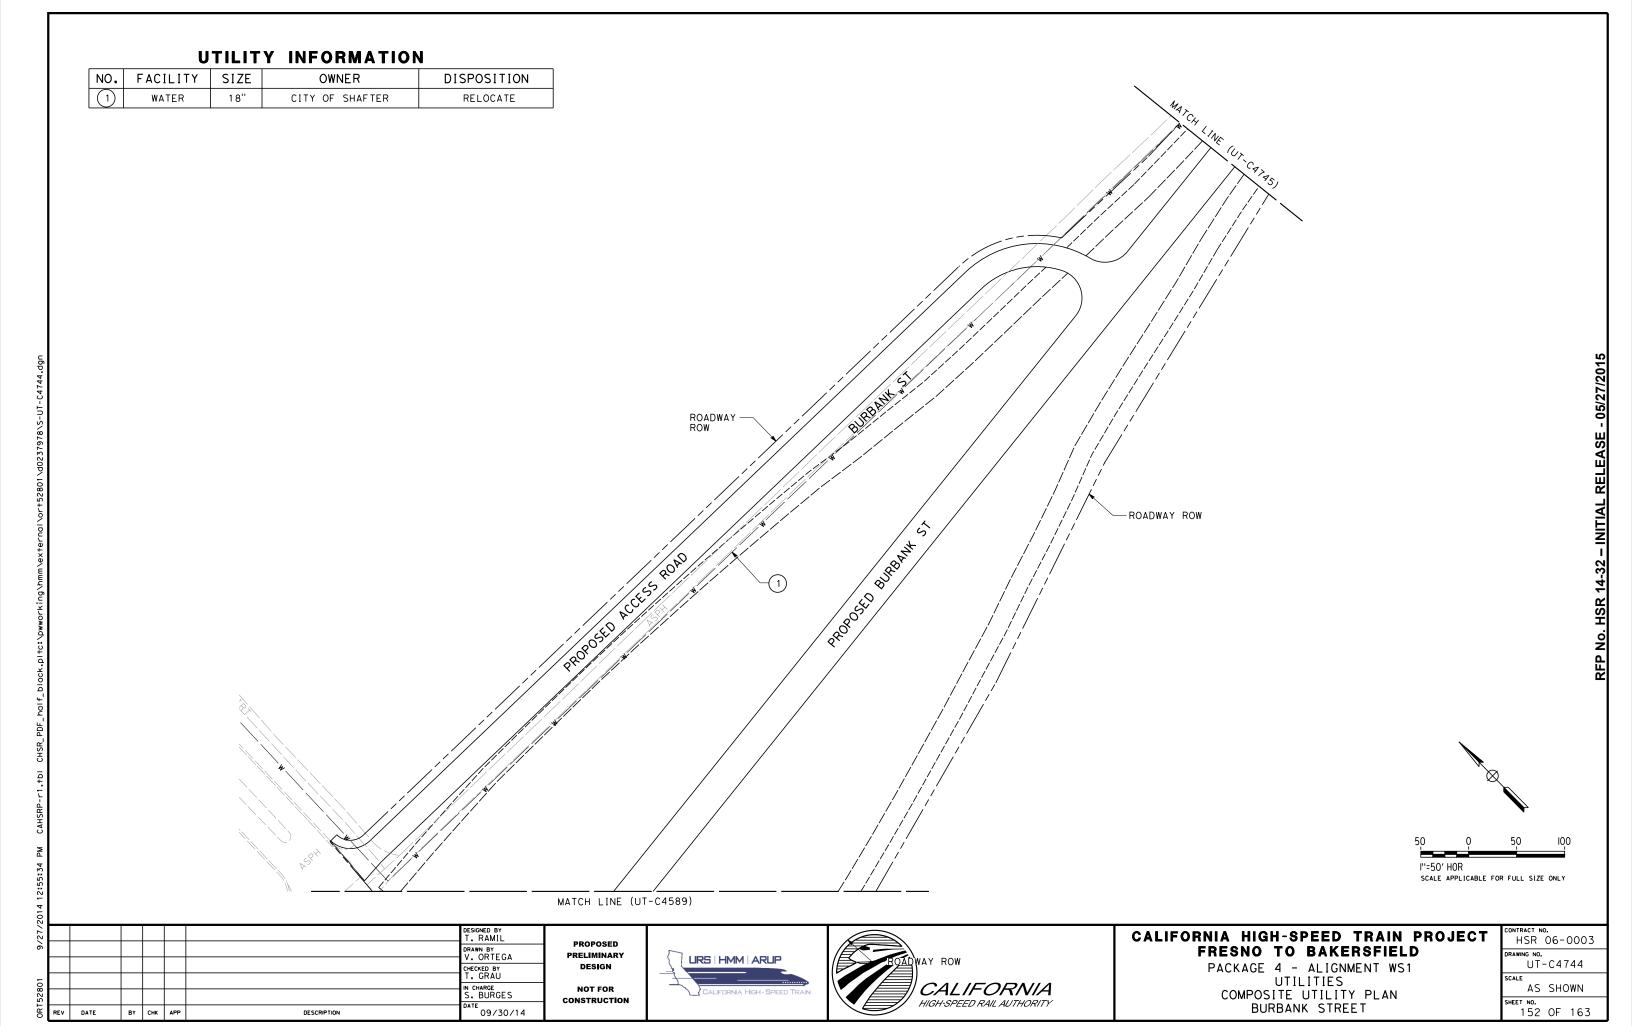

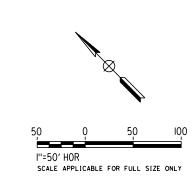

						DESIGNED BY T. RAMIL
·						DRAWN BY V. ORTEGA
_						CHECKED BY T. GRAU
75 807						IN CHARGE S. BURGES
REV	DATE	ВΥ	СНК	APP	DESCRIPTION	DATE 09/30/14

PROPOSED
PRELIMINARY
DESIGN
NOT FOR

CONSTRUCTION







ROADWAY ROW


### CALIFORNIA HIGH-SPEED TRAIN PROJECT FRESNO TO BAKERSFIELD


PACKAGE 4 - ALIGNMENT WS1 UTILITIES COMPOSITE UTILITY PLAN BURBANK STREET


CONTRACT NO.							
HSR 06-0003							
DRAWING NO.							
UT-C4745							
SCALE							
AS SHOWN							
SHEET NO.							
153 OF 163							

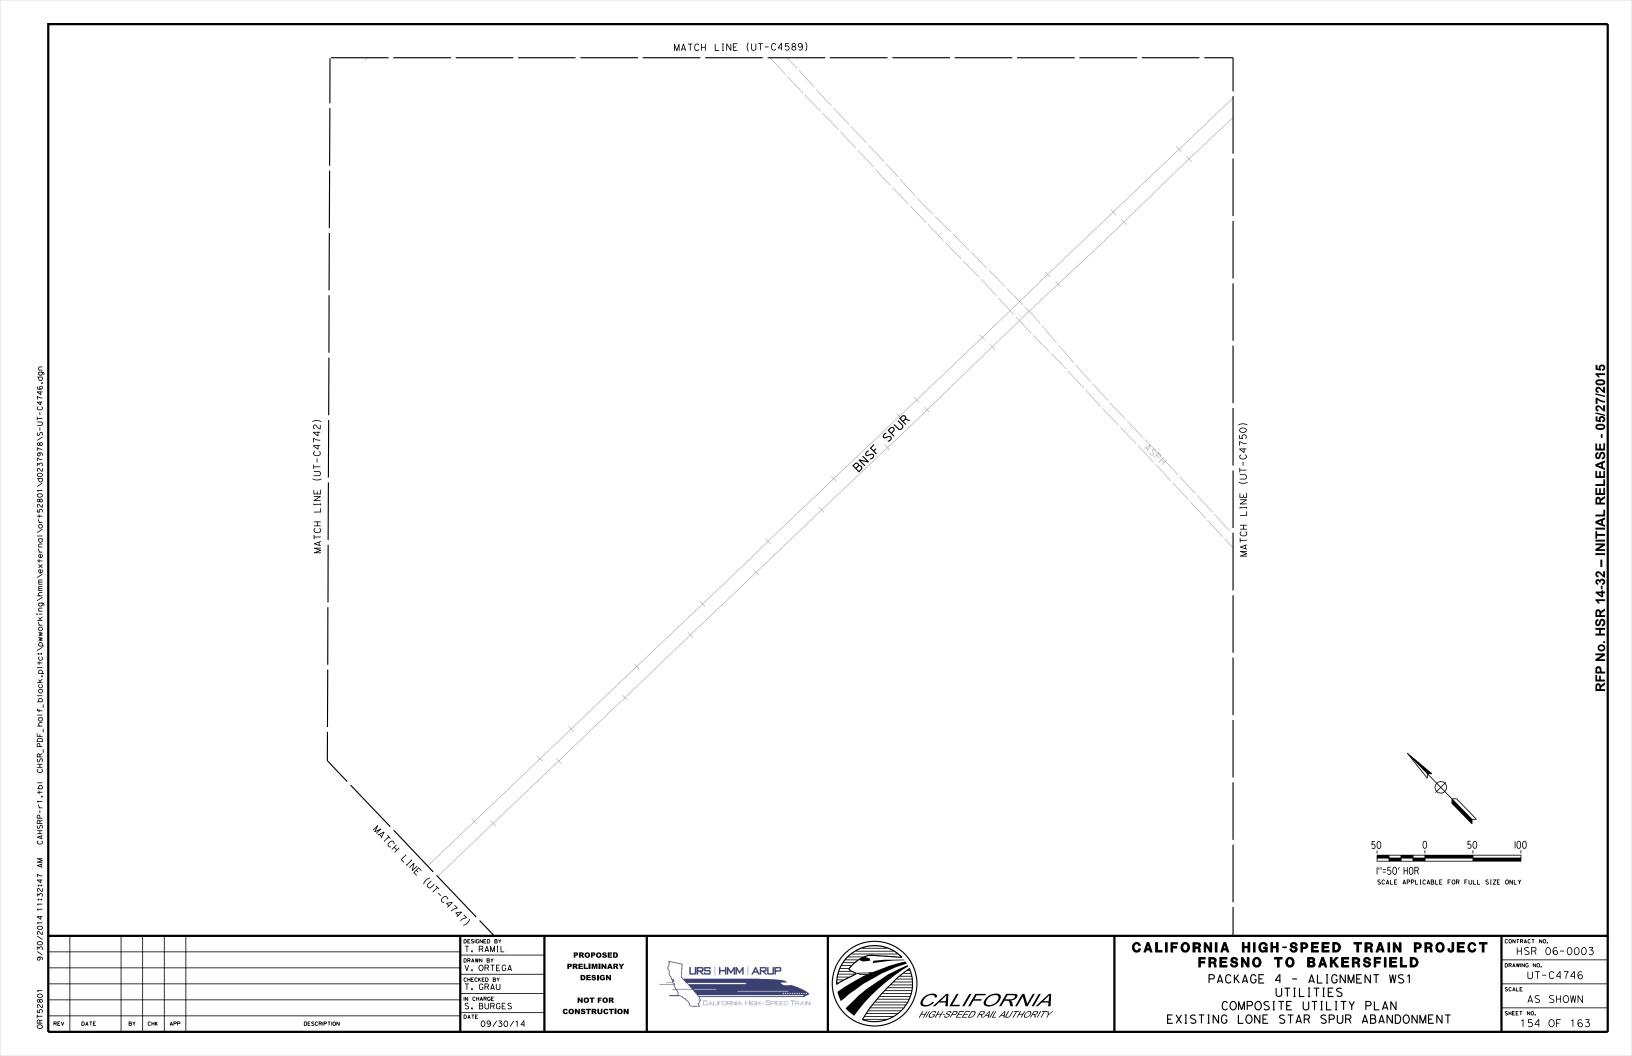


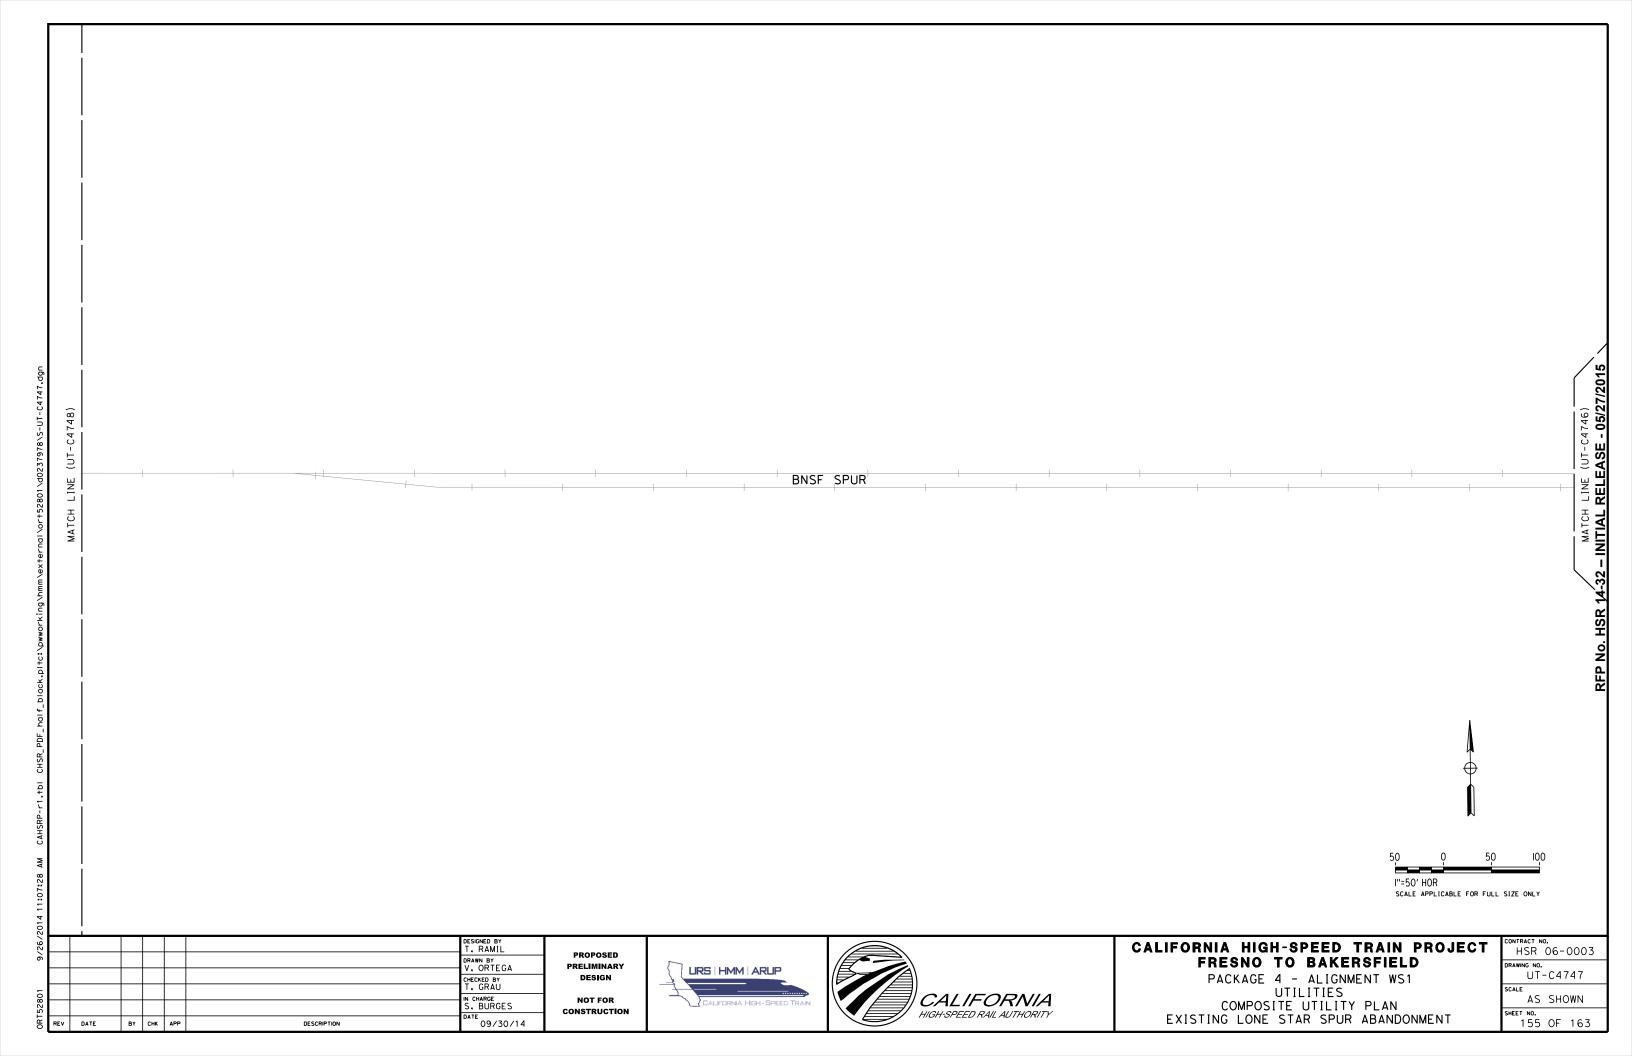


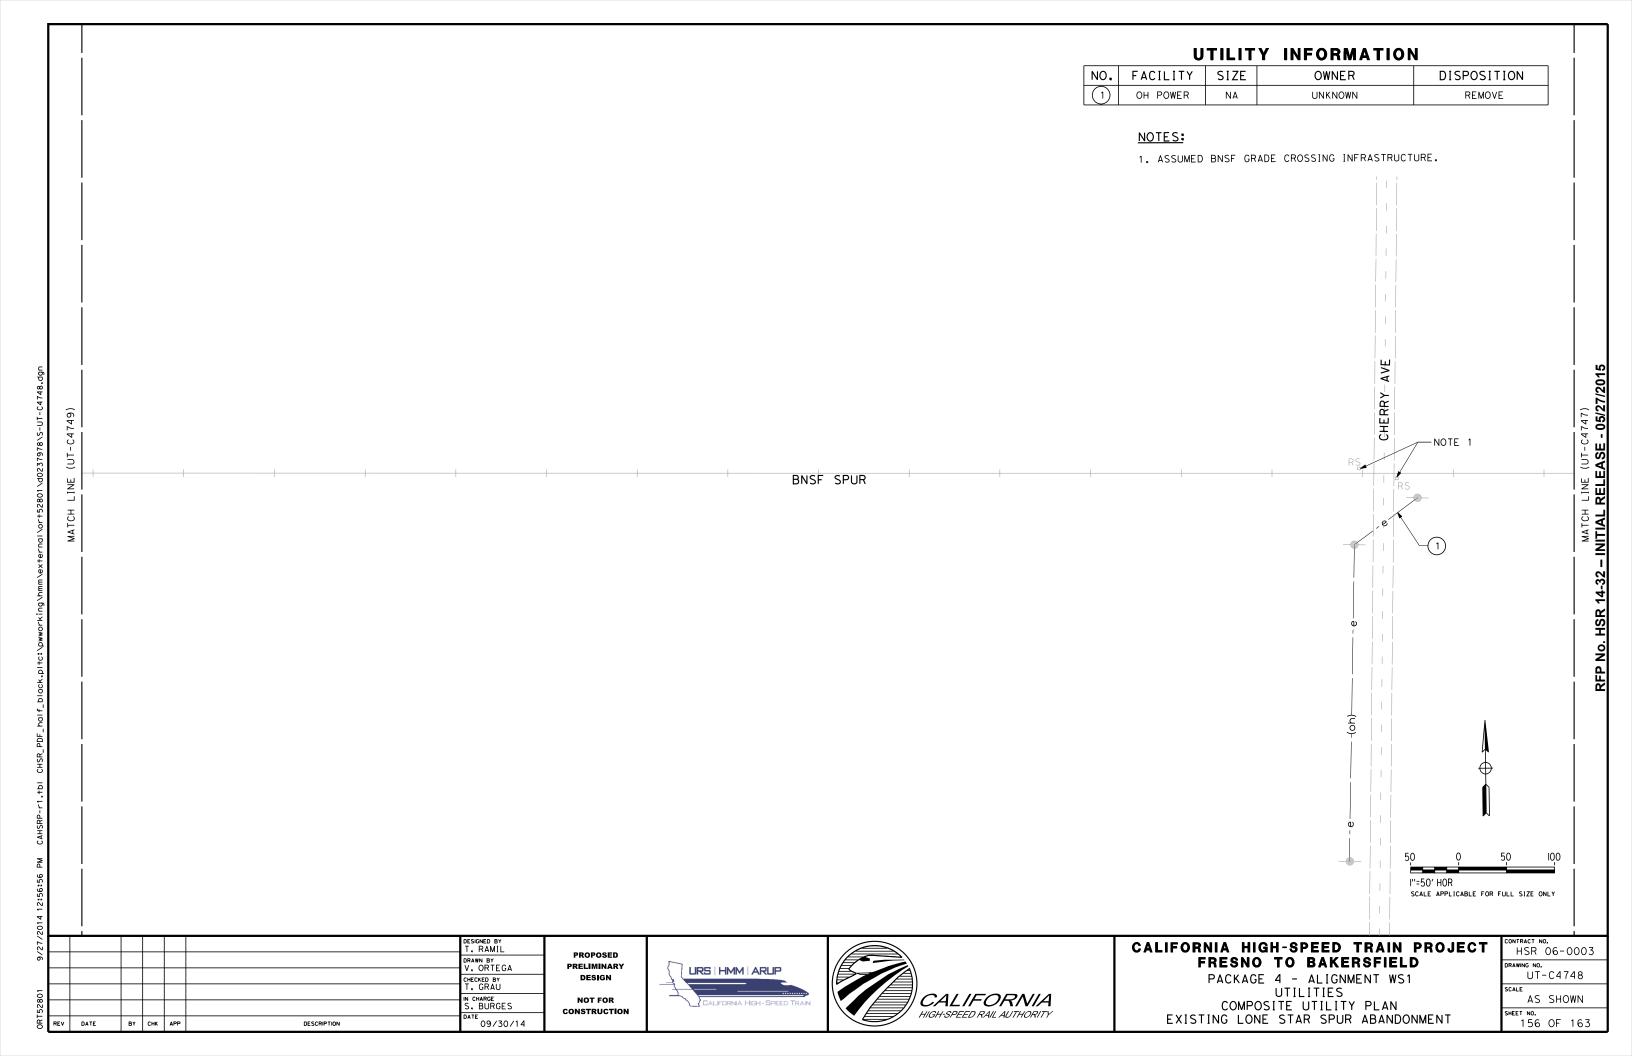

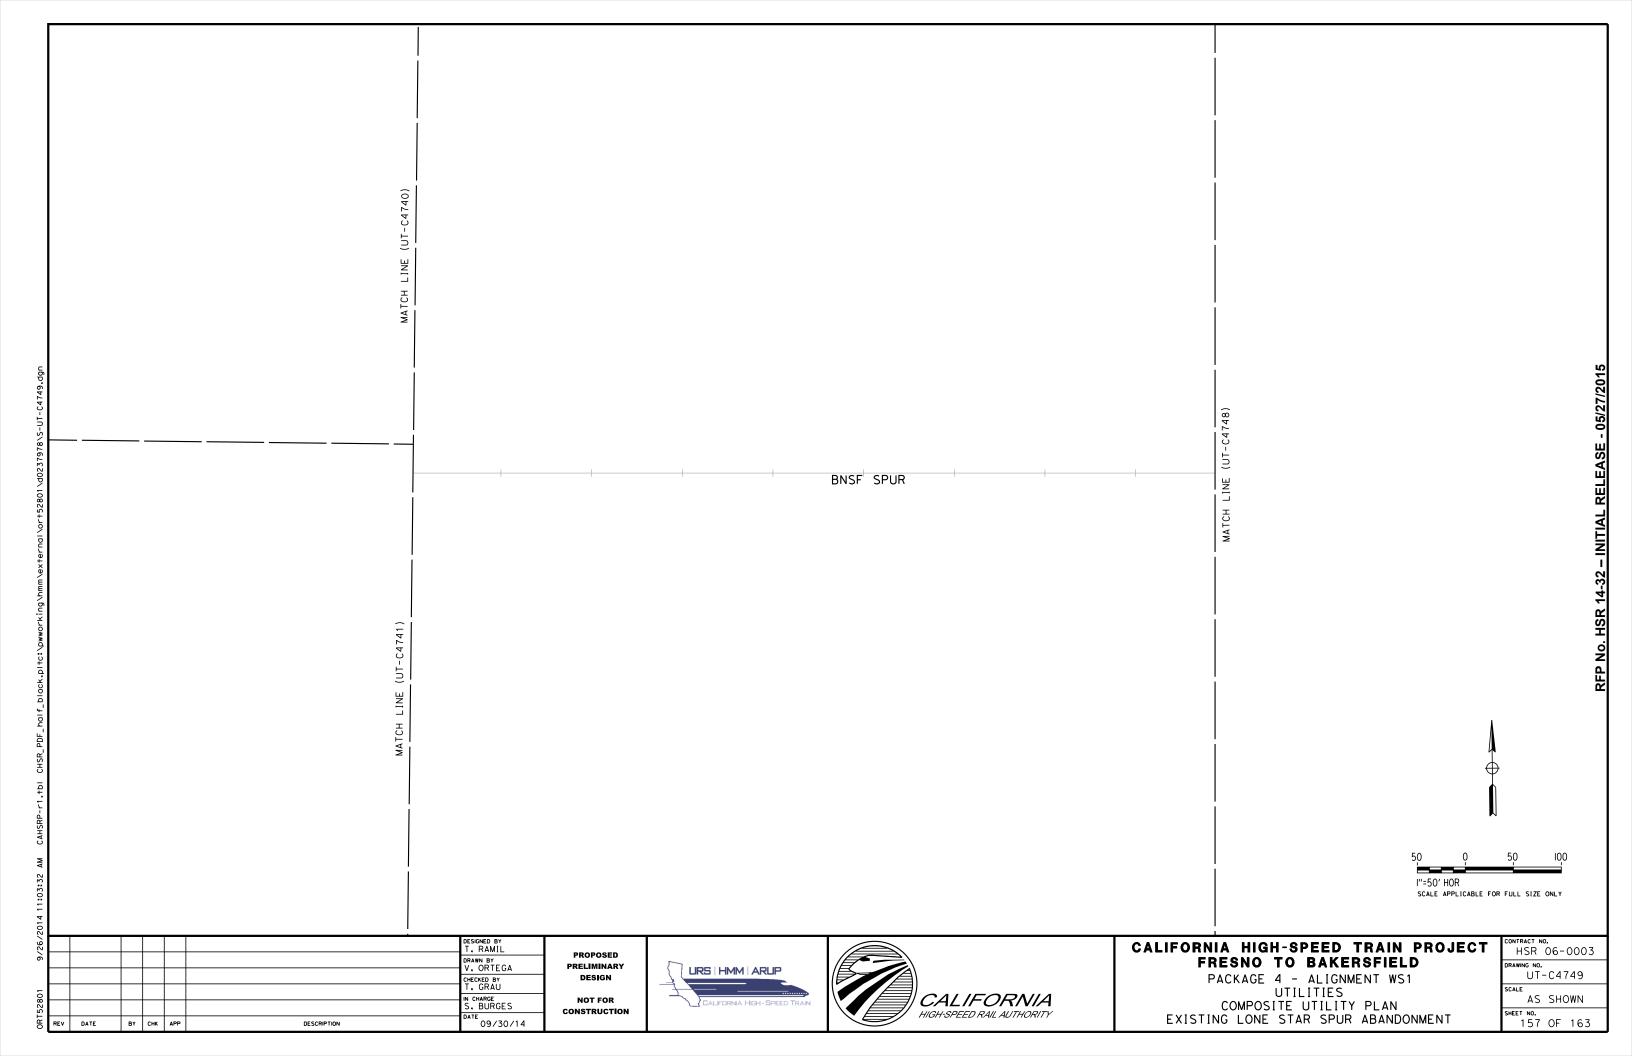

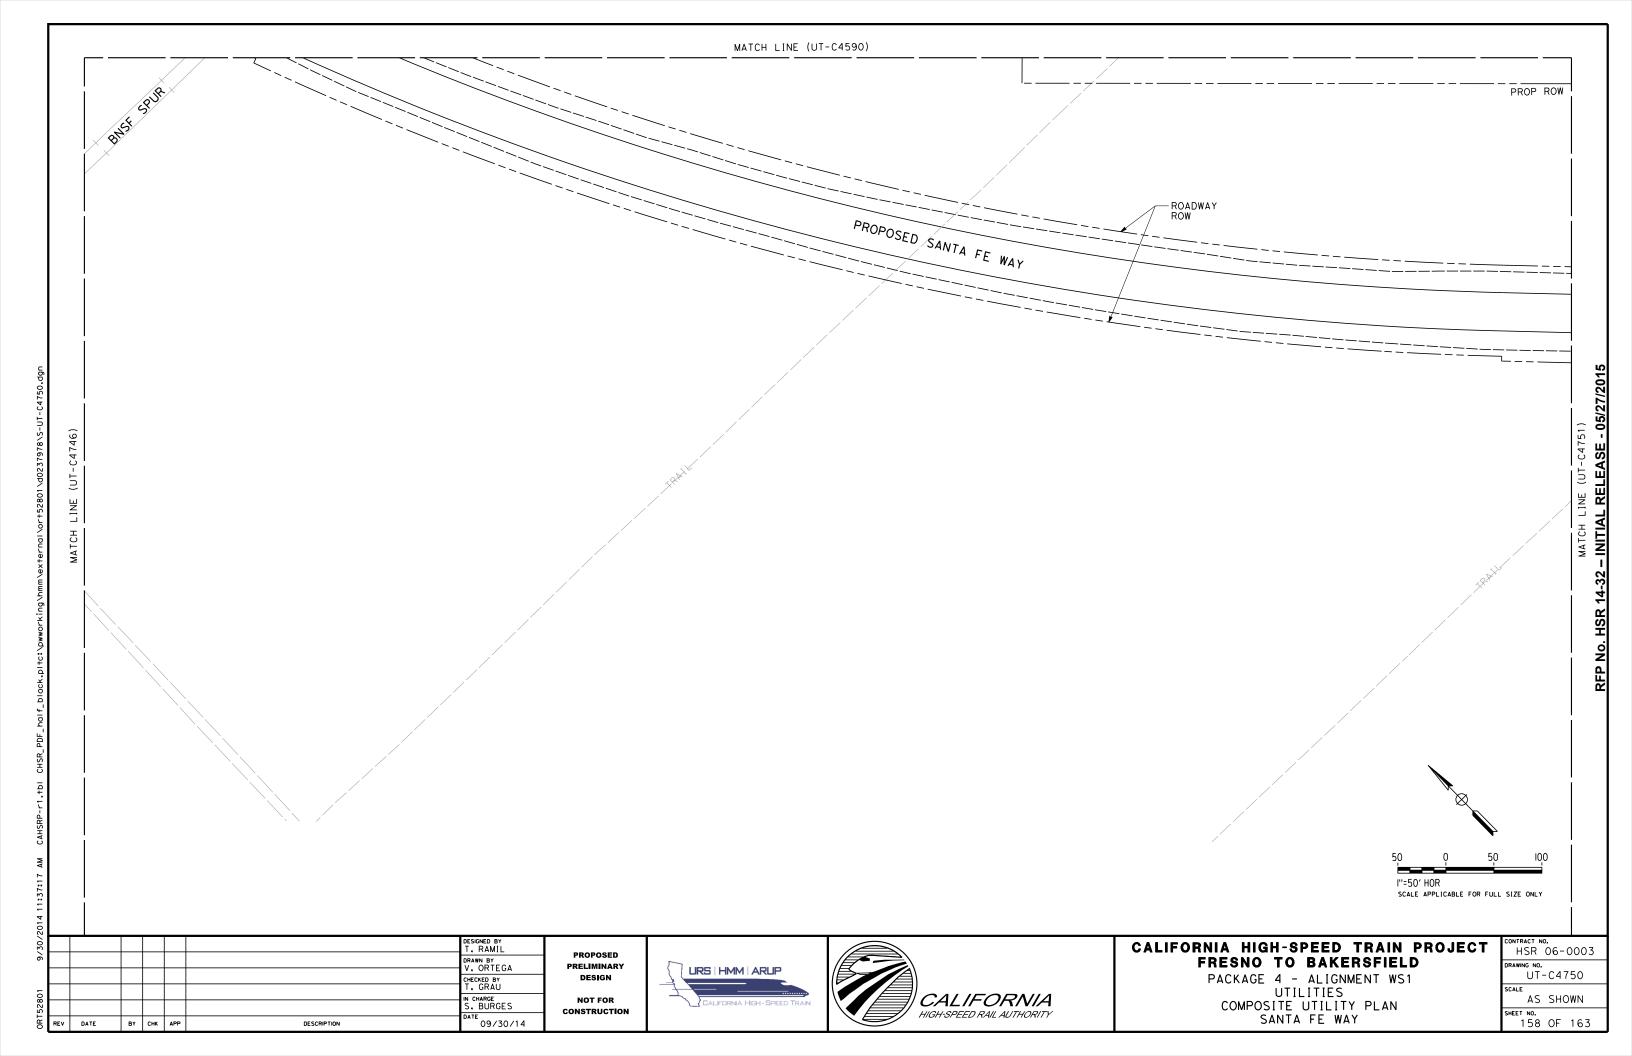

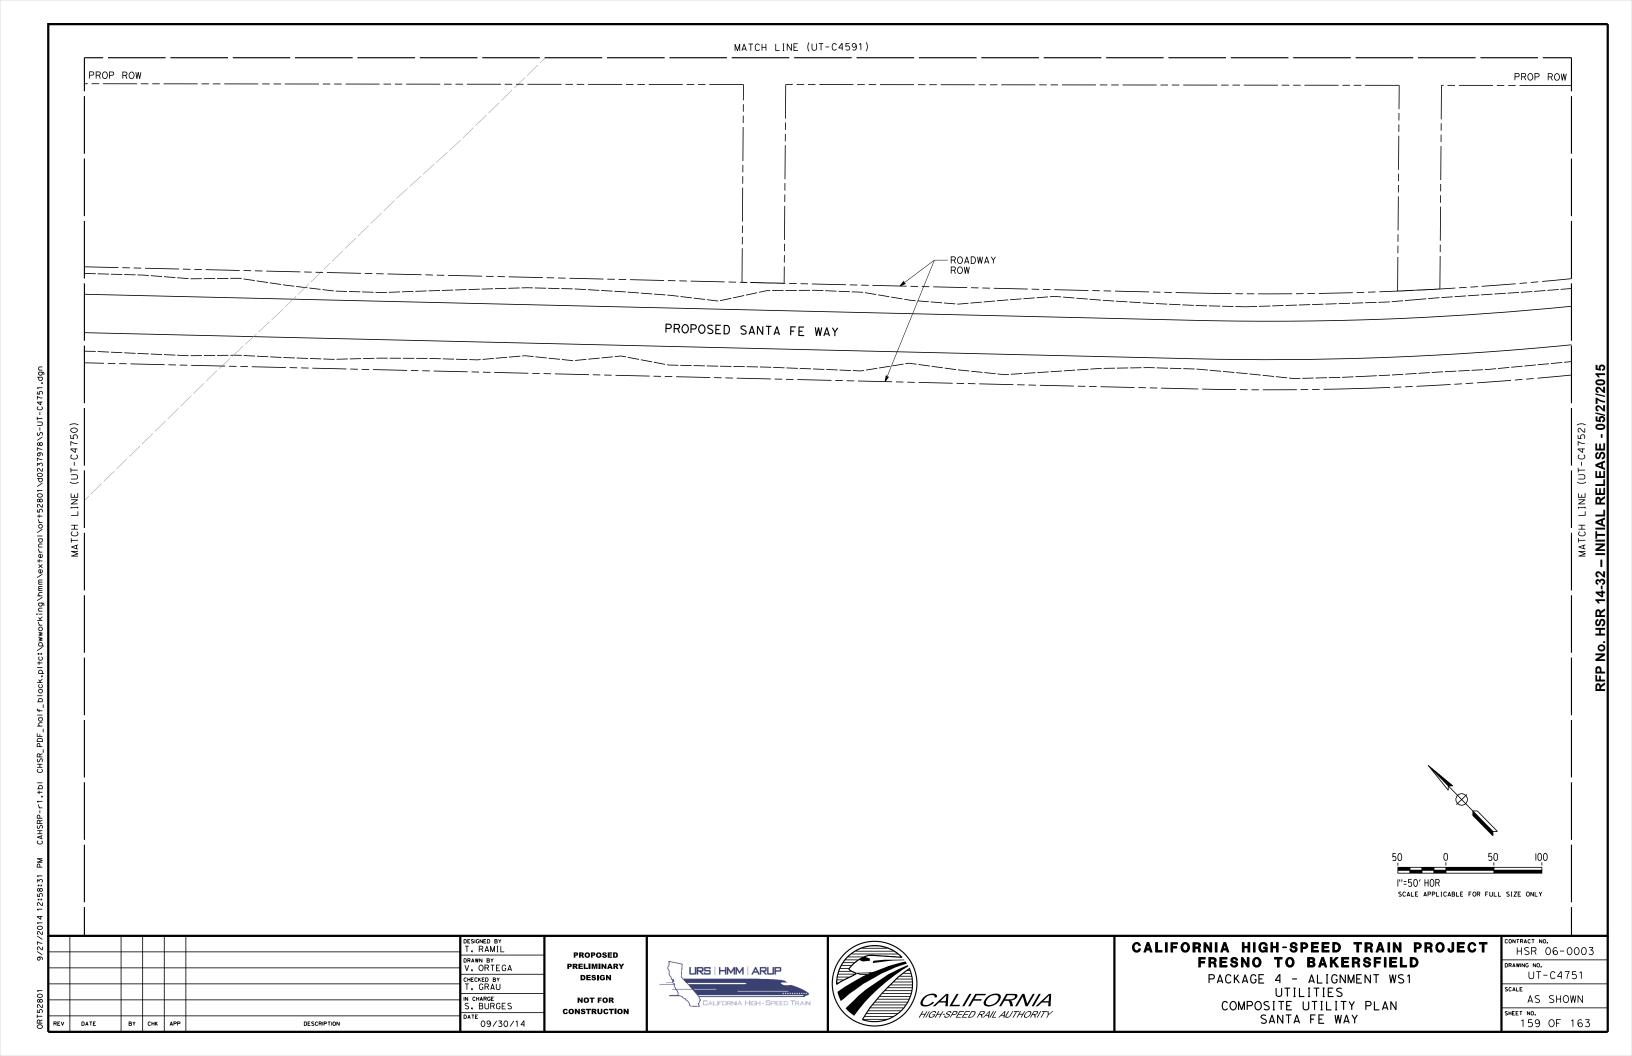

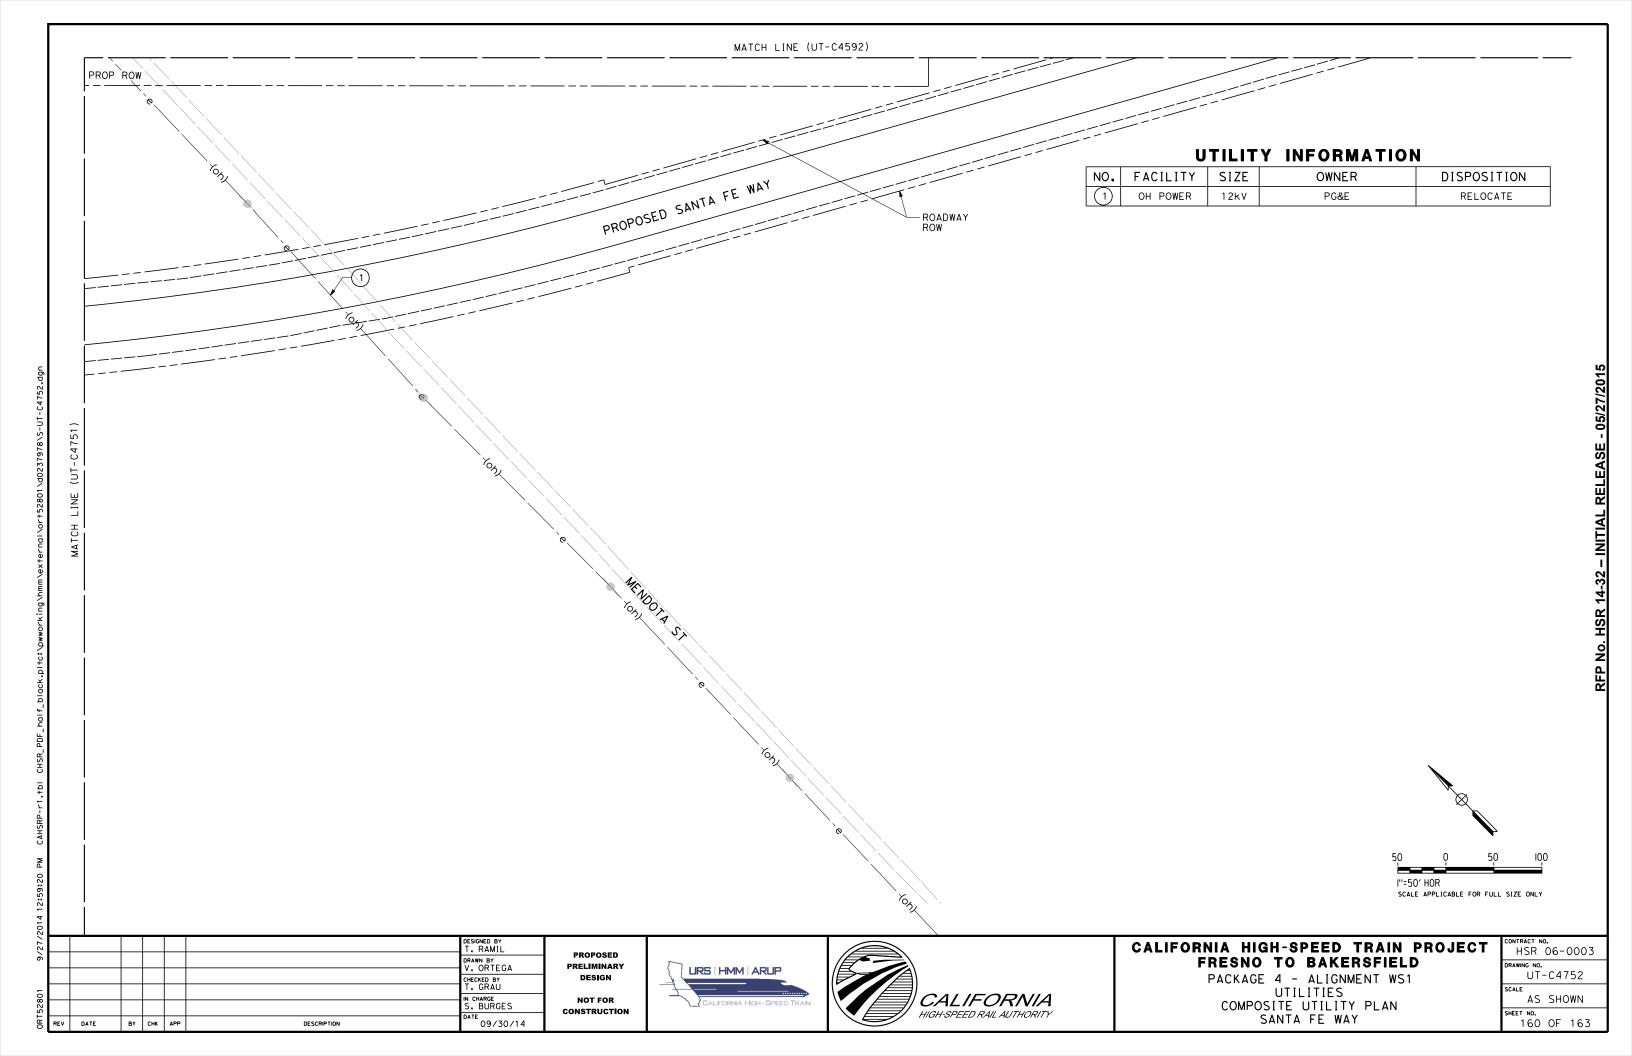

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ZONE	COUNTY	HST ALIGN	EASTING	NORTHING	POINT ID	STA #	PROPOSED FACILITY (INTERNAL WIDTH x INTERNAL HEIGHT)	PROPOSED/ EXISTING FEATURE CROSSED	CROSSING ANGLE (CLOCKWISE FROM NORTH)	ROW WIDTH WEST OF CL (FT)	ADDITIONAL DIST. EACH SIDE (FT)	TOTAL LENGTH OF CHANNEL SPANNED BY CULVERT (FT)	EXISTING ELEVATION (OF INV)	PROPOSED ELEVATION (OF TRACK)	DISTANCE TO TOP OF RAIL (FT)
Z4	TUL	A 1	6441338.852	1811284.899	A1-43	4444+90	10'x3' RCBC	WILDLIFE CROSSING STRUCTURE	90.00	60	0	120	214.59	224.85	10.27
Z4	TUL	A1	6441465.176			4460+70	10'x3' RCBC	WILDLIFE CROSSING STRUCTURE	90.00	60	0	120	216.39	225.82	9.43
Z4	TUL	A 1	6441610.275			4476+50	10'x3' RCBC	WILDLIFE CROSSING STRUCTURE	90.00	60	0	120	217.85	226.78	8.93
Z5	KER	A 1	6441806.659			4492+30	10'x3' RCBC	WILDLIFE CROSSING STRUCTURE	90.00	60	0	120	218.86	227.74	8.88
Z5	KER	A 1	6442058.118			4508+10	10'x3' RCBC	WILDLIFE CROSSING STRUCTURE	90.00	60	0	120	218.45	228.7	10.25
<u>Z5</u>	KER	A1	6442366.463			4523+90	10'x3' RCBC	WILDLIFE CROSSING STRUCTURE	90.00	60	0	120	218.38	229.67	11.29
<u>Z5</u>	KER	A1	6442726.562			4539+70	10'x3' RCBC	WILDLIFE CROSSING STRUCTURE	90.00	60	0	120	219.65	230.73	11.08
<u>Z5</u>	KER	A1	6443141.237			4555+50	10'x3' RCBC	WILDLIFE CROSSING STRUCTURE	90.00	60	0	120	223.05	233.01	9.96
Z5	KER	A1	6443609.828			4571+30	10'x3' RCBC	WILDLIFE CROSSING STRUCTURE	90.00	60	0	120	225.1	235.49	10.39
Z5	KER	A1	6444128.111			4587+10	10'x3' RCBC	WILDLIFE CROSSING STRUCTURE	90.00	60	0	120	225.89	237.97	12.07
Z5	KER	A1	6444703.885			4602+90	10'x3' RCBC	WILDLIFE CROSSING STRUCTURE	90.00	60	0	152	229.03	240.45	11.42
Z5	KER	A1	6445326.451			4618+70	10'x3' RCBC	WILDLIFE CROSSING STRUCTURE	90.00	60	0	152	232.68	242.92	10.24
Z5	KER	A1	6446001.435			4634+50	10'x3' RCBC	WILDLIFE CROSSING STRUCTURE	90.00	60	0	120	235.24	245.31	10.06
Z5	KER	A 1	6446724.858			4650+30	10'x3' RCBC	WILDLIFE CROSSING STRUCTURE	90.00	70	0	172	234.88	249.66	14.78
Z5 Z5	KER KER	A 1	6447212.208			4660+34 4668+13	10'x3' RCBC 16'x12' DBL RCBC	WILDLIFE CROSSING STRUCTURE  UNNAMED CANAL	90.00	70 85	25	140 220	236.96	254.51 258.15	17.56 14.25
Z5	KER	A1	6448113.554		A1-58	4678+00			_	73	0	146	243.9	258.13	
Z5	KER	A1	6448595,722			4687+04	10'x3' RCBC 10'x3' RCBC	VERNAL POOL/ WILDLIFE CROSSING STRUCTURE  VERNAL POOL/ WILDLIFE CROSSING STRUCTURE	90.00	73	0	146	240.83	256.01	17.18
Z5	KER	A1	6448903.372			4692+60	10'x3' RCBC	VERNAL POOL/ WILDLIFE CROSSING STRUCTURE	90.00	60	0	120	243.62	254.95	11.33
Z5	KER	A1	6449461.318			4702+50	10'x3' RCBC	WILDLIFE CROSSING STRUCTURE	90.00	60	0	120	245.47	254.95	9.46
Z5	KER	A1	6450795.568			4725+00	5'x3' RCBC	PERIODIC HYDRAULIC RELIEF	90.00	60	0	120	249.05	260.06	11.01
Z5	KER	A1	6451322.516			4733+50.00	10'x3' RCBC	WILDLIFE CROSSING STRUCTURE	90.00	60	0	120	249.05	260.06	11.01
Z5	KER	A1		1783508.007		4749+00	10'x3' RCBC	WILDLIFE CROSSING STRUCTURE	90.00	60	0	120	251.89	262.62	10.73
Z5	KER	A1	6453422.238			4767+00	10'x3' RCBC	WILDLIFE CROSSING STRUCTURE	90.00	60	0	120	254.96	265.18	10.22
Z5	KER	A 1	6454213.198			4780+00.00	10'x3' RCBC	WILDLIFE CROSSING STRUCTURE	90.00	60	0	120	256.91	267.74	10.83
Z5	KER	A1		1779813.699		4795+50.00	10'x3' RCBC	WILDLIFE CROSSING STRUCTURE	90.00	60	0	120	260.31	270.3	10.00
Z5	KER	A 1	6455916.557			4809+88.60	10'x4' RCBC	FLOODPLAIN DRAINAGE	90,00	60	0	120	263.06	272.82	9.75
Z5	KER	Α1	6455949.563			4810+50.00	10'x3' RCBC	WILDLIFE CROSSING STRUCTURE	90.00	60	0	120	263.41	272.93	9.52
Z5	KER	A1	6456191.234			4815+00	10'x4' RCBC	FLOODPLAIN DRAINAGE	90.00	60	0	120	263.54	273.82	10.28
Z5	KER	A 1	6456455.218	1777761.962	A1-72	4820+00	10'x4' RCBC	FLOODPLAIN DRAINAGE	90.00	60	0	120	264.56	274.8	10.24
Z5	KER	Α1	6456714.578	1777334.506	A1-73	4825+00	10'x4' RCBC	FLOODPLAIN DRAINAGE	90.00	60	0	120	265.1	275.78	10.67
Z5	KER	Α1	6456816.891	1777162.699	A1-74	4827+00	10'x3' RCBC	WILDLIFE CROSSING STRUCTURE	90.00	60	0	120	265.69	276.17	10.48
Z5	KER	Α1	6456969.126	1776904.066	A1-75	4830+00	10'x4' RCBC	FLOODPLAIN DRAINAGE	90.00	60	0	120	266.23	276.76	10.53
Z5	KER	Α1	6457218.873			4835+00	10'x4' RCBC	FLOODPLAIN DRAINAGE	90.00	60	0	120	267.13	277.74	10.60
Z5	KER	A 1	6457463.846			4840+00	10'x4' RCBC	FLOODPLAIN DRAINAGE	90.00	60	0	120	268.35	278.72	10.36
Z5	KER	A1	6457560.373			4842+00	10'x3' RCBC	WILDLIFE CROSSING STRUCTURE	90.00	60	0	120	268.5	279.11	10.61
Z5	KER	A1	6457703.89			4845+00	10'x4' RCBC	FLOODPLAIN DRAINAGE	90.00	60	0	120	268.72	279.7	10.98
Z5	KER	A 1	6457939.133			4850+00	10'x4' RCBC	FLOODPLAIN DRAINAGE	90.00	60	0	120	269.97	280.68	10.70
Z5	KER	A 1	6458008.584			4851+50.00	10'x3' RCBC	WILDLIFE CROSSING STRUCTURE	90.00	60	0	120	270.18	280.97	10.80
Z5	KER	Α1	6458169.368			4855+00	10'x4' RCBC	FLOODPLAIN DRAINAGE	90.00	60	0	151	270.79	281.66	10.87
Z5	KER	A 1	6458395.088			4860+00	10'x4' RCBC	FLOODPLAIN DRAINAGE	90.00	60	0	151	271.46	282.64	11.18
<u>Z5</u>	KER	A1		1773838.975		4864+74.50	10'x4' RCBC	FLOODPLAIN DRAINAGE	90.00	60	0	151	272.11	283.57	11.46
Z5	KER	A1	6458701.615			4867+00	10'x3' RCBC	WILDLIFE CROSSING STRUCTURE	90.00	60	0	151	272.46	284.01	11.55
Z5	KER	A1	6458822.777			4869+82.20	10'x4' RCBC	FLOODPLAIN DRAINAGE	90.00	60	0	151	272.89	284.56	11.67
Z5	KER	A1	6459033.899			4874+83.67	10'x4' RCBC	FLOODPLAIN DRAINAGE	90.00	60	0	151	273.48	285.55	12.06
Z5	KER	A 1	6459245.77	1//2455.3/3	A1-88	4880+00	10'x4' RCBC	FLOODPLAIN DRAINAGE	90.00	60	0	120	274.82	286.51	11.69

#### NOTES:

1. TABLE BASED ON RECORD SET 15% DESIGN SUBMISSION, FRESNO TO BAKERSFIELD, HYDROLOGY, HYDRAULICS AND DRAINAGE REPORT, DECEMBER 2013, APPENDIX B, HYDRAULIC CROSSING POINTS. UPDATED TO REFLECT DRAWING UPDATES INCLUDED IN DRAFT 15% DESIGN SUBMISSION, FRESNO TO BAKERSFIELD, ALIGNMENT PLANS, APRIL 2014, ROADWAY AND GRADE SEPARATION PLANS, APRIL 2014 AND STRUCTURE PLANS, DECEMBER 2013.

_		_	_	_		T	
						DESIGNED BY T. RAMIL	PROPOSER
						DRAWN BY V. ORTEGA	PROPOSED PRELIMINARY
						CHECKED BY T. GRAU	DESIGN
						IN CHARGE S. BURGES	NOT FOR CONSTRUCTION
REV	DATE	ВΥ	СНК	APP	DESCRIPTION	DATE 09/30/14	CONSTRUCTION





### CALIFORNIA HIGH-SPEED TRAIN PROJECT FRESNO TO BAKERSFIELD

PACKAGE 4 UTILITIES COMPOSITE UTILITY PLAN HH&D FACILITY SCHEDULE (SHEET 1 OF 3)

CONTRACT NO.
HSR 06-0003
DRAWING NO.
UT-Y4505
SCALE
NO SCALE

SHEET NO. 161 OF 163

5								
// 7							DESIGNED BY T. RAMIL	
'n							DRAWN BY V. ORTEGA	
_							CHECKED BY T. GRAU	
22801							IN CHARGE S. BURGES	
5	REV	DATE	ВΥ	СНК	APP	DESCRIPTION	09/30/14	

PROPOSED
PRELIMINARY
DESIGN
NOT FOR

CONSTRUCTION





## CALIFORNIA HIGH-SPEED TRAIN PROJECT FRESNO TO BAKERSFIELD

PACKAGE 4
UTILITIES
COMPOSITE UTILITY PLAN
HH&D FACILITY SCHEDULE (SHEET 2 OF 3)

TOTAL

1	CONTRACT NO.
	HSR 06-0003
	DRAWING NO.
	UT-Y4506
	SCALE
	NO SCALE
	A

162 OF 163

ZONE	COUNTY	HST ALIGN	EASTING	NORTHING	POINT ID	STA #	PROPOSED FACILITY (INTERNAL WIDTH × INTERNAL HEIGHT)	PROPOSED/ EXISTING FEATURE CROSSED	CROSSING ANGLE (CLOCKWISE FROM NORTH)	ROW WIDTH WEST OF CL (FT)	ADDITIONAL DIST. EACH SIDE (FT)	TOTAL LENGTH OF CHANNEL SPANNED BY CULVERT (FT)	EXISTING ELEVATION (OF INV)		
Z5	KER	WS1				5425+87 <b>,</b> 196′R†	15'x11' DBL RCBC	CULVERT UNDER SYSTEMS ROAD, 9-22	N/A	N/A	N/A	50	N/A	N/A	N/A
Z5	KER	WS1		2420678.837		5428+85	15'x11' DBL RCBC	UNNAMED CANAL, 9-22	90.00	68	25	186	315.69	324.46	8.77
Z5	KER	WS1		2415065.186		5485+00	14'x6' RCBC	CULVERT UNDER EXISTING BNSF	90.00	68	0	136	319.78	330.91	11.14
Z5	KER	WS1		2413897.793		5496+67	8'x4' RCBC	CULVERT UNDER EXISTING BNSF	90.00	68	0	136	318.24	332.26	14.01
Z5	KER	WS1		2392079.99		5715+73	8'x4' RCBC	CULVERT UNDER ADJACENT ROAD	N/A	68	0	136	N/A	N/A	N/A
Z5	KER	WS1		2389171.541		5747+00	5'x3' RCBC	PERIODIC HYDRAULIC RELIEF	90.00	68	0	136	338.46	349.79	11.33
Z5	KER	WS1	6168704.02	2386970.319	WS1-07	5772+00	5'x3' RCBC	PERIODIC HYDRAULIC RELIEF	90.00	68	0	136	341.97	353.04	11.06
Z5	KER	WS1		2371408.814		5985+00	5'x3' RCBC	PERIODIC HYDRAULIC RELIEF	90.00	40	0	80	347.96	355.57	7.61
Z5	KER	WS1		2369470.671		6012+00	5'x3' RCBC	UNKNOWN (EQUIVALENT TO ADJACENT BNSF)	90.00	40	0	80	346.43	355.57	9.14
Z5	KER	WS1		2360137.255		6138+18	4'x3' RCBC	CULVERT UNDER EXISTING BNSF	90.00	50	0	100	341.54	364.38	22.83
Z5	KER	WS1		2358090.056		6167+44	5'x4' RCBC	CULVERT UNDER EXISTING BNSF	90.00	N/A	N/A	120	337.44	346.62	9.18
Z5	KER	WS1		2357556.973		6175+00	5'x3' RCBC	PERIODIC HYDRAULIC RELIEF	90.00	N/A	N/A	120	337.23	346.36	9.13
Z5	KER	WS1	6196899.172	2356856.6	WS1-13	6185+00	5'x3' RCBC	PERIODIC HYDRAULIC RELIEF	90.00	N/A	N/A	120	336.61	346.06	9.45
Z5	KER	WS1		2356335.639		6192+41	5'x4' RCBC	CULVERT UNDER EXISTING BNSF	90.00	N/A	N/A	120	336.21	345.83	9.62
Z5	KER	WS1	6197965.969	2355800.131	WS1-15	6200+00	5'x3' RCBC	PERIODIC HYDRAULIC RELIEF	90.00	N/A	N/A	200	335.93	345.61	9.68
Z5	KER	WS1	6200444.963	2353264.658	WS1-16	6235+45	5'x4' RCBC	CULVERT UNDER EXISTING BNSF	90.00	N/A	N/A	206	337	344.93	7.93

DESIGNED BY
T, RAMIL
DRAWN BY
V. ORTEGA
CHECKED BY
T. GRAU
IN CHARGE
S. BURGES
DATE
REV DATE BY CHK APP
DESCRIPTION

DESCRIPTION

DESCRIPTION

DESCRIPTION

DESCRIPTION

DESCRIPTION

DESCRIPTION

DESCRIPTION

PROPOSED
PRELIMINARY
DESIGN
NOT FOR

CONSTRUCTION





# CALIFORNIA HIGH-SPEED TRAIN PROJECT FRESNO TO BAKERSFIELD

PACKAGE 4
UTILITIES
COMPOSITE UTILITY PLAN
HH&D FACILITY SCHEDULE (SHEET 3 OF 3)

T	CONTRACT NO. HSR 06-0003
	DRAWING NO. UT-Y4507
	NO SCALE

NO SCALE

SHEET NO.

163 OF 163